

DATE: 11/17/2025

GROUP

Architectural Narrative Letter

PROJECT: Beacon Hill (Boston), MA (48100R027235)

250 Cambridge Street Beacon Hill, MA 02114

To Whom it May Concern:

The proposed Chase Bank is located at 250 Cambridge Street, Boston, Suffolk County Massachusetts 02114. The proposed Chase Bank is located within a one (1) 7-story building comprising of ground floor commercial space with residential units above. The existing ground-level commercial space, historically operated as a TD Bank, is presently vacant. The proposed project aims to construct a 2,860 square foot Chase Bank with a 24-hour vestibule.

Below is a summary of the exterior work that is being proposed by the new Chase Bank:

- <u>Signage</u>: The existing TD Bank signage has already been removed. The existing blade sign bracket will remain as existing. A new Chase Bank prototypical sign will be installed onto the existing blade sign bracket. This will be the sole Chase Bank sign on the exterior of the building.
- <u>Existing Awnings</u>: The (4) existing TD Bank awnings will be removed from the exterior façade. The exterior wall surface will be patched if needed for the awning removal.
- <u>Trash Area Return Air Louver</u> There is an existing trash area located off Anderson Street. The project is proposing the relocation of this louver to be integrated into the new storefront system on Cambridge Street. The existing louver will be removed and capped. The relocation of the existing return air louver is to help minimize the smell from the trash area within the proposed Chase Bank.
- <u>Storefront System</u> The existing space includes (5) sections of exterior storefront system. The project is proposing to replace all (5) of these sections be replaced. The new storefront sections will mimic the existing in finish and color. On Cambridge Steet, the left most storefront will include (2) sections for a relocated air louver that was originally located in the existing trash area off Anderson Street.
- <u>Exterior Cameras</u> The Chase security team is proposing (1) wall mounted security camera to be on both Cambridge and Anderson Steet. These cameras will be located between the storefront systems. There will also be (1) wall mounted camera in the main entry alcove.
- <u>Exterior Materials</u> The existing stone will be cleaned and power-washed near the end of the construction process.
- <u>Lighting</u> The project is proposing to add (2) ceiling surface mounted emergency light fixtures at the main entry's alcove. This is to help meet the current life safety codes, as well as to provide safety to the Chase Bank customers.

Sincerely,
Shane Healey, AIA
Core States Group, Inc.
shealey@core-states.com







RECOMMENDED IMPROVEMENTS

A. RECONSTRUCT THE EXISTING ENTRANCE LANDING OR RIGHT-OF-WAY TO MEET A MAXIMUM OF 2% SLOPE IN ALL DIRECTIONS AND REMOVE THE EXISTING TRIPPING HAZARD WITHIN THE ENTRANCE LANDING

ADDITIONAL RECOMMENDATIONS

I. THE CONTRACTOR SHALL ENSURE THAT THE BRICK PAVERS SHALL BE PROTECTED DURING CONSTRUCTION ACTIVITIES AND/OR REPLACE ANY DAMAGED PAVERS IN-KIND.



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EXTERIOR ADA



PARCEL ID: 0
250 CAMBRID
CITY OF BOS
SUFFOLK CO

RAWN BY: AB

HECKED BY: GMC

ATE: 05/28/2025

CALE: (H) I" = 20'

SCALE: (H) I" = 20'

ROJECT ID: ITLE:

PROPOSED CONDITIONS

SHEET:

I" = 20'

2 OF 2













NOVEMBER 17, 2025














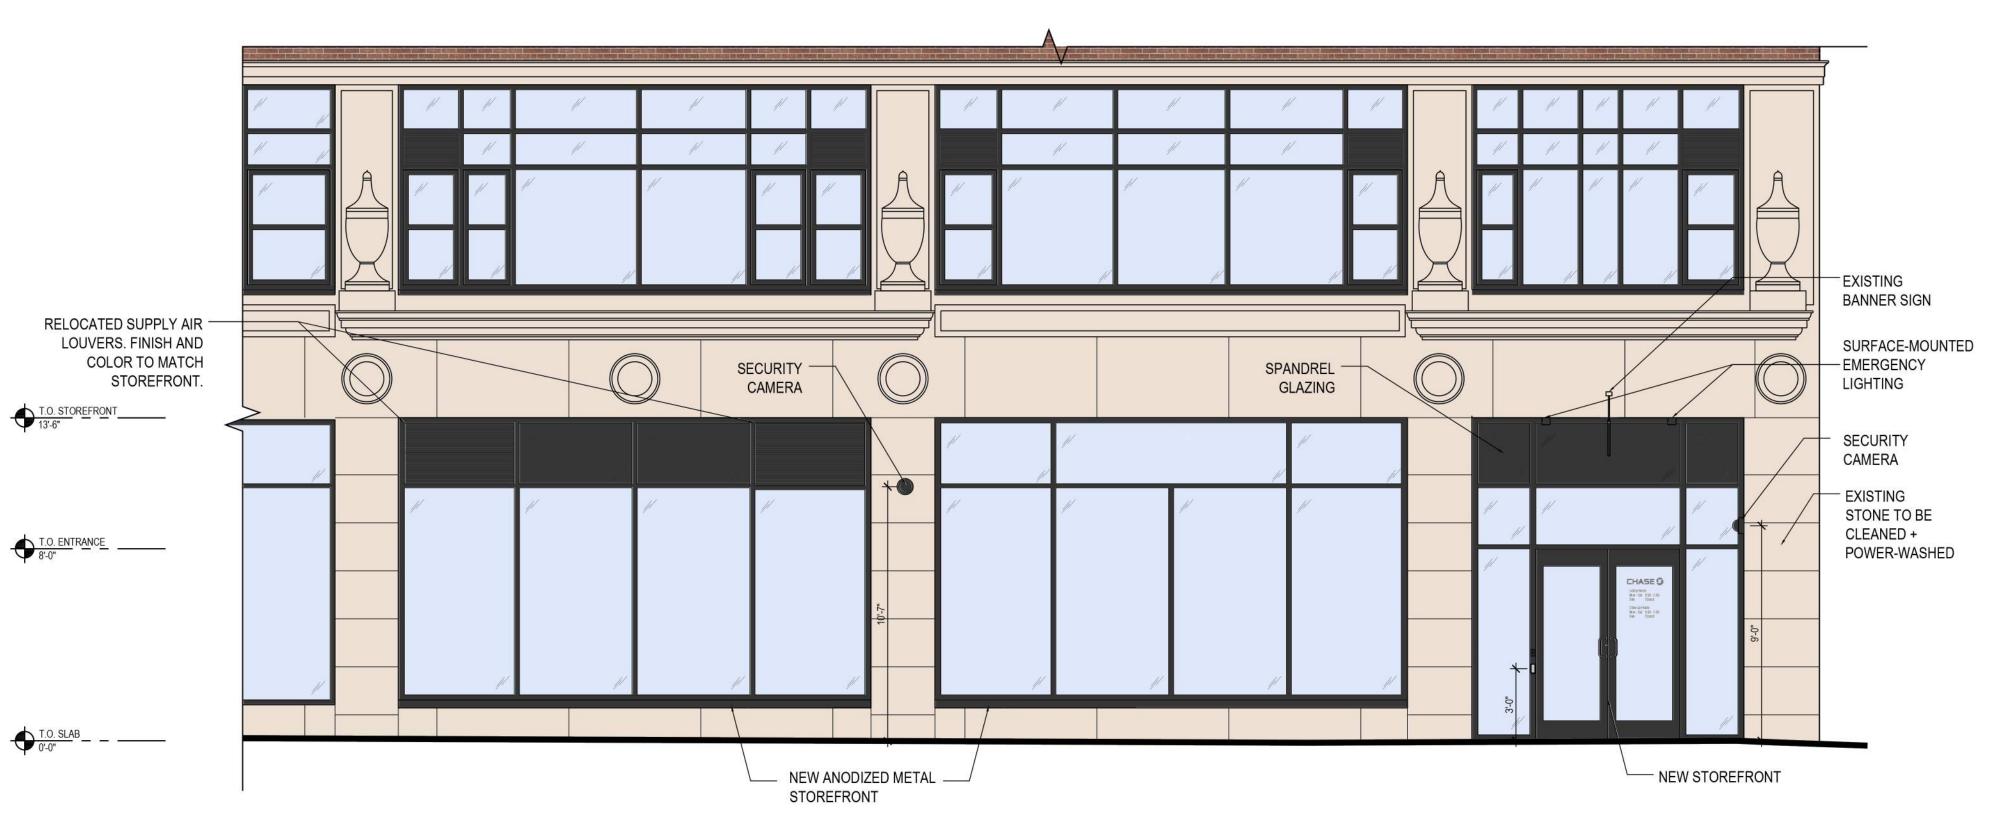








NOVEMBER 17, 2025 SCALE: 1/4" = 1'-0"



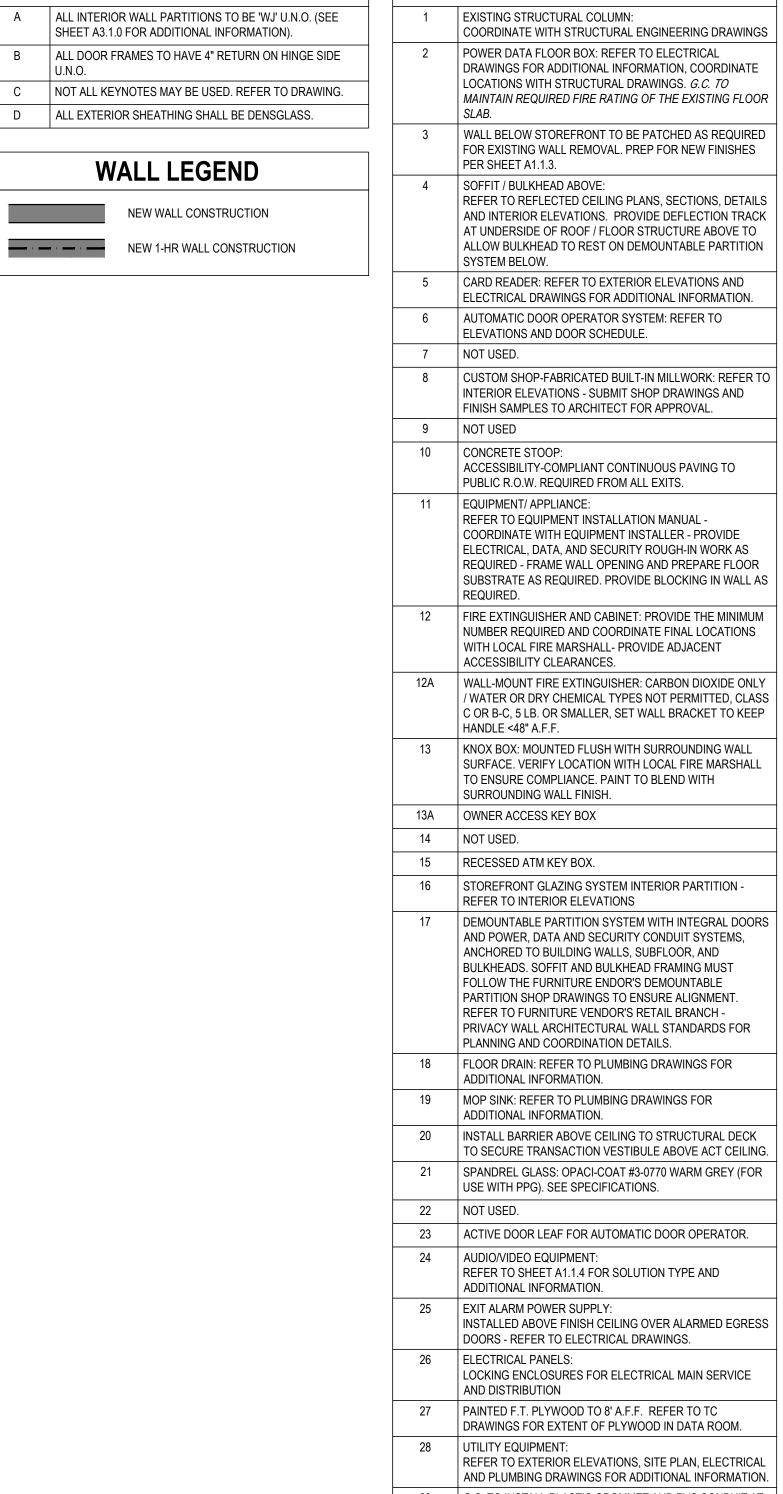

FOR ADDITIONAL INFORMATION.

AND ASSOCIATED EQUIPMENT/DEVICES; NOT PERMITTED IN

DATA ROOM OR AREAS VISIBLE TO CUSTOMERS.

FLOOR PLAN KEYNOTES

GENERAL FLOOR PLAN NOTES

SHEET A3.1.0 FOR ADDITIONAL INFORMATION).

D ALL EXTERIOR SHEATHING SHALL BE DENSGLASS.

NEW 1-HR WALL CONSTRUCTION

WALL LEGEND

NEW WALL CONSTRUCTION

ARCHITECT OF RECORD NOT FOR **CONSTRUCTION** JAMES T. LALLI, AIA, ARCHITECT MASSACHUSETTS LICENSE NO. 32254 HESE DRAWINGS ARE NOT COMPLETE WITHOUT THE SEPARATE TYPE WRITTEN SPECIFICATIONS MANUAL WHICH ARE PART OF THE CONTRACT DOCUMENTS. 29 G.C. TO INSTALL PLASTIC GROMMET AND PVC CONDUIT AT DESCRIPTION ISSUE DATE MANUAL TRANSACTION STATION. REFER TO SHEET A6.10 2025.12.03 PERMIT SET 30 G.C. TO PULL CONDUIT FOR SECURITY CAMERA IN MULLION. FIRE ALARM EQUIPMENT LOCATION: FIRE ALARM CONTROL PANEL, COMMUNICATOR, DOCUMENTATION ENCLOSURE,

NEW JERSEY ARCHITECTURE

CERTIFICATE OF AUTHORIZATION NO. 21AC00109100

AS NOTED PROTOTYPE: DRAWN BY: S.HEALEY CHECKED BY: J.SANCHEZ VERSION: SE_1.00 SHEET TITLE CONSTRUCTION

JPM.25.40653.0


PROJECT INFORMATION

PROJECT NO:

FLOOR PLAN

SHEET NUMBER

A1.1.1

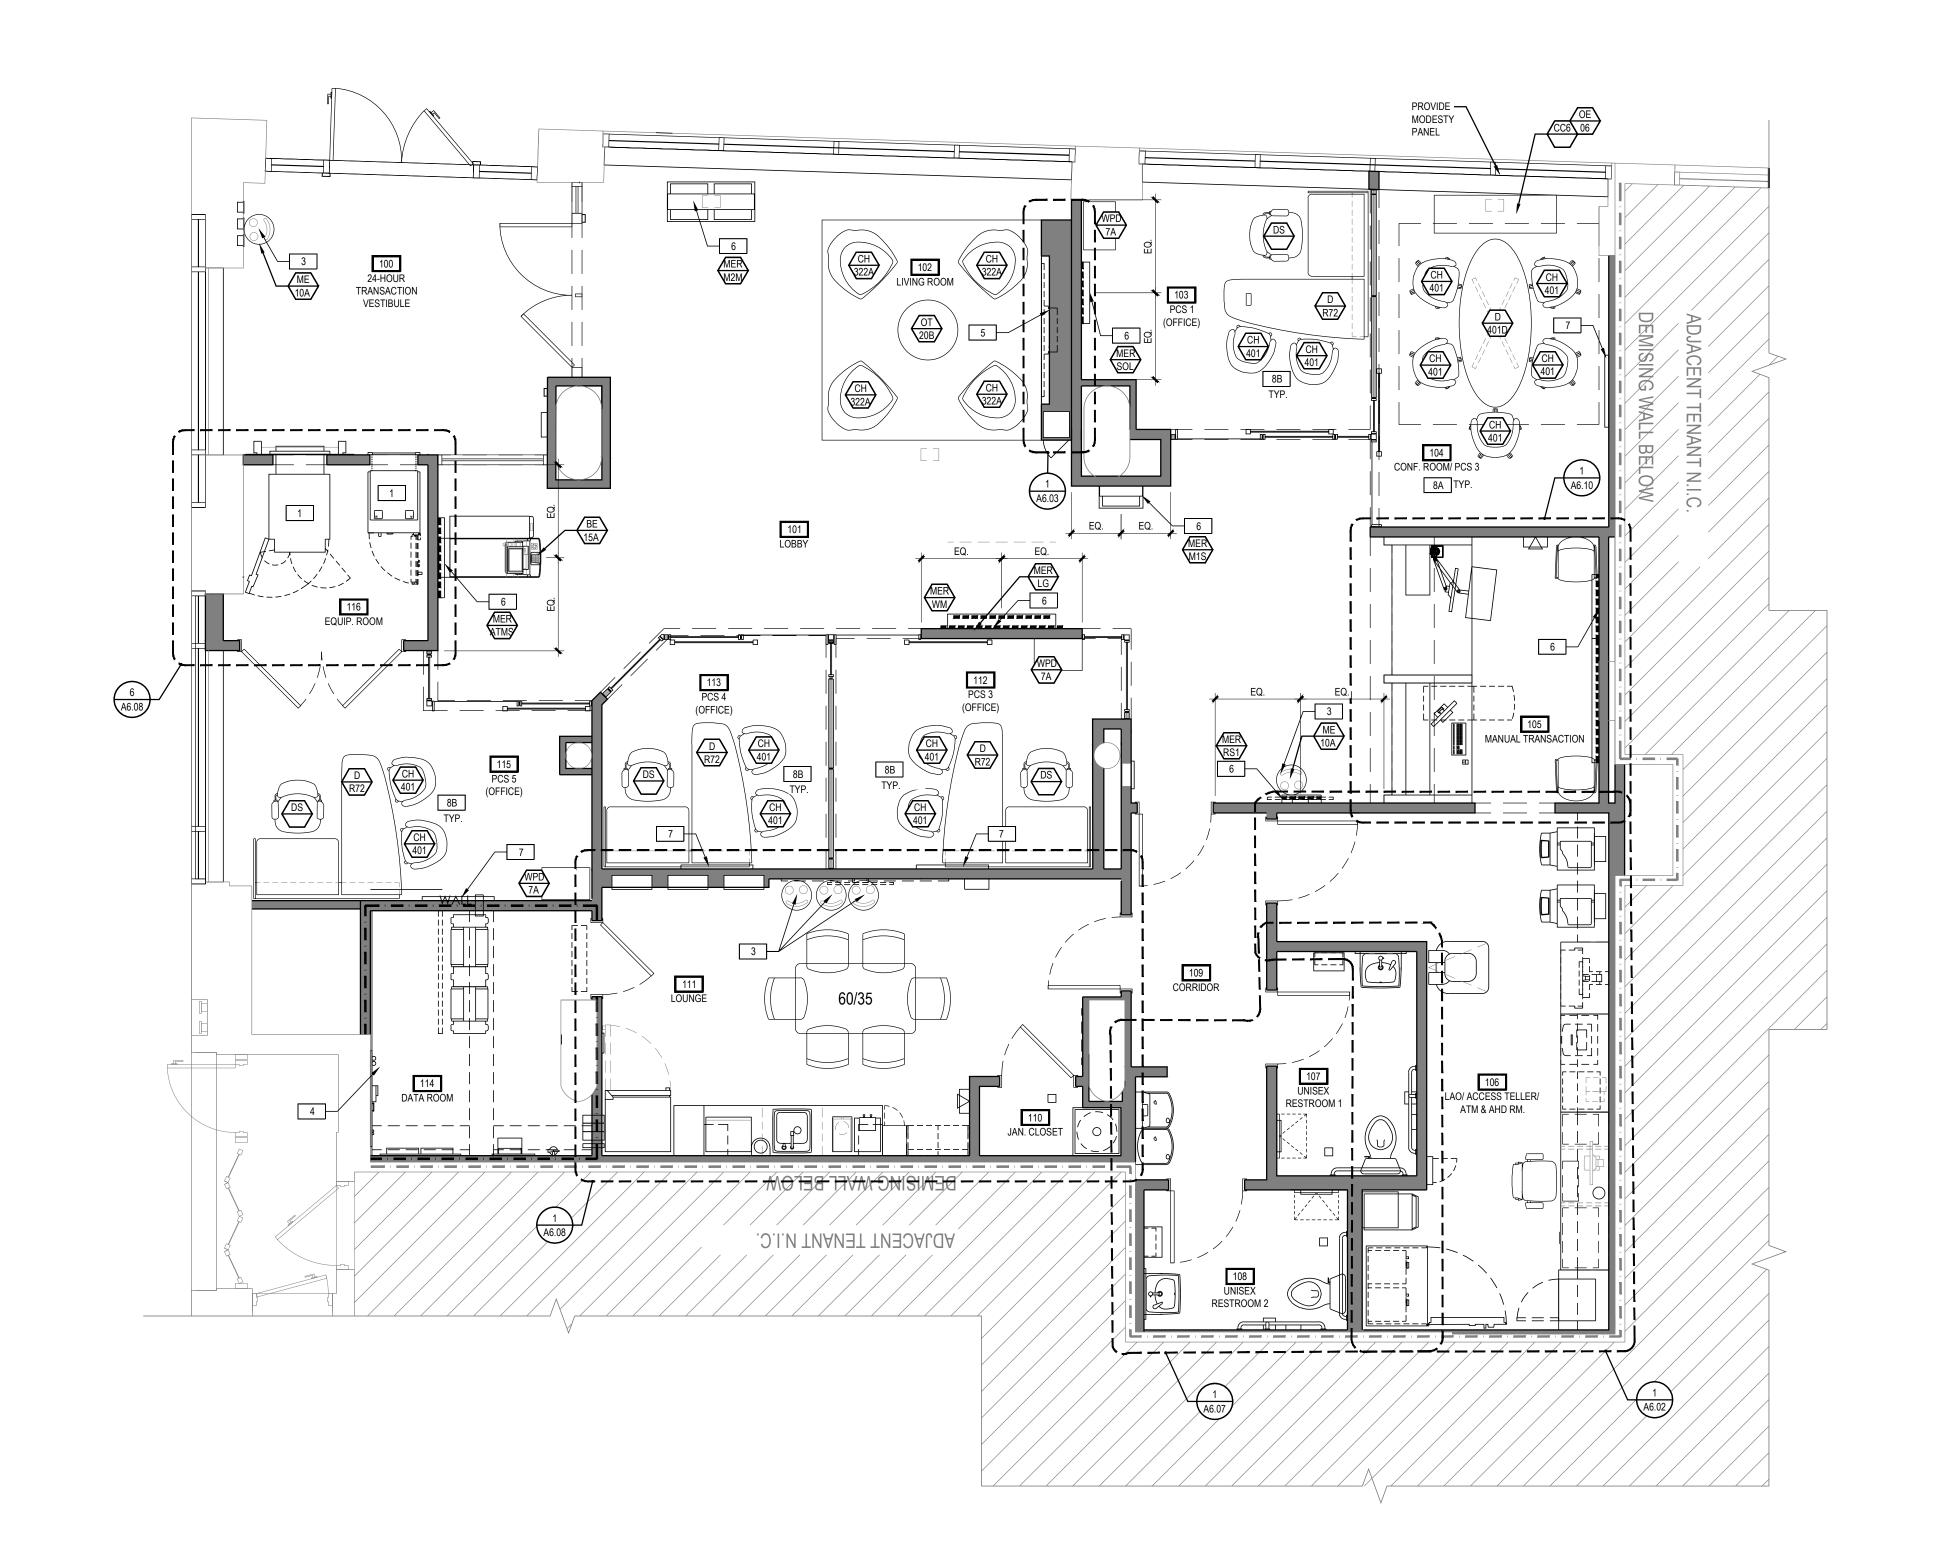





GENERAL FURNITURE & EQUIPMENT NOTES

A GC TO COORDINATE IN FIELD BCM OFFICE LOCATION W/ BRANCH MANAGEMENT FOR LOCATION OF HOLD-UP BUTTON.

B WALL MOUNTED DISPLAYS/ SOLUTIONS:
REFER TO A6 SERIES SHEETS FOR INTERIOR ELEVATIONS AND A6.03, A6.04, & TC DRAWINGS FOR MOUNTING HEIGHTS & NICHE CONSTRUCTION DETAILS (WHERE SHOWN).

FURNITURE & EQUIPMENT KEYNOTES

1 ALL FLOOR-MOUNTED BANK EQUIPMENT WITH 24/7 ACCESS REQUIRES FLOOR SLAB ANCHORS - REFER TO EQUIPMENT INSTALLATION MANUAL

2 NOT USED 3 REFUSE BIN; REFER TO MISCELLANEOUS EQUIPMENT SCHEDULE ON A3.4.3

4 PROVIDE 6" PVC PIPE SECURELY MOUNTED TO WALL FOR FINAL AS-BUILT DRAWINGS; SEE PROJECT MANUAL SECTION 017800 FOR MORE INFORMATION

5 | SOLUTION #3 (75") - WALL MOUNTED DISPLAY MONITOR; SEE GENERAL FURNITURE & EQUIPMENT NOTES.

MERCHANDISING SIGNAGE BY OTHERS; REFER TO ELECTRICAL DRAWINGS AND TC DRAWINGS FOR POWER/DATA REQUIREMENTS. SEE MERCHANDISING FIXTURE SCHEDULE ON A3.5.0. 7 ARTWORK BY OTHERS

8A CONFERENCE CHAIRS ARE TO BE WITH CASTERS.

8B OFFICE GUEST CHAIRS ARE TO BE WITHOUT CASTERS.



CORE STATES

CORESTATES, INC. NEW JERSEY ARCHITECTURE CERTIFICATE OF AUTHORIZATION NO. 21AC00109100

ARCHITECT OF RECORD

NOT FOR CONSTRUCTION

JAMES T. LALLI, AIA, ARCHITECT MASSACHUSETTS LICENSE NO. 32254

THESE DRAWINGS ARE NOT COMPLETE WITHOUT THE SEPARATE TYPE WRITTEN SPECIFICATIONS MANUAL WHICH ARE PART OF THE CONTRACT DOCUMENTS.

ISSUE DATE DESCRIPTION 2025.12.03 PERMIT SET

PROJECT INFORMATION

PROJECT NO: JPM.25.40653.01 AS NOTED 20.7 PROTOTYPE: S.HEALEY DRAWN BY: J.SANCHEZ CHECKED BY: SE_1.00 VERSION: SHEET TITLE

> FURNITURE & EQUIPMENT PLAN

SHEET NUMBER

A1.1.4

EC 97911-281 FEATURES

Features

- Trifab® VersaGlaze® 450 is 4-1/2" (114.3) deep with a 1-3/4" (44.5) sight line
- · Front, Center, Back or Multi-Plane glass applications
- · Flush glazed from either the inside or outside
- Screw Spline, Shear Block, Stick or Continuous Head and Sill fabrication
- SSG / Weatherseal option
- 1/8" (3.2), 1/4" (6.4), or 3/8" (9.5) infill options
- Permanodic® anodized finishes option
- Painted finishes in standard and custom choices

Optional Features

• Profit\$Maker® Plus die sets available

Product Applications

- Storefront, Ribbon Window or Punched Openings
- Single-span
- Integrated entrance framing allowing Kawneer standard entrances or other specialty entrances to be incorporated
- Kawneer windows or GLASSvent® Windows for Storefront Framing are easily incorporated

For specific product applications, consult your Kawneer representative.




PICTORIAL VIEW (CENTER)

The split vertical in the Screw Spline system allows a frame to be


installed from unitized assemblies. Screws are driven through the back of the verticals into splines extruded in the horizontal framing members. The Individual units are then snapped together to form a complete frame.




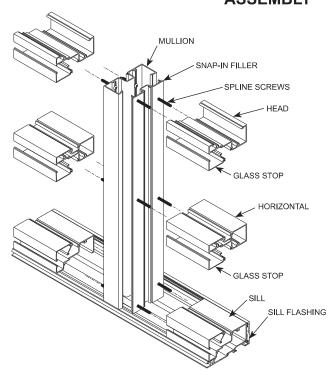


The Shear Block system of fabrication allows a frame to be preassembled as a single unit. Horizontals are attached to the verticals with shear blocks.

SHEAR BLOCK **ASSEMBLY**

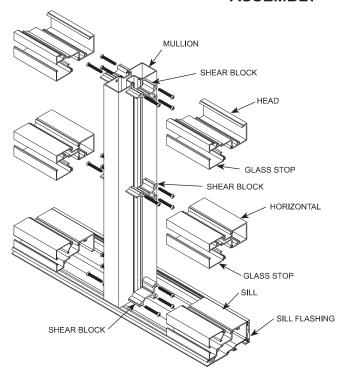

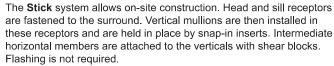

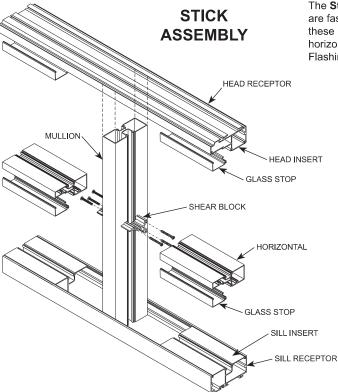

If the end reaction of the mullion (mullion spacing (ft.) times height (ft.) times specified wind load (psf) divided by two) is more than 500 lbs., the optional mullion anchors must be used. (See page 14)




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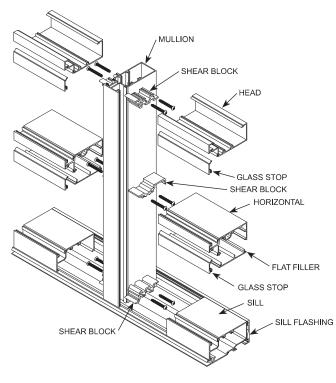
PICTORIAL VIEW (FRONT)

The split vertical in the Screw Spline system allows a frame to be installed from unitized assemblies. Screws are driven through the back of the verticals into splines extruded in the horizontal framing members. The Individual units are then snapped together to form a complete frame


The Shear Block system of fabrication allows a frame to be preassembled as a single unit. Horizontals are attached to the verticals with shear blocks.



SHEAR BLOCK **ASSEMBLY**

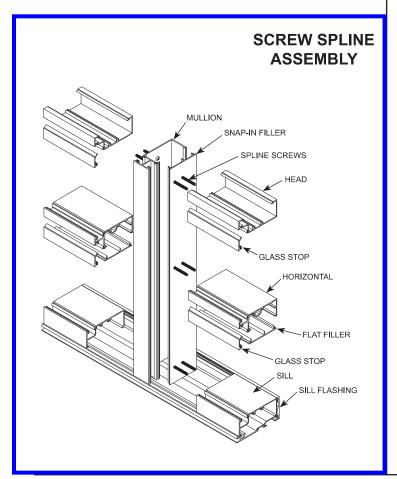

STICK ASSEMBLY

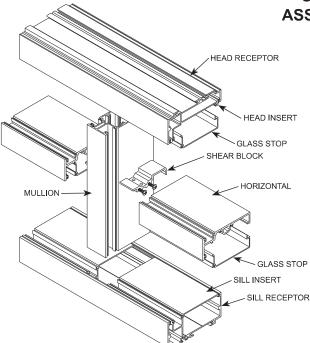

The Stick system allows on-site construction. Head and sill receptors are fastened to the surround. Vertical mullions are then installed in these receptors and are held in place by snap-in inserts. Intermediate horizontal members are attached to the verticals with shear blocks. Flashing is not required.

If the end reaction of the mullion (mullion spacing (ft.) times height (ft.) times specified wind load (psf) divided by two) is more than 500 lbs., the optional mullion anchors must be used. (See page 31)

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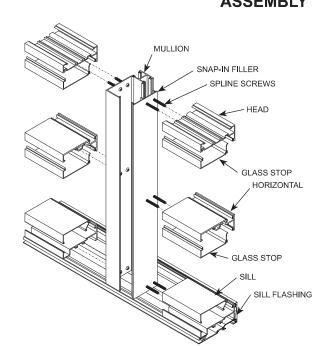
a building and safety codes governing the design and use of Kawneer , such as glazed entrance, window, and curtain wall products, vary widely, does not control the selection of product configurations, operating

PICTORIAL VIEW (BACK)

THE SPLIT VERTICAL IN THE SCREW SPLINE SYSTEM ALLOWS A FRAME TO BE INSTALLED FROM UNITIZED ASSEMBLIES. SCREWS ARE DRIVEN THROUGH THE BACK OF THE VERTICALS INTO SPLINES EXTRUDED IN THE HORIZONTAL FRAMING MEMBERS. THE INDIVIDUAL UNITS ARE THEN SNAPPED


TOGETHER TO FORM A COMPLETED FRAME.

SCREW SPLINE ASSEMBLY




HE SHEAR BLOCK SYSTEM OF FABRICATION ALLOWS A FRAME O BE PRE-ASSEMBLED AND INSTALLED AS A SINGLE UNIT. IORIZONTALS ARE ATTACHED TO THE VERTICALS WITH SHEAR

SHEAR BLOCK ASSEMBLY

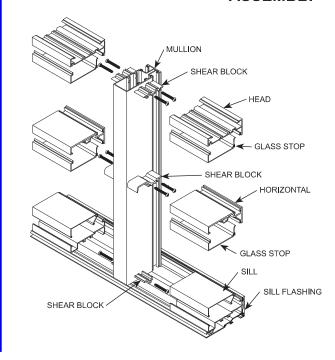



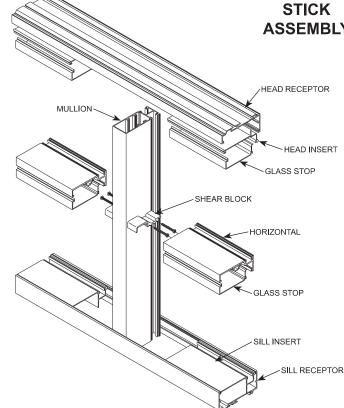

The Stick system allows on-site construction. Head and sill receptors are fastened to the surround. Vertical mullions are then installed in these receptors and are held in place by snap-in inserts. Intermediate horizontal members are attached to the verticals with shear blocks. Flashing is not required.

NOTE:

If the end reaction of the mullion (mullion spacing (ft.) times height (ft.) times specified wind load (psf) divided by two) is more than 500 lbs., the optional mullion anchors must be used. (See page 41)





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PICTORIAL VIEW (OPTIONAL 450 SILL ASSEMBLIES USING FILLER AND REGLET SILL FLASHING CLIPS)

SCREW SPLINE ASSEMBLY


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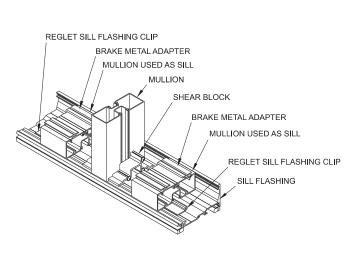


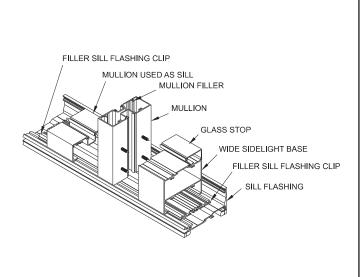

SHEAR BLOCK ASSEMBLY

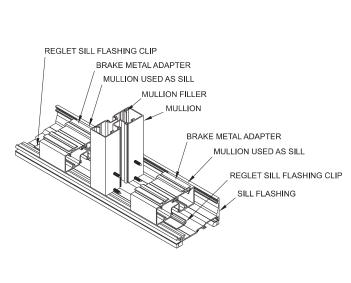The Shear Block system of fabrication allows a frame to be pre-assembled as a single unit. Horizontals are attached to the verticals with shear blocks.



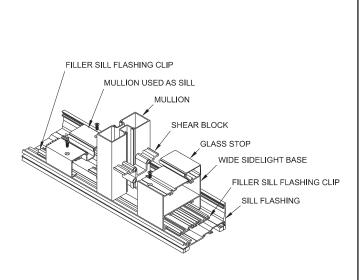

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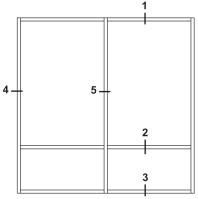
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BASIC FRAMING DETAILS (CENTER - Outside Glazed)


EC 97911-281


Additional information and CAD details are available at www.kawneer.com



ELEVATION IS NUMBER KEYED TO DETAILS


SCREW SPLINE 1-3/4" (44.5) TYP 450CG001 450CG001 450CG002 5 VERTICAL **JAMB**

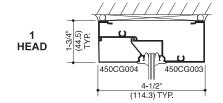


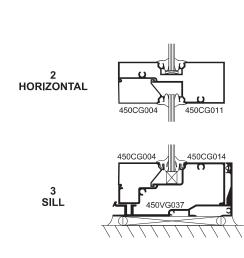



* HP Sill Flashing shown with optional gasket.

SHEAR BLOCK

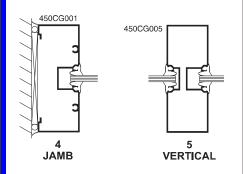

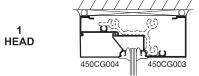


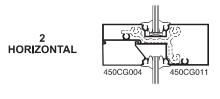


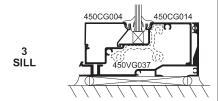



* HP Sill Flashing shown with optional gasket.

STICK

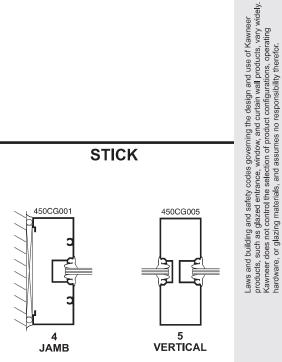

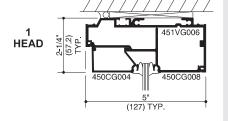

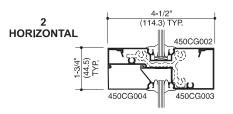

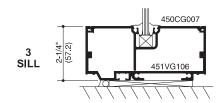

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Additional information and CAD details are available at www.kawneer.com


ELEVATION IS NUMBER KEYED TO DETAILS

SHEAR BLOCK


Laws and building and safety codes governing the design and use of Kawneer products, such as glazade entrannee, window, and ourbain wall products, vary widely. Common and configurations, operating hardware, or glazing materials, and assumes or esponsibility therefor.


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* HP Sill Flashing shown with optional gasket.



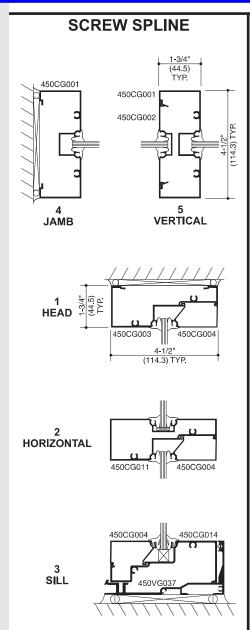


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TRIFAB® VERSAGLAZE® 450 FRAMING INCORPORATING KAWNEER "190" DOORS.

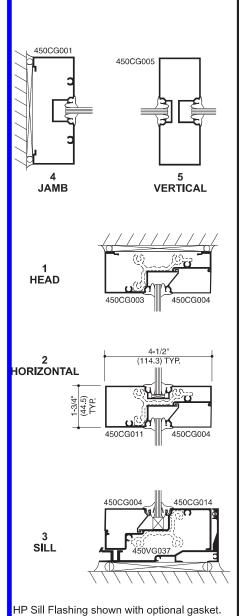NOTE: OTHER TYPES OF KAWNEER DOORS MAY BE USED WITH THIS FRAMING SYSTEM. SEE ENTRANCE DETAILS FOR ADDITIONAL INFORMATION.

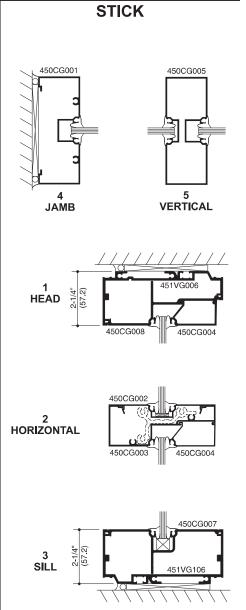



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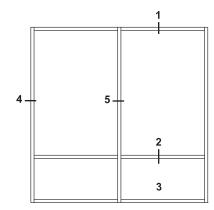
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BASIC FRAMING DETAILS (FRONT - Inside Glazed)

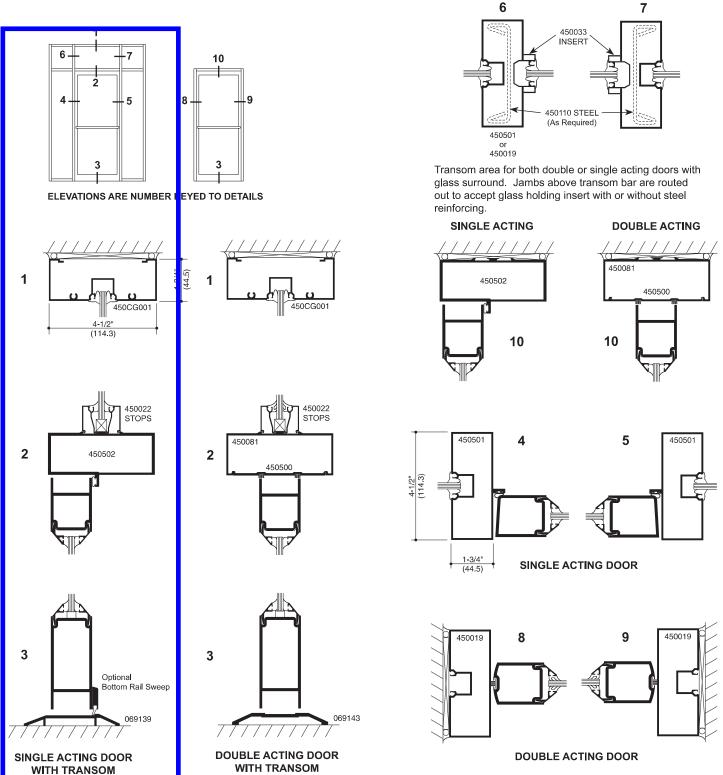
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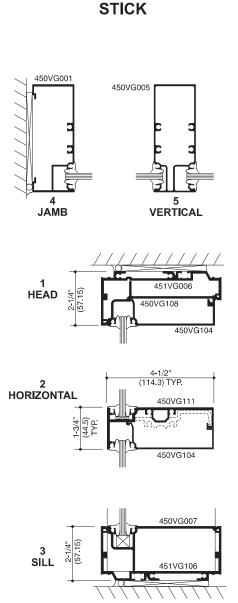


ELEVATION IS NUMBER KEYED TO DETAILS

SCREW SPLINE 450VG001 450VG012 450VG026 5 VERTICAL **JAMB** 450VG104 4-1/2" (114.3) TYP. 450VG111 2 HORIZONTAL 450VG104 450FG014 3 SILL 450VG037

* HP Sill Flashing shown with optional gasket.



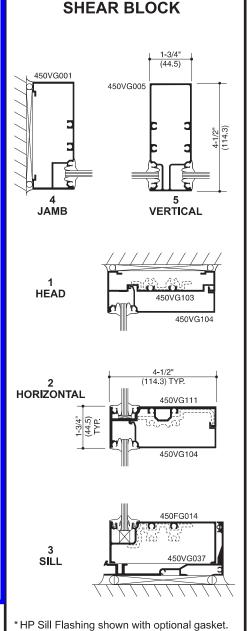

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