


**Left & Rear Elevation** 

**Rear Elevation** 

# Boston Landmarks Commission Highland Park Architectural Conservation Commission

40 Linwood Street, Roxbury, MA 02119
Existing 2 family renovation, addition and lot combination

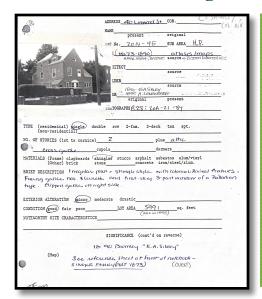

### PROJECT DESCRIPTION:

This project involves the full renovation of an existing two-family dwelling, combined with the construction of a new two-story addition and the consolidation of adjoining lots to optimize the site. The scope of work includes demolition, excavation, and new structural framing, along with exterior upgrades such as roofing, siding, windows, doors, and decking Interior improvements will feature insulation, drywall, and finish carpentry, supported by modernized plumbing, heating, and HVAC systems. The result will be a code-compliant, energy-efficient, and high-quality residence that enhances livability, strengthens long-term value, and elevates the overall character of the property within the community.

Permit #: ALT1677957


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PE (residential) single d (non-residential)	double row 2-fam. 3-deck ten apt.
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4	_cupoladormers
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TERIALS (Frame) clapboards (Other) brick  IEF DESCRIPTION I rregular acing gable has a lunge. Clipped gable on	shingles stucco asphalt asbestos alum/vinyl stone concrete iron/steel/alum.  plan - Shingle style with colonial Revival featurete and first-style 3- part window of a Pallaright side.
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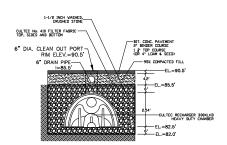
# 319N



### LINWOOD

### STREET




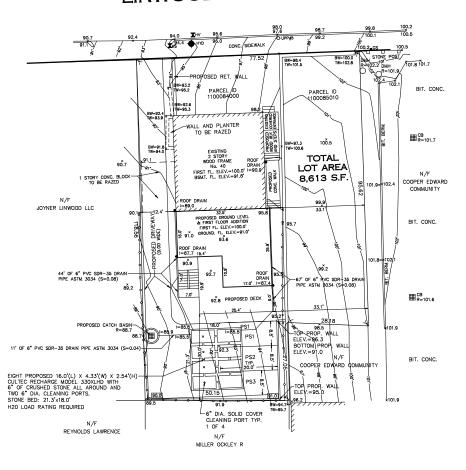

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CULTEC RECHARGER 330XLHD CHAMBER SYSTEM
TYPICAL CROSS SECTION DETAIL


#### CATCH BASIN BOSTON WATER AND SEWER COMMISSION

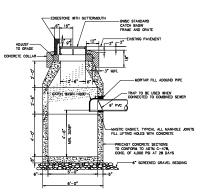

#### INFILTRATION SYSTEM CALCULATIONS

IMPERINOUS AREA = 4.431.3 SO. FT. X 2/12 = 738.6 C.F. TO BE INFILTRATED INFILITRATION BED AREA = 18.00° X 21.32° X 3.54° = 1358.5 C.F. CULTEC PIPE CAPACITY = 7.46 C.F./FT X 64 FT = 477.4 C.F. STONE CAPACITY = 138.5 C.F. - 477.4 C.F. = 881.1 C.F. X 0.3 = 264.3 C.F. TOTAL INFILITRATION CAPACITY = 477.4 C.F. + 264.3 C.F. = 741.7 C.F. > 738.6 C.F. OK.

NOTE: ALL ELEVATIONS ARE ON AN ASSUMED DATUM. TBM-FIRST FLOOR ELEV.=100.0 FT.

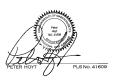

SITE PLAN
SHOWING
PROPOSED ADDITION & RECHARGE SYSTEM
AT
40 LINWOOD STREET
IN
BOSTON (ROX.), MASS.

PREPARED BY: NEPONSET VALLEY SURVEY ASSOC., INC. 95 WHITE STREET QUINCY, MA 02169

SCALE: DATE: SHI APRIL 28, 2025 1"=10' JUNE 25, 2025 1.0

0 5 10 20 30

### Design Review Submission 40 Linwood Street (ALT1677957) / Public Hearing Package

### Good afternoon,

I am submitting this summary and supporting documents for the Highland Park Architectural Commission and Boston Landmarks Commission in connection with the alteration permit for 40 Linwood Street (Permit #ALT1677957). The purpose is to provide a clear sequence of events, from the initial zoning concerns to the present stage, where Landmarks design review is required prior to permit release.

### **Background and Initial Zoning Issue**

The original alteration permit application for 40 Linwood Street was flagged for a side yard setback violation. At that time, the client was in the process of acquiring the adjacent lot at 34 Linwood Street to resolve the zoning deficiency. Discussions were held with ISD zoning staff to determine whether the combined parcels could be reflected in a revised certified plot plan and addressed within the existing application rather than requiring a new filing.

### **Acquisition and Permit Revision**

As of May 2025, the client officially closed on 34 Linwood Street, resulting in unified ownership of both parcels. With this acquisition, the zoning conflict was eliminated. ISD subsequently approved the lot combination and consolidated the renovation and addition into one unified alteration permit. This resolution materially changed the project context and ensured that both parcels are now treated as a single parcel totaling 8,613 sq. ft.

### **Current Status – Design Review Required**

ISD has now directed the project to Boston Landmarks and the Highland Park Architectural Commission for design review prior to releasing the ALT permit. The consolidated permit scope includes:

- Renovation of the existing two-family dwelling
- Construction of a two-story rear addition
- Exterior work including siding, roofing, windows, decking and minor landscaping
- Lot combination of 34 + 40 Linwood Street (8,613 sq. ft.)

Inspector Solberg has already supported short-form permits for demolition issued, siding, and roofing, but final finishes and exterior scopes are on hold pending Landmarks review. Gabriel Amore provided verbal approval for types of siding and windows during a initial site visit, but the team is seeking formal approval through this coordinated review.

### **Sequence of Events – 40 Linwood Street**

- 1. Original ALT application filed  $\rightarrow$  flagged for side yard setback violation.
- 2. Discussions with ISD zoning staff (including Darrell Boyd, Isabel, and Jill Cox) on options for resolving the violation.
- 3. Client acquisition of 34 Linwood Street (May 2025), creating unified ownership with 40 Linwood.
- 4. Updated certified plot plan prepared showing the combined parcel.
- 5. ISD approval of lot combination and consolidation into one ALT permit (#ALT1677957).
- 6. Short-form permits issued for demolition, siding, and roofing (existing structure).
- 7. ISD referral to Boston Landmarks and Highland Park Architectural Commission for design review of the consolidated scope.
- 8. Current request: Landmarks/Commission review and approval of the following materials:

### Design Review Submission 40 Linwood Street (ALT1677957) / Public Hearing Package

- ° Certified plot plan (merged parcel)
- Proof of ownership
- Revised architectural drawings
- Exterior scopes (siding, roofing, windows, addition)

### **Request for Action:**

We respectfully request a public hearing before the Highland Park Architectural Commission and Boston Landmarks Commission for design review approval, so that ISD may release the ALT permit and the project may proceed in compliance with preservation guidelines.

Thank you for your consideration, and I look forward to presenting the materials in full. Sincerely,

Mark Williams Andaz Construction Corporation

### 40 Linwood Street, Boston MA 02119

### **EXTERIOR & INTERIOR NOTES** Boston Landmarks Notes

New Siding Option: 1

Azek Bevel Siding PVC (paint-pro technology) (No Longer Using)

Azek Shingle PVC (paint-pro technology)

Window, door, skirts, facia, soffits corner boards, trim and molding PVC Azek

Option 2: Cedar

Cedar Wood 4" Weather Clap Board

Cedar Wood Shingles

All Window, door, skirts, facia, soffits corner boards, trim and molding, pre-primed

pine wood

Roofing 40 Year Architectural Asphalt Shingles main body and

EPDM Rubber Membrane with ½" ISO boards Substrate to be 5/8" Zip Board.

Windows Anderson 400 Series Brand Manufacturing Type-Life Style (See window schedule)

Doors TBD Therma True or Standards

Decking Framing to be noted as PT lumber and finish to be Trex. Spindle railings to be a mixture of

PT, Trex and Azek.

Gutters Seamless 6" vinyl Gutters and Down Spouts.

**Down Spouts** 

### **INTERIOR NOTES**

Unit 1, Garden Level

Flooring Life Proof Vinyl Flooring & Ceramic Tile Bathroom

Window Trim Pre-primed ¾" 1x5" Pine boards
Door Trim Pre-primed ¾" 1x5" Pine boards
Interior Doors Masonite or Solid wood core
Base Boards Pre-primed ¾" 1x5" Pine boards
Walls & Ceilings Blue Board Plaster Primed & Paint

Cabinets Customer Preference
Counter Tops Granite or Quartz

### 40 Linwood Street, Boston MA 02119

### EXTERIOR & INTERIOR NOTES Boston Landmarks Notes

### (Interior)

### Unit 1, 1st Floor

Flooring New Hardwood Flooring & Ceramic Tile - Bathroom

Window Trim Pre-primed ¾" 1x5" Pine boards
Door Trim Pre-primed ¾" 1x5" Pine boards
Interior Doors Masonite or Solid wood core
Base Boards Pre-primed ¾" 1x5" Pine boards
Walls & Ceilings Blue Board Plaster Primed & Paint

Cabinets Customer Preference
Counter Tops Granite or Quartz

Unit 2, 2<sup>nd</sup> Floor

Flooring Existing Hardwood Floor & Ceramic Tile - Bathroom

Window Trim

Door Trim

Pre-primed ¾" 1x5" Pine boards

Pre-primed ¾" 1x5" Pine boards

Interior Doors

Base Boards

Walls & Ceilings

Pre-primed ¾" 1x5" Pine boards

Cabinets Customer Preference
Counter Tops Granite or Quartz

Unit 2, 3rd Floor

Flooring Existing Hardwood Floor & Ceramic Tile - Bathroom

Window Trim

Pre-primed ¾" 1x5" Pine boards

Masonite or Solid wood core

Pre-primed ¾" 1x5" Pine boards

Pre-primed ¾" 1x5" Pine boards

Blue Board Plaster Primed & Paint

Cabinets Customer Preference
Counter Tops Granite or Quartz

# **40 LINWOOD STREET Proposed Addition and Alterations**

### Roxbury, MA 02119

George Luse and Lynn Luse

Architect:

### **HEZEKIAH PRATT ARCHITECTURE + DESIGN**

47 Glen Avenue, Newton MA02460 617.320.3749 hezpratt@gmail.com

Structural Engineer: Berdi Consulting Structural Engineering 25 Wayland Hills Road Wayland MA 01778 508.308.9012 Stas berdichevsky@yahoo.com

Surveyor: Neponset Valley Survey Assoc. Inc. 95 White Street Quincy MA 02169 tmf@comcast.net

Contractor: Mark Williams Andaz Construction Corporation 501 Boylston Street, Suite 09B112 Boston MA 02126 andazconstructioncorp@gmail.com

### Drawings List

Cover

Proposed Survey Plan and Drainage

- EX1 Existing Basement and First Floor Plans
- EX2 Existing Second and Third Floor Plans
- EX3 Existing Front and Right Side Elevations
- EX4 Existing Rear and Left Side Elevations A1.0 Site Plan
- A2.0 Proposed Garden Level and First Floor Plans
- A3.0 Proposed Second Floor and Third Floor Plans
- A4.0 Proposed Front and Right Side Elevations
- A5.0 Proposed Rear and Left Side Elevations
- A6.0 Typical Wall Section, Rated Wall Detail, Rated Ceiling Detail Window Details and Deck Framing Details
- A7.0 Schedules
- E1.0 Garden Level and First Floor Electrical Plans
- E2.0 Second Floor and Third Floor Electrical Plans
- S101 Framing Plans
- S102 Framing Plans
- S103 Framing Plans

PERMIT PLANS July 5, 2024









Project:


# 40 LINWOOD STREET Proposed Addition and Alterations Roxbury, MA 02119


PERMIT PLANS July 5, 2024

# **EXISTING CONDITIONS**

### DIMENSIONS:

ALL DIMENSIONS, CALCULATIONS OR OTHER DATA PERTAINING TO THE WORK OF ALL TRADES SHALL BE CAREFULLY CHECKED BEFORE MANUFACTURE, FABRICATION OR INSTALLATION OF ANY PORTION OF THE WORK BEFORE IT IS COMMENCED. ANY DISCREPANCIES DISCOVERED SHALL BE REPORTED IMMEDIATELY TO THE ARCHITECT FOR HIS DECISION. ALL WORK SHOWN ON THE DRAWINGS IS INTENDED TO BE CORRECT ACCORDING TO THE SCALE, BUT FIGURED DIMENSIONS AND DETAIL DRAWINGS ARE IN ALL CASES TO BE FOLLOWED. THE CONTRACTOR SHALL VERIFY ALL DIMENSIONS AT THE SITE, REGARDLESS OF DIMENSIONS SHOWN ON DRAWINGS. HE SHALL BE RESPONSIBLE FOR ALL WORK AFFECTED BY THIS PROVISION.

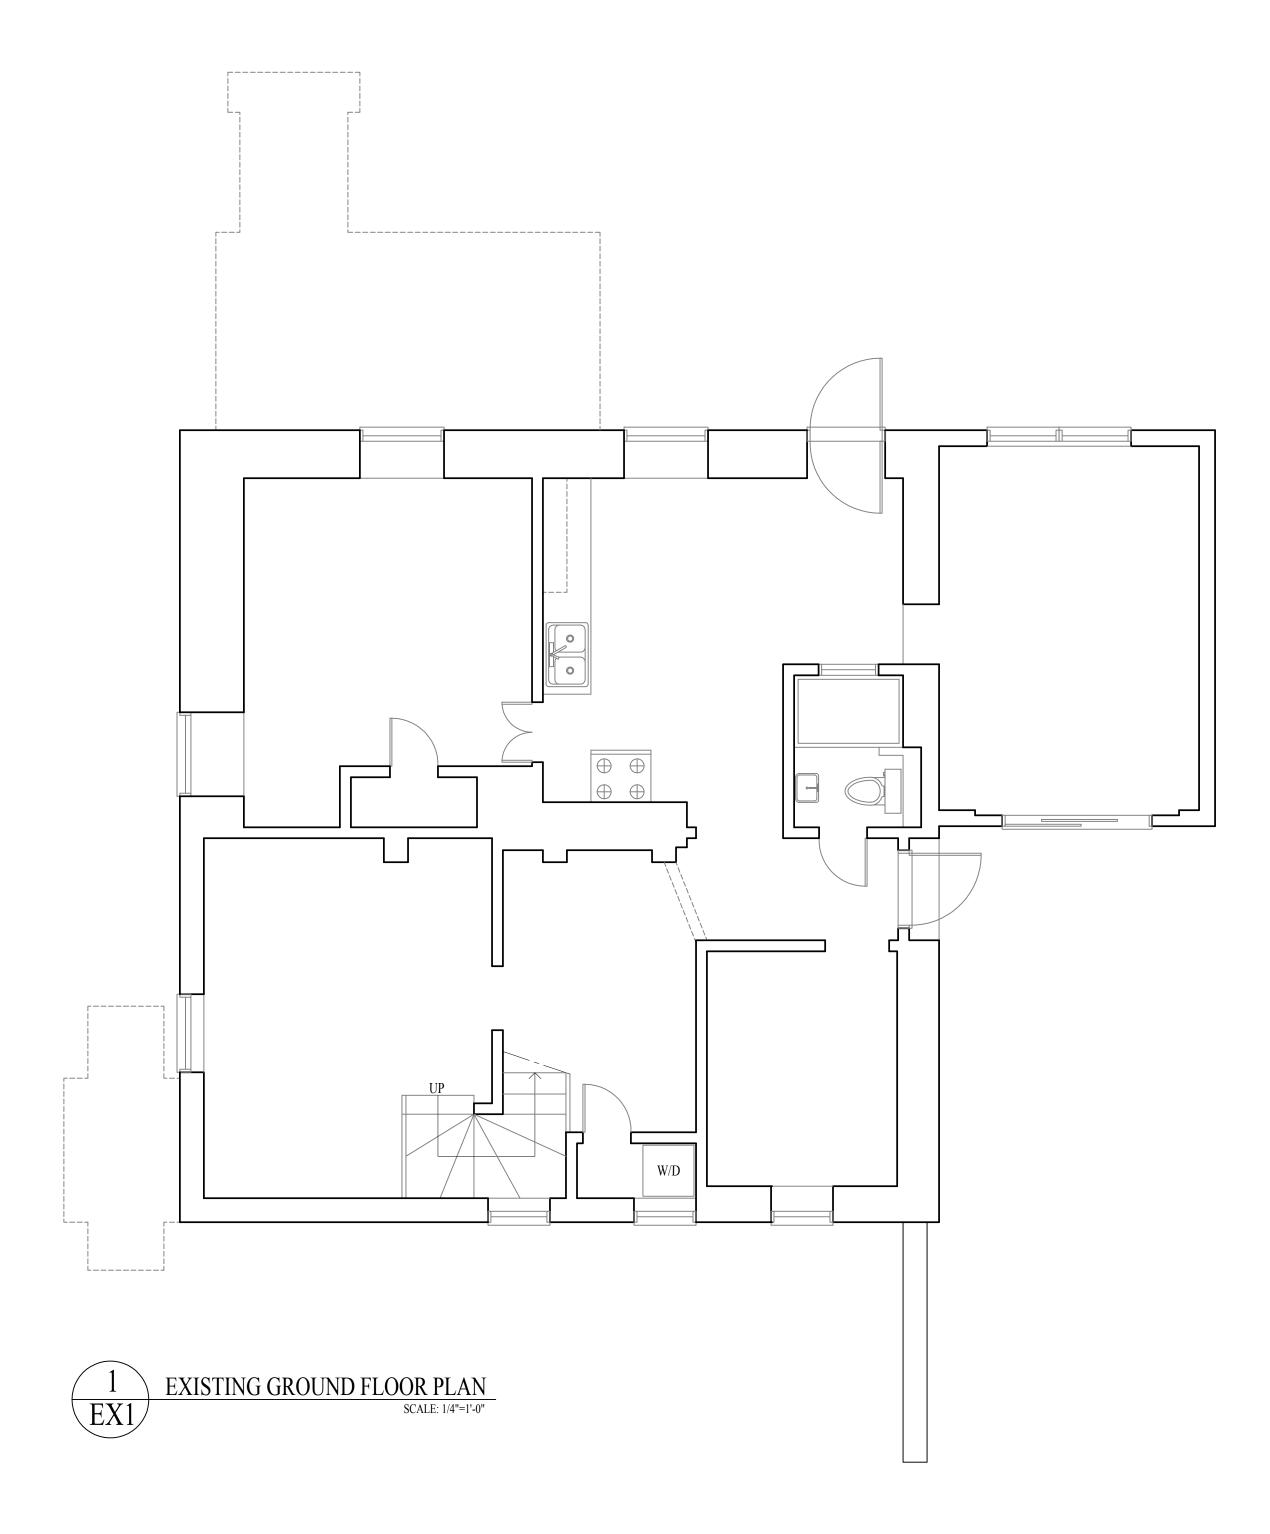

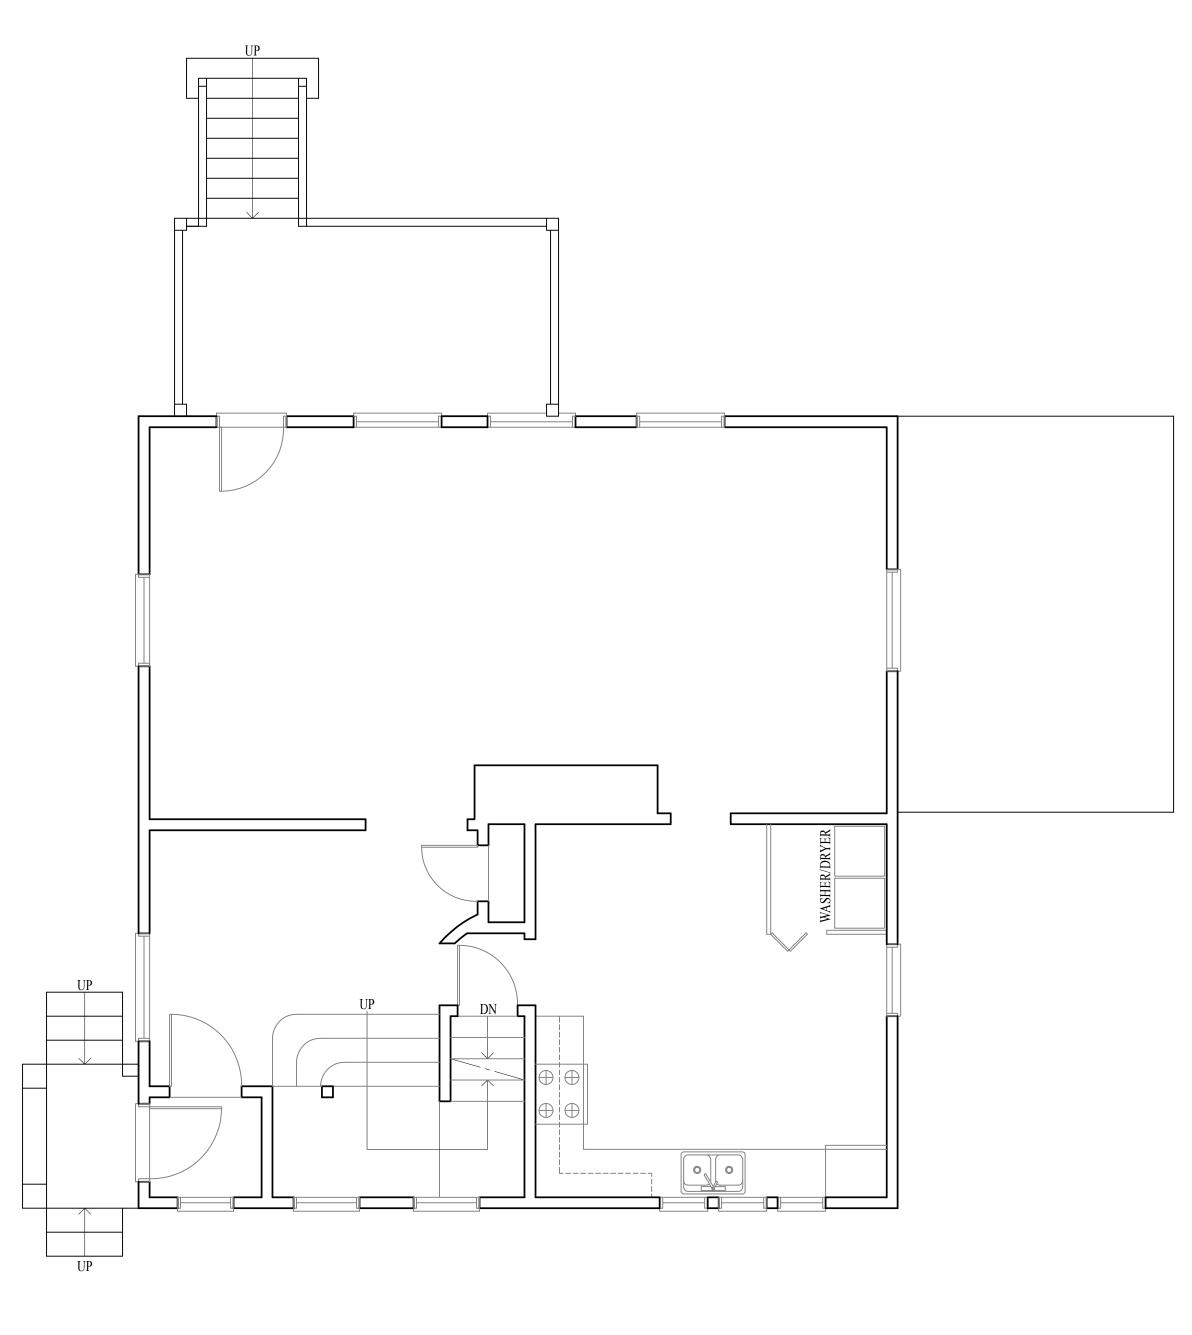



HEZEKIAH PRATT ARCHITECTURE + DESIG 17 Glen Avenue Newton, MA 02460

Project
40 LINWOOD STREET
Proposed Addition And Alterations
40 Linwood Street, Roxbury, MA 02119

Title:

EXISTING GROUND
AND FIRST FLOOR PLANS

Scale: 1/4"=1'-0"

Revisions:

Drawn by: BLS

Approved by: HP

Project No.:


Date: 7-5-24

Drawing No.:


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HEZEKIAH PRATT ARCHITECTURE + DESIGN Glan Avenue Newton, MA 02460 617.320.3749 hezpratt@aol.com

Project
40 LINWOOD STREET
Proposed Addition And Alterations
40 Linwood Street, Roxbury, MA 02119

Title:

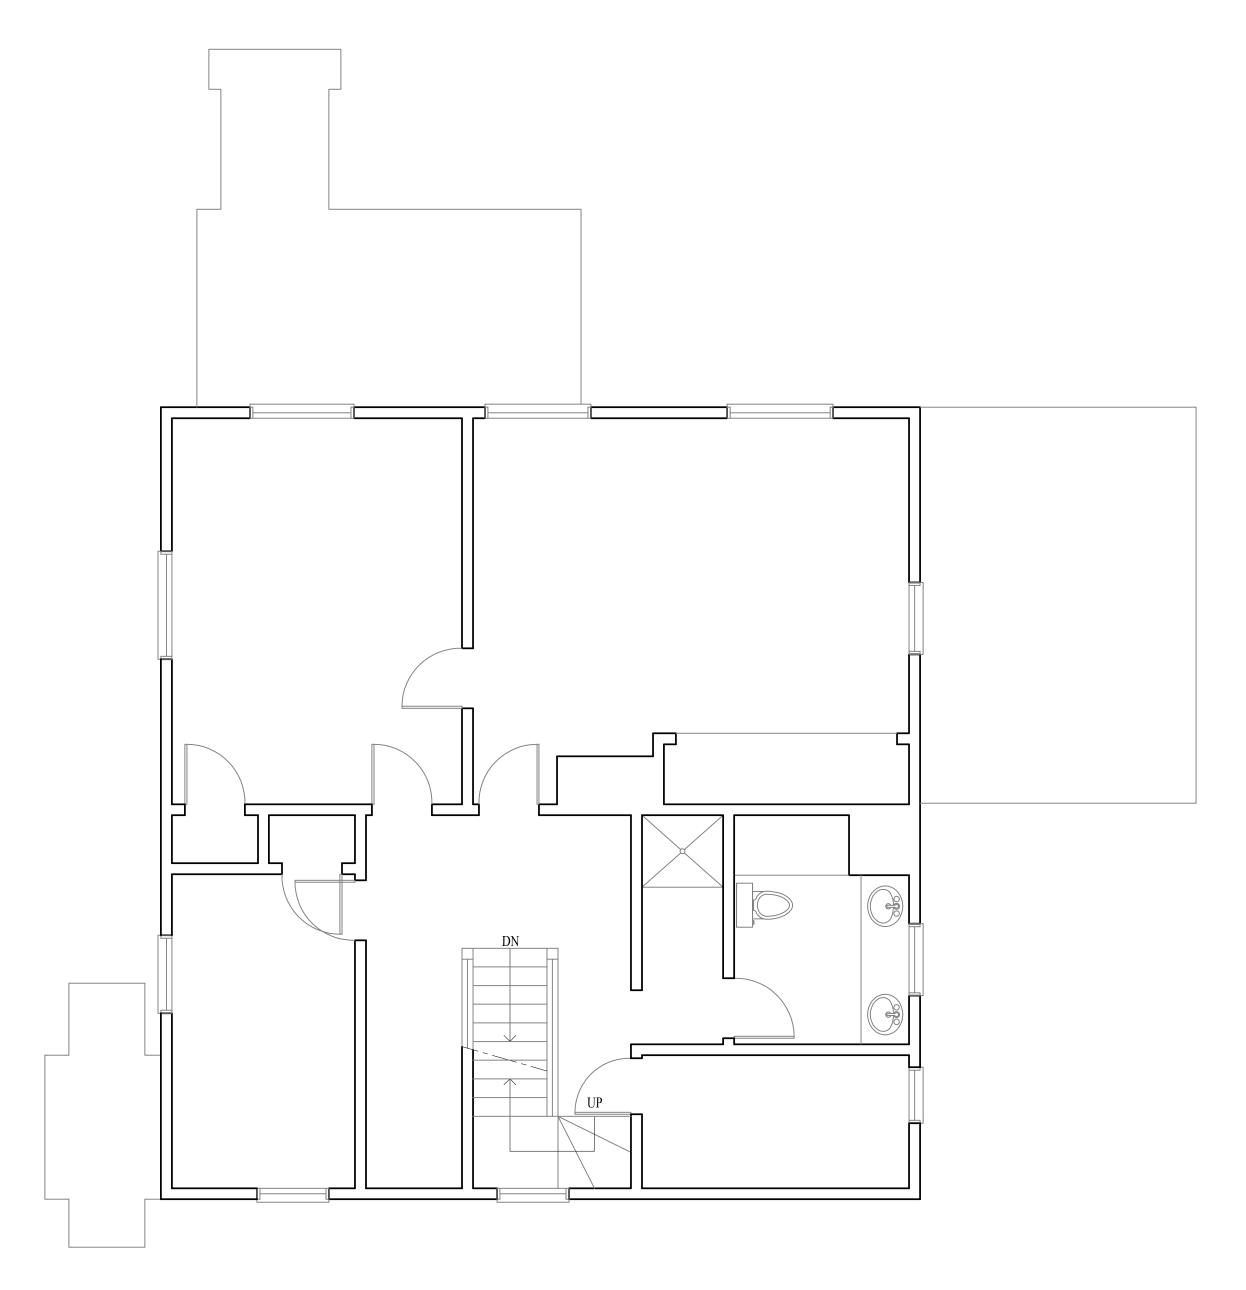EXISTING SECOND AND THIRD FLOOR PLANS

Scale: 1/4"=1'-0"

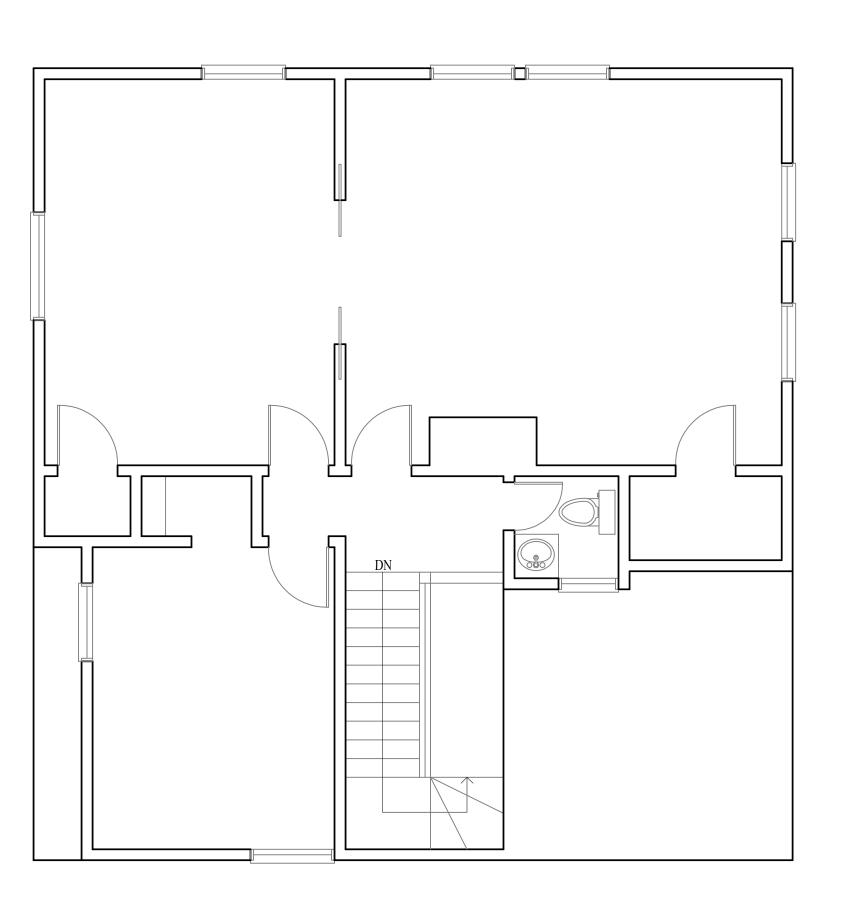Revisions:

Drawn by: BLS

Approved by: HP

Project No.:

Date: 7-5-24

Drawing No.:

# **EXISTING CONDITIONS** DIMENSIONS: ALL DIMENSIONS, CALCULATIONS OR OTHER DATA PERTAINING TO THE WORK OF ALL TRADES SHALL BE CAREFULLY CHECKED BEFORE MANUFACTURE, FABRICATION OR INSTALLATION OF ANY PORTION OF THE WORK BEFORE IT IS COMMENCED. ANY DISCREPANCIES DISCOVERED SHALL BE REPORTED IMMEDIATELY TO THE ARCHITECT FOR HIS DECISION. ALL WORK SHOWN ON THE DRAWINGS IS INTENDED TO BE CORRECT ACCORDING TO THE SCALE, BUT FIGURED DIMENSIONS AND DETAIL DRAWINGS ARE IN ALL CASES TO BE FOLLOWED. THE CONTRACTOR SHALL VERIFY ALL DIMENSIONS AT THE SITE, REGARDLESS OF DIMENSIONS SHOWN ON DRAWINGS. HE SHALL BE RESPONSIBLE FOR ALL WORK AFFECTED BY THIS PROVISION. EXISTING FRONT ELEVATION SCALE: 1/4"=1'-0" EXISTING RIGHT SIDE ELEVATION SCALE: 1/4"=1'-0"

Architect
HEZEKIAH PRATT ARCHITECTURE + DES]
47 Glen Avenue Newton, MA 02460
517.320.3749 hezpratt@aol.com

Project
40 LINWOOD STREET
Proposed Addition And Alterations
40 Linwood Street, Roxbury, MA 02119

Title:

EXISTING FRONT AND RIGHT SIDE ELEVATIONS

Scale: 1/4"=1'-0"

Revisions:

Drawn by: BLS

Approved by: HP

Project No.:

Date: 7-5-24

Drawing No.:

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Architect
HEZEKIAH PRATT ARCHITECTURE + DESIG)
47 Glen Avenue Newton, MA 02460
617.320.3749 hezpratt@aol.com

Project
40 LINWOOD STREET
Proposed Addition And Alterations
40 Linwood Street, Roxbury, MA 02119

Title:

EXISTING REAR AND LEFT SIDE ELEVATIONS

Scale: 1/4"=1'-0"

Revisions:

Drawn by: BLS

Approved by: HP


Project No.:

Date: 7-5-24

Drawing No.:

# PROPOSED ADDITION AND ALTERATIONS

DIMENSIONS:
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TO THE WORK OF ALL TRADES SHALL BE CAREFULLY CHECKED
BEFORE MANUFACTURE, FABRICATION OR INSTALLATION OF ANY
PORTION OF THE WORK BEFORE IT IS COMMENCED. ANY
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TO THE ARCHITECT FOR HIS DECISION. ALL WORK SHOWN ON THE
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AT THE SITE, REGARDLESS OF DIMENSIONS SHOWN ON DRAWINGS.
HE SHALL BE RESPONSIBLE FOR ALL WORK AFFECTED BY THIS
PROVISION.

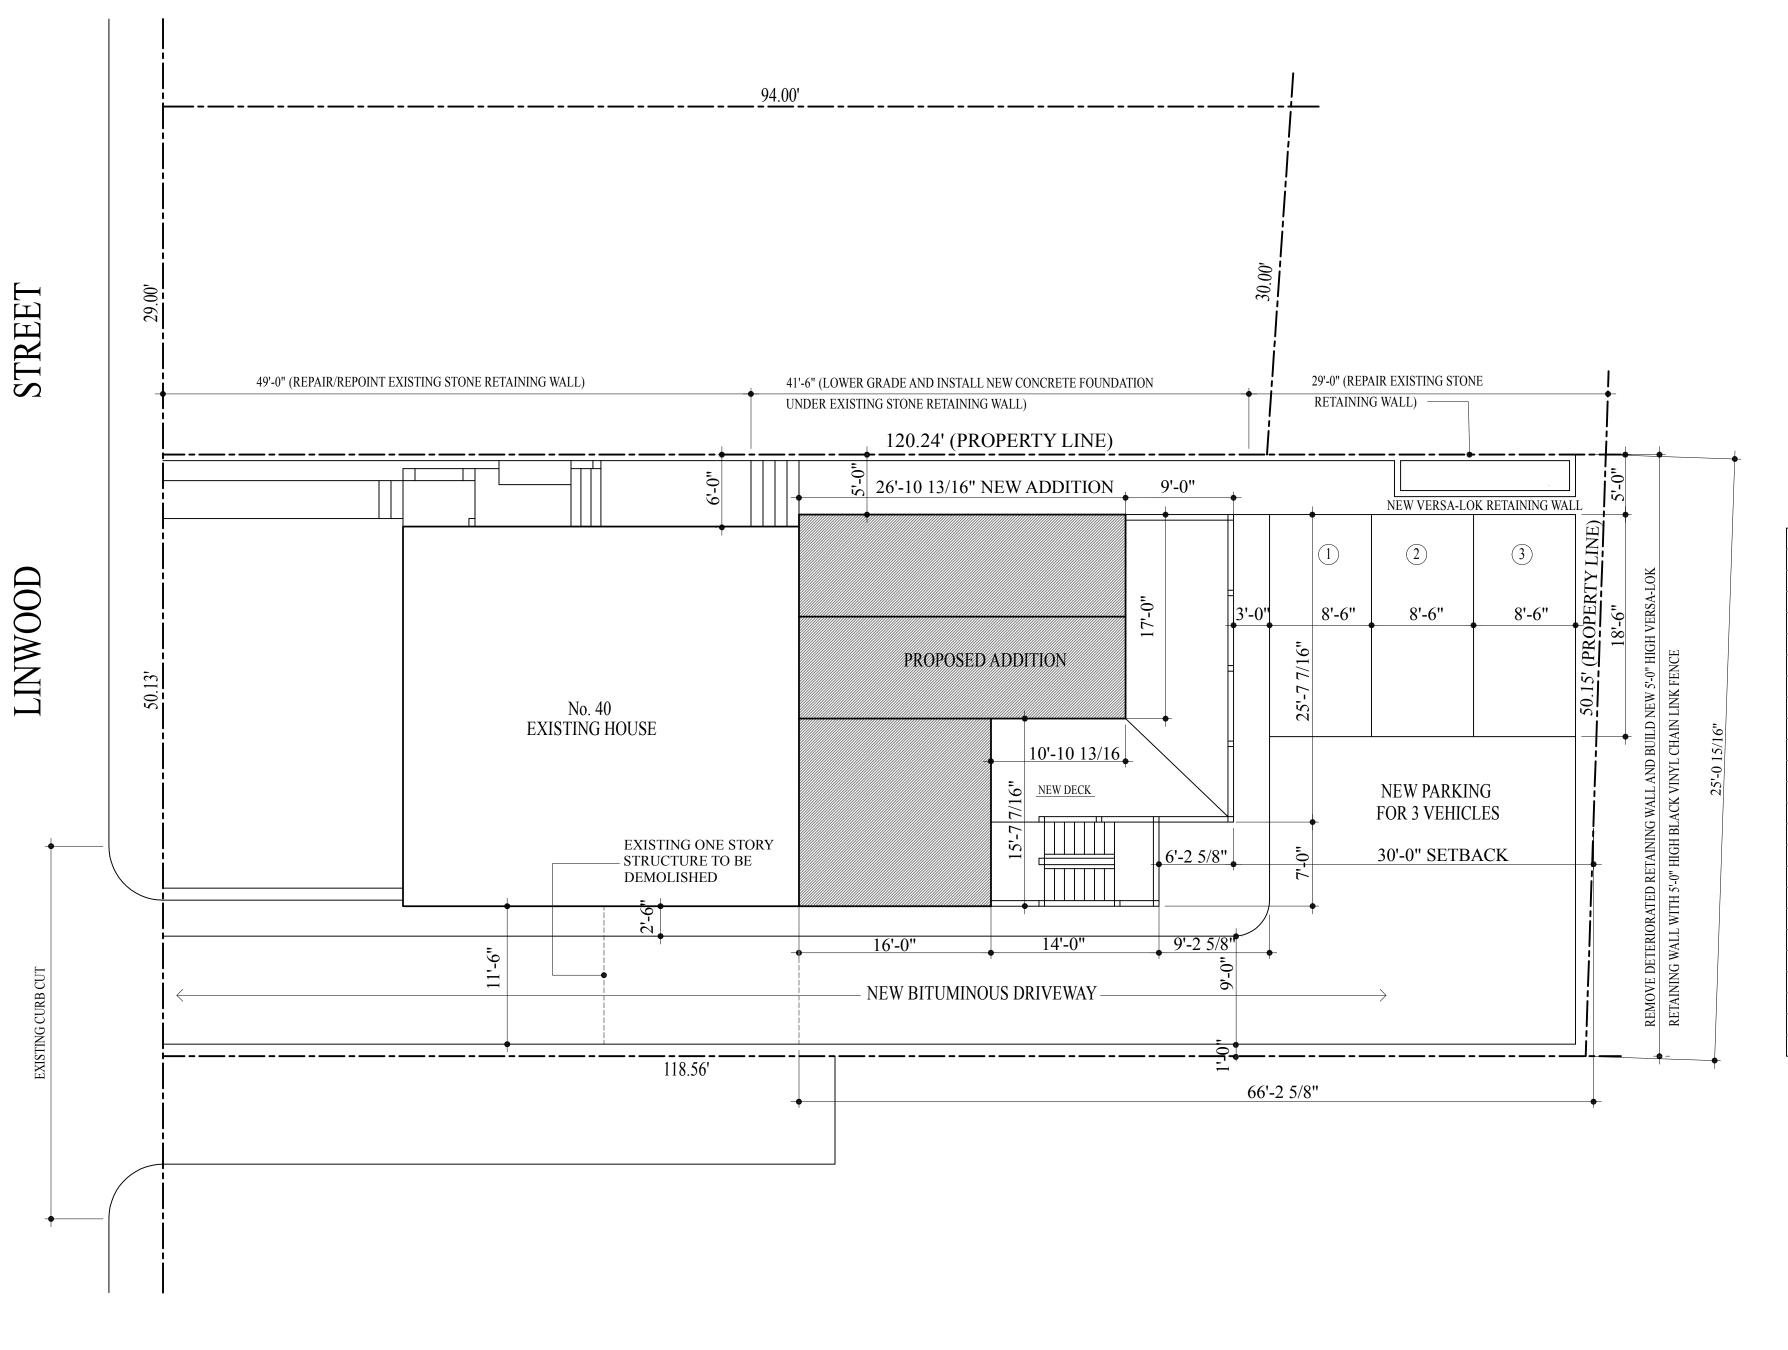

NOTE: THE LAND SURVEYOR SHALL

VERIFY ALL SETBACKS SHOWN

IN THE FIELD.

SITE PLAN

SCALE: 1/8"=1'-0"

ZONING REVIEW			
PROJECT ADDRESS	40 LINWOOD STREET		
NEIGHBORHOOD DISTRICT	ROXBURY NEIGHBORHOOD		
ZONING ARTICLE	50		
MAP NUMBER	6A-6C		
NEIGHBORHOOD DESIGN OVERLAY DISTRICT			
HIGHLAND PARK ARCHITECTURAL CONSERVATION DISTRICT			
ZONING DISTRICT	3F-4000		
EXISTING USE	RESIDENTIAL-TWO FAMILY		
PROPOSED USE	RESIDENTIAL-TWO FAMILY		
LOT AREA	5990 SF		
PROPOSED GROSS SQUARE FOOTAGE	5009 GSF		
DIMENSIONAL REQUIREMENTS TABLE C			
ITEM	REQUIRED	EXISTING	PROPOSED
MINIMUM LOT AREA	4000 SF	5990 SF	5990 SF
MINIMUM LOT WIDTH	45 FEET	50.13 FEET	50.13 FEET
MINIMUM LOT FRONTAGE	45 FEET	50.13 FEET	50.13 FEET
MAXIMUM FLOOR AREA RATIO	.8 FEET	.6 FEET	.8 FEET
MAXIMUM BUILDING HEIGHT	35 FEET	33 FEET	33 FEET
MAXIMUM BUILDING HEIGHT STORIES	3 STORIES	3 STORIES	3 STORIES
MINIMUM USABLE OPEN SPACE	1300 SF		1632 SF
MINIMUM FRONT YARD	20 FEET	20 FEET	20 FEET
MINIMUM SIDE YARD	5 FT/15 FT AGGREGATE	5 FT/18 FT AGGREGATE	5 FT/18.6 FT AGGREGATI
MINIMUM REAR YARD	30 FEET	66.22 FEET	30 FEET
OFF-STREET PARKING REQUIREMENTS: 1 PER DWELLING	2 SPACES	1 SPACE	3 SPACES

Architect
HEZEKIAH PRATT ARCHITECTURE + DESIGN
47 Glen Avenue Newton, MA 02460
617.320.3749 hezpratt@aol.com

Project
40 LINWOOD STREET
Proposed Addition And Alterations
40 Linwood Street, Roxbury, MA 02119

Title:
SITE PLAN

Scale: 1/8"=1'-0"

Revisions:

Drawn by: BLS


Approved by: HP

Project No.:

Date: 7-5-24

Drawing No.:

A1.0

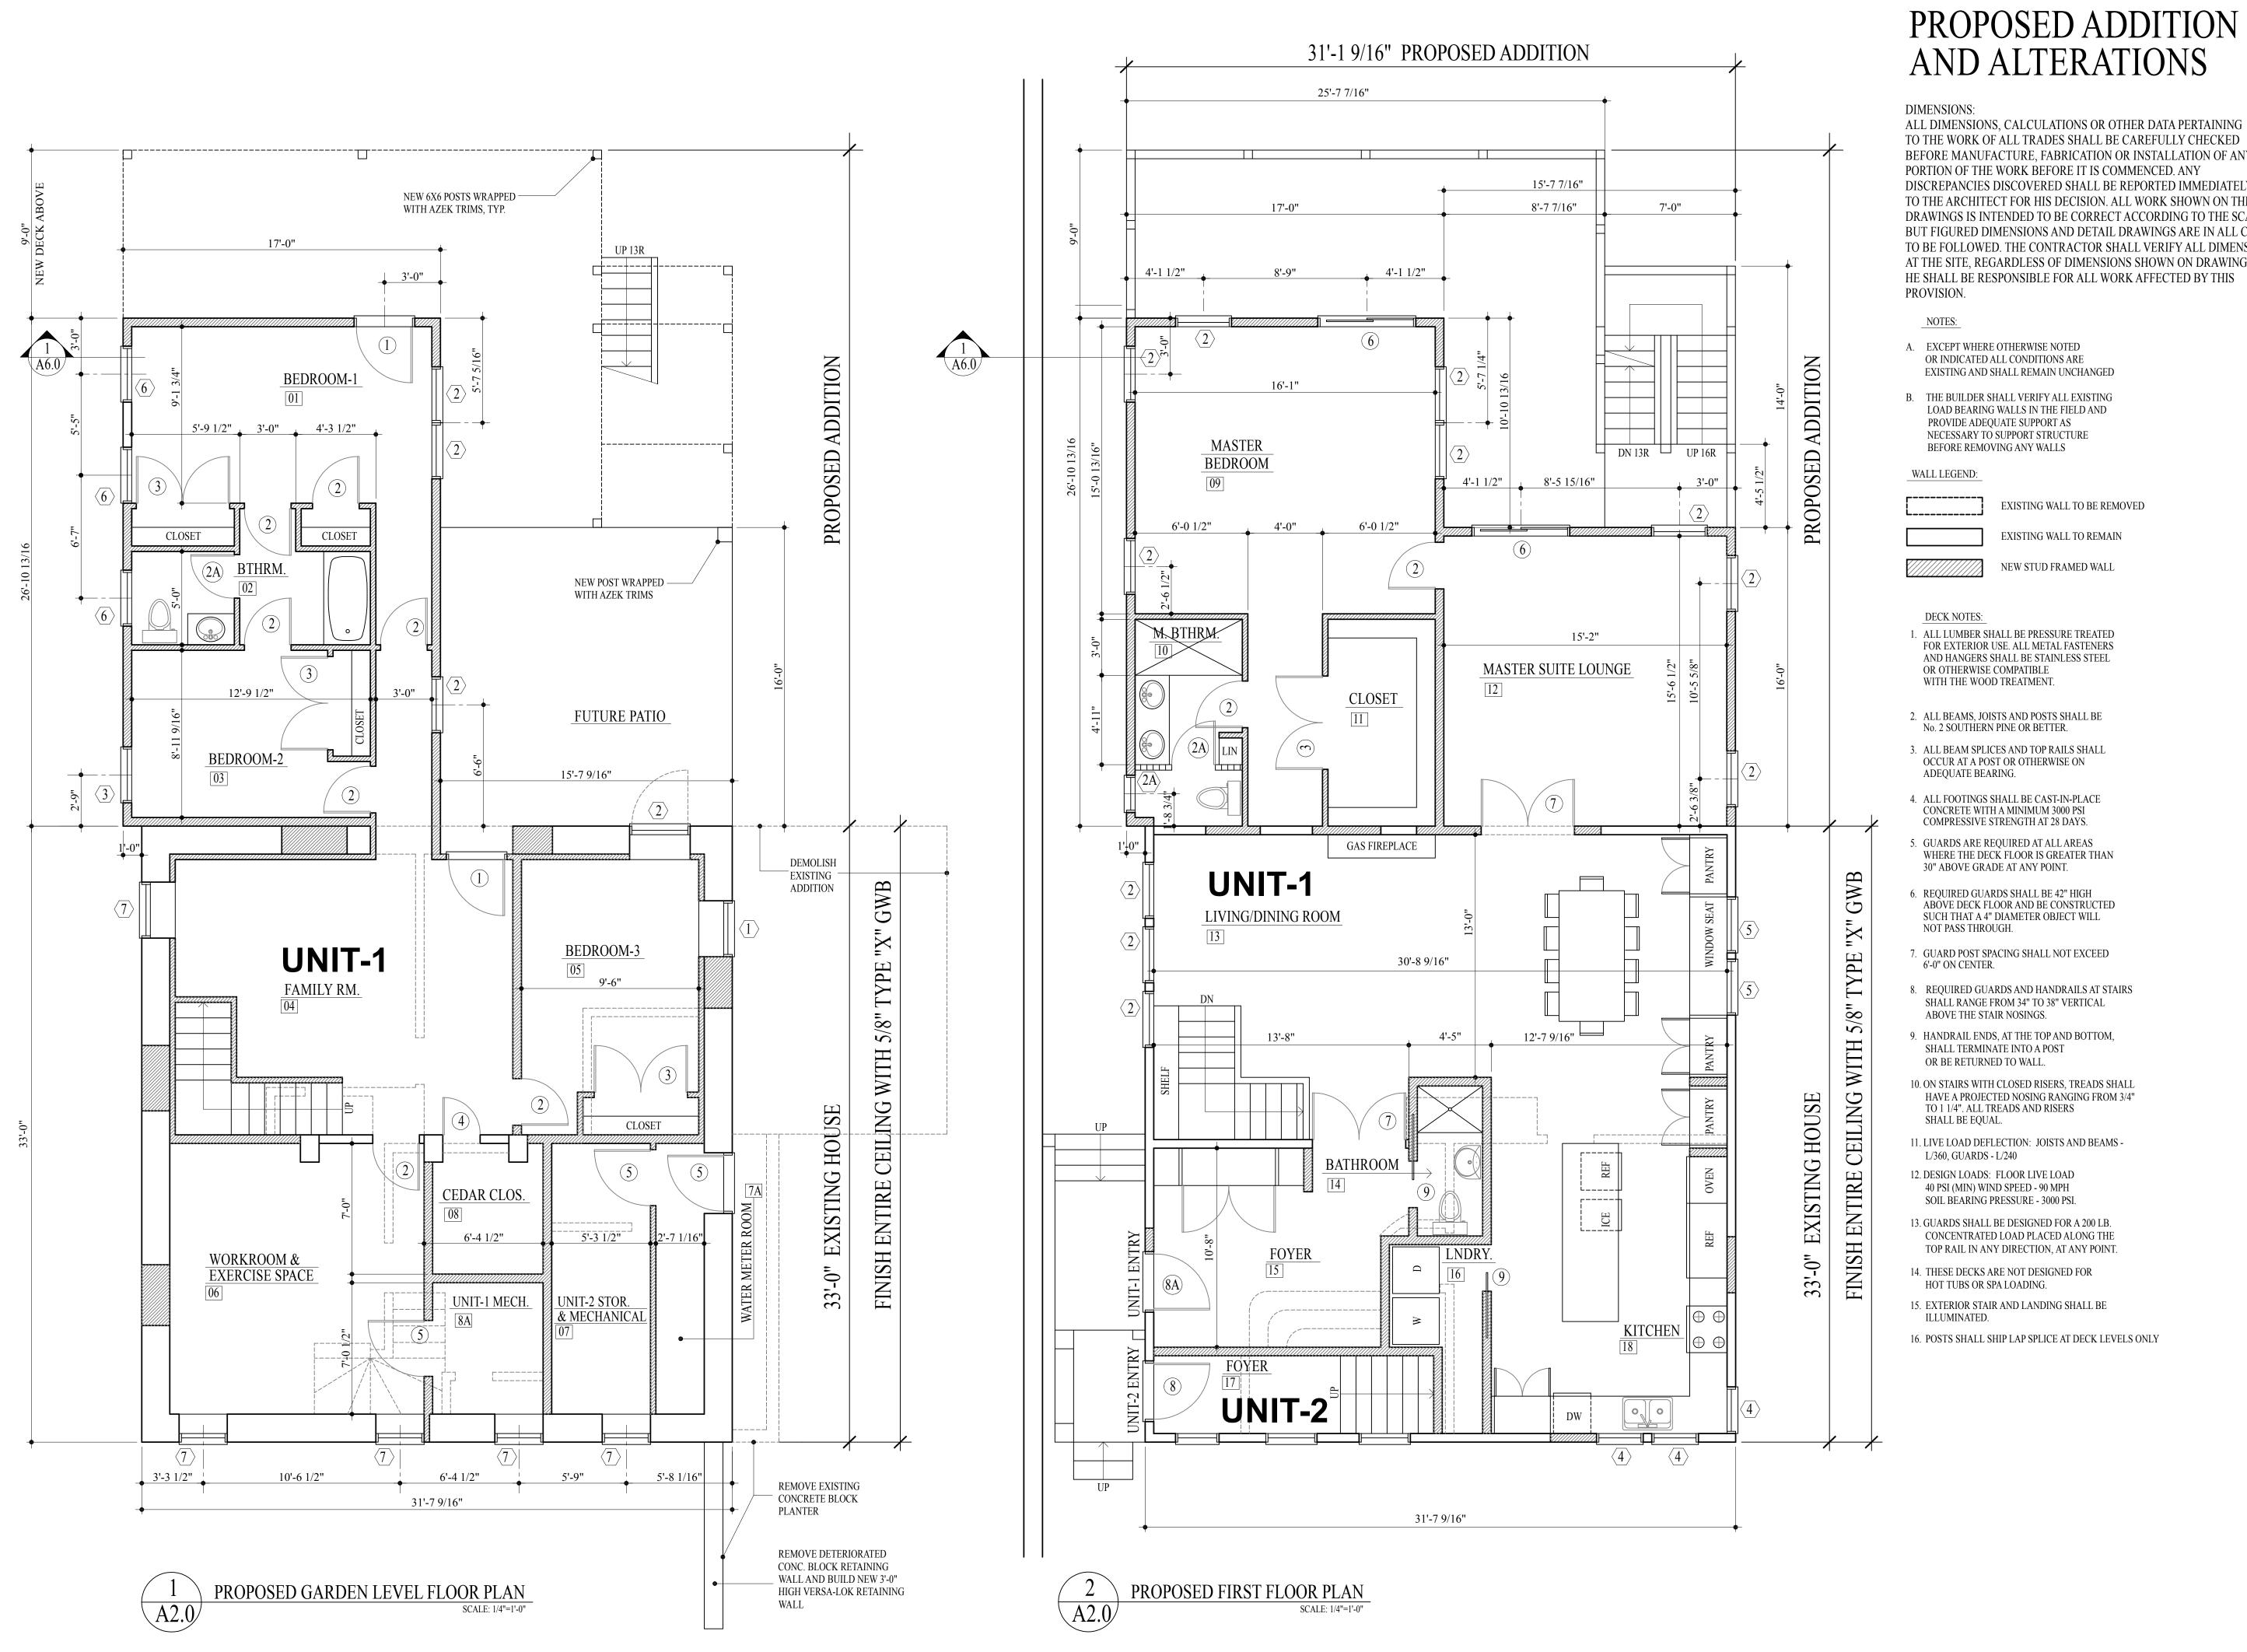



BEFORE MANUFACTURE, FABRICATION OR INSTALLATION OF ANY DISCREPANCIES DISCOVERED SHALL BE REPORTED IMMEDIATELY AT THE SITE, REGARDLESS OF DIMENSIONS SHOWN ON DRAWINGS.

Architect
HEZEKIAH PRATT ARCHIT
47 Glen Avenue Newton, MA 02460
617.320.3749 hezpratt@aol.com

Project
40 LINWOOD STREET
Proposed Addition And Alterations
40 Linwood Street, Roxbury, MA 02119

Scale:	1/4"=1'-0"
Revisions:	
Drawn by:	
•	BLS
Approved by:	HP
Project No.:	
Date:	7-5-24
Drawing No.:	

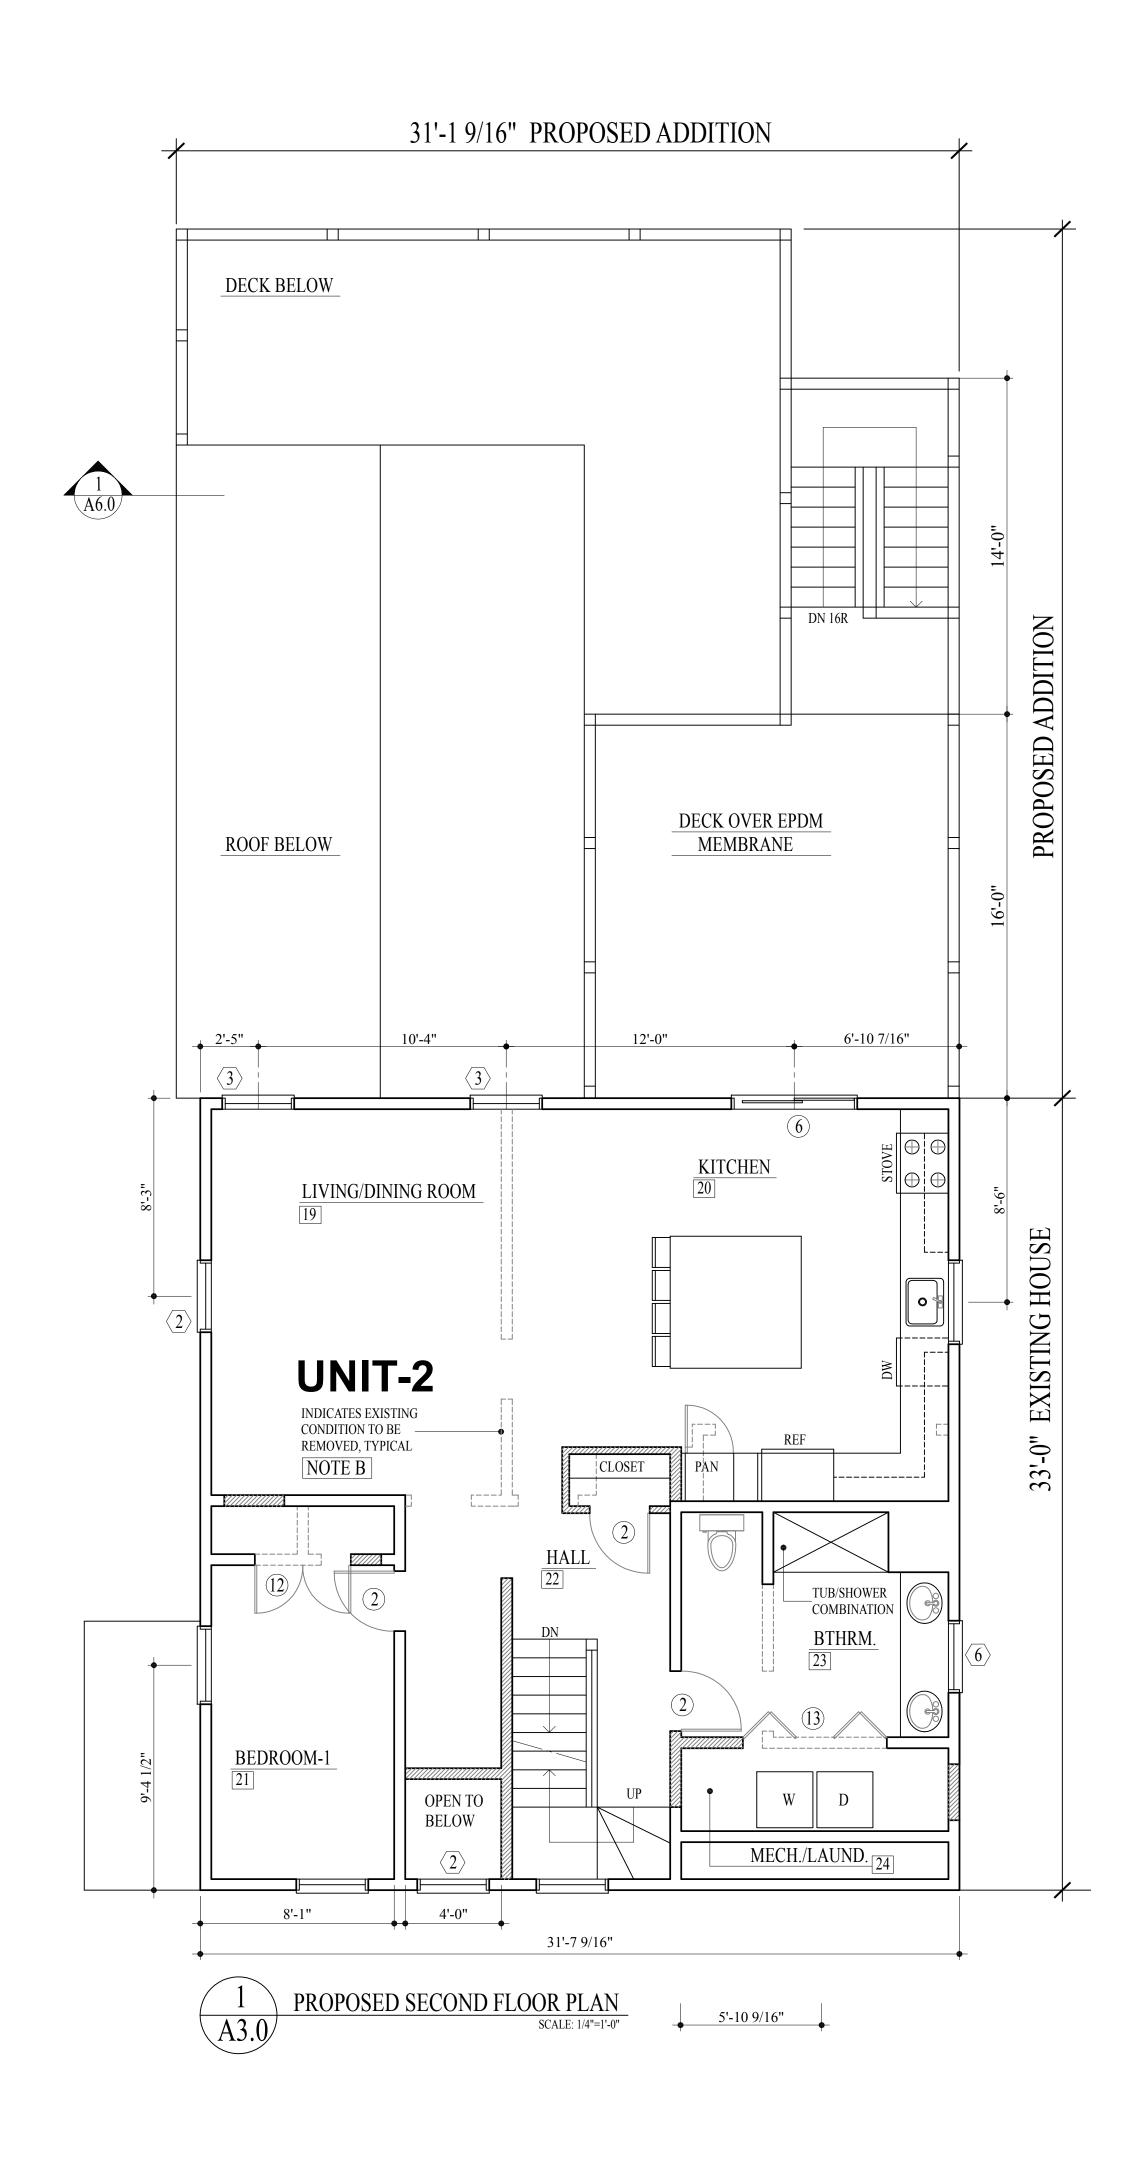

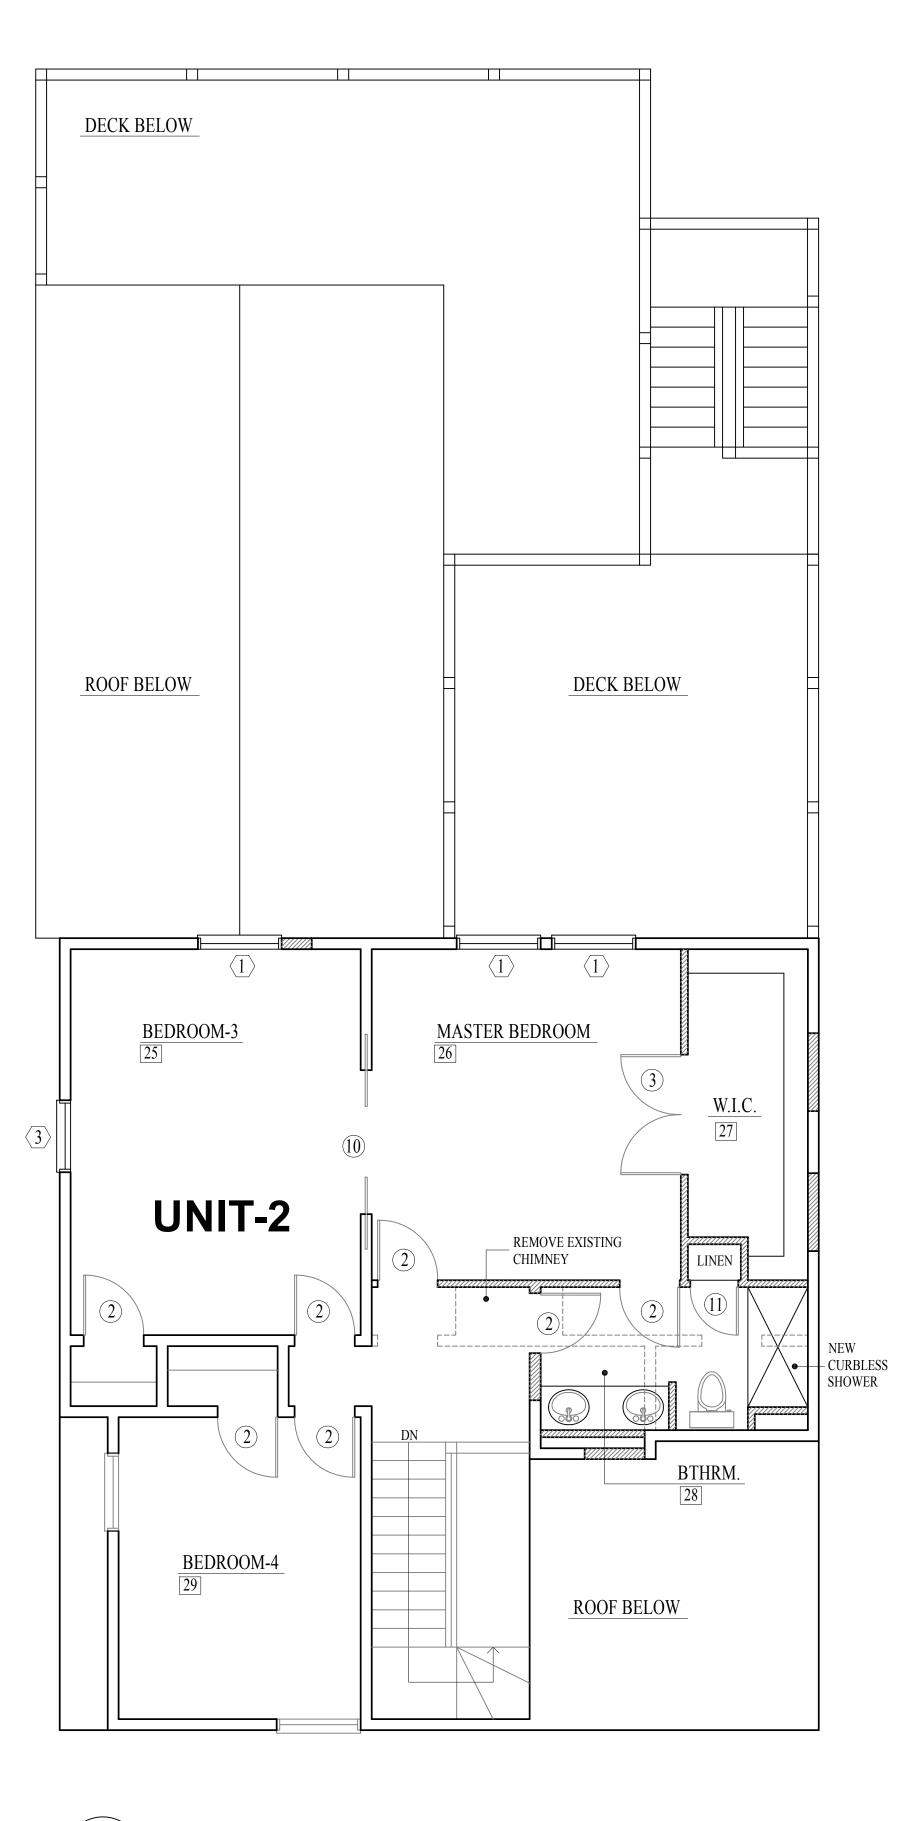

PROPOSED THIRD FLOOR PLAN

### PROPOSED ADDITION AND ALTERATIONS

DIMENSIONS:
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TO THE WORK OF ALL TRADES SHALL BE CAREFULLY CHECKED
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TO THE ARCHITECT FOR HIS DECISION. ALL WORK SHOWN ON THE
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BUT FIGURED DIMENSIONS AND DETAIL DRAWINGS ARE IN ALL CASES
TO BE FOLLOWED. THE CONTRACTOR SHALL VERIFY ALL DIMENSIONS
AT THE SITE, REGARDLESS OF DIMENSIONS SHOWN ON DRAWINGS.
HE SHALL BE RESPONSIBLE FOR ALL WORK AFFECTED BY THIS

NOTES:

PROVISION.

- A. EXCEPT WHERE OTHERWISE NOTED
  OR INDICATED ALL CONDITIONS ARE
  EXISTING AND SHALL REMAIN UNCHANGED
- B. THE BUILDER SHALL VERIFY ALL EXISTING LOAD BEARING WALLS IN THE FIELD AND PROVIDE ADEQUATE SUPPORT AS NECESSARY TO SUPPORT STRUCTURE BEFORE REMOVING ANY WALLS

WALL LEGEND:

EXISTING WALL TO BE REMOVED

EXISTING WALL TO REMAIN

NEW STUD FRAMED WALL

### GENERAL NOTES FOR ALL FLOORS:

- 1. REMOVE ALL EXISTING CEILINGS AND WALLS WITH HORSEHAIR PLASTER AT GARDEN FLOOR AND FIRST FLOOR ONLY.
- 2. ALL WALLS TO BE REPLACED WITH 1/2" BLUEBOARD AND PLASTER.
- 3. INSTALL 5/8" FIRE RATED BLUEBOARD AND PLASTER WHERE REQUIRED.
- 4. ALL AFFECTED AREAS TO HAVE R22 OPEN/CLOSED-CELL INSULATION.
- 5. ALL FRAMING OF DECKS, DEMOLITION OF WALLS, AND LOCATION OF NEW WALLS TO ADHERE TO ARCHITECTURAL PLANS AND STRUCTURAL ENGINEERING SPECIFICATIONS.
- 6. ALL EXISTING WALLS AND CEILINGS WITH HORSEHAIR PLASTER SHALL REMAIN AT SECOND AND THIRD FLOOR ONLY.
- 7. IF ANY MODIFICATIONS AND RENOVATIONS ARE NEEDED TO INSTALL WINDOWS, DOORS, ELECTRICAL, PLUMBING, HVAC ALL AREAS AFFECTED SHALL BE BLENDED TO MATCH EXISTING.
- 8. AREAS THAT CANNOT BE INSULATED FROM THE INTERIOR WILL BE INSULATED FROM THE EXTERIOR DUE TO THE EXTERIOR SIDING BEING STRIPPED DOWN TO EXISTING LEDGER BOARD.

INTERIOR NOTES:

UNIT-1 GARDEN LEVEL
FLOORING
LIFE PROOF VINYL FLOORING AND CERAMIC TILE IN BATHROOMS
WINDOW TRIMS
PRE-PRIMED 3/4" 1X5" PINE BOARDS
DOOR TRIMS
PRE-PRIMED 3/4" 1X5" PINE BOARDS
INTERIOR DOORS
MASONITE OR SOLID WOOD. SEE DOOR SCHEDULE.

BASEBOARDS
WALLS/CEILINGS
CABINETS
COUNTERTOPS
WASONTE OR SOLID WOOD. SEE BOOR SCHI

UNIT-1 FIRST FLOOR

NEW HARDWOOD FLOORING AND CERAMIC TILE IN BATHROOMS FLOORING WINDOW TRIMS PRE-PRIMED 3/4" 1X5" PINE BOARDS PRE-PRIMED 3/4" 1X5" PINE BOARDS DOOR TRIMS MASONITE OR SOLID WOOD CORE INTERIOR DOORS BASEBOARDS PRE-PRIMED 3/4" 1X5" PINE BOARDS WALLS/CEILINGS BLUBOARD PLASTER PRIMED AND PAINT **CABINETS** CUSTOMER PREFERENCE COUNTERTOPS GRANITE OR QUARTZ

UNIT-2 2nd FLOOR FLOORING EXISTING HARDWOOD FLOORING AND CERAMIC TILE BATHROOMS PRE-PRIMED 3/4" 1X5" PINE BOARDS WINDOW TRIMS DOOR TRIMS PRE-PRIMED 3/4" 1X5" PINE BOARDS INTERIOR DOORS MASONITE OR SOLID WOOD CORE **BASEBOARDS** PRE-PRIMED 3/4" 1X5" PINE BOARDS WALLS/CEILINGS BLUBOARD PLASTER PRIMED AND PAINT CABINETS CUSTOMER PREFERENCE COUNTERTOPS GRANITE OR QUARTZ

UNIT-2 3nd FLOOR FLOORING WINDOW TRIMS DOOR TRIMS INTERIOR DOORS BASEBOARDS WALLS/CEILINGS CABINETS


COUNTERTOPS

EXISTING HARDWOOD FLOORING AND CERAMIC TILE BATHROOMS PRE-PRIMED 3/4" 1X5" PINE BOARDS PRE-PRIMED 3/4" 1X5" PINE BOARDS MASONITE OR SOLID WOOD CORE PRE-PRIMED 3/4" 1X5" PINE BOARDS BLUBOARD PLASTER PRIMED AND PAINT CUSTOMER PREFERENCE GRANITE OR QUARTZ

Architect
HEZEKIAH PRATT ARCHITECTURE +
47 Glen Avenue Newton, MA 02460
617.320.3749 hezpratt@aol.com

Project
40 LINWOOD STREET
Proposed Addition And Alterations
40 Linwood Street, Roxbury, MA 02119

Scale:	1/411 11 011
	1/4"=1'-0"
Revisions:	
D 1	
Drawn by:	BLS
Approved by:	HP
Project No.:	
Date:	7-5-24
Drawing No.:	
-	

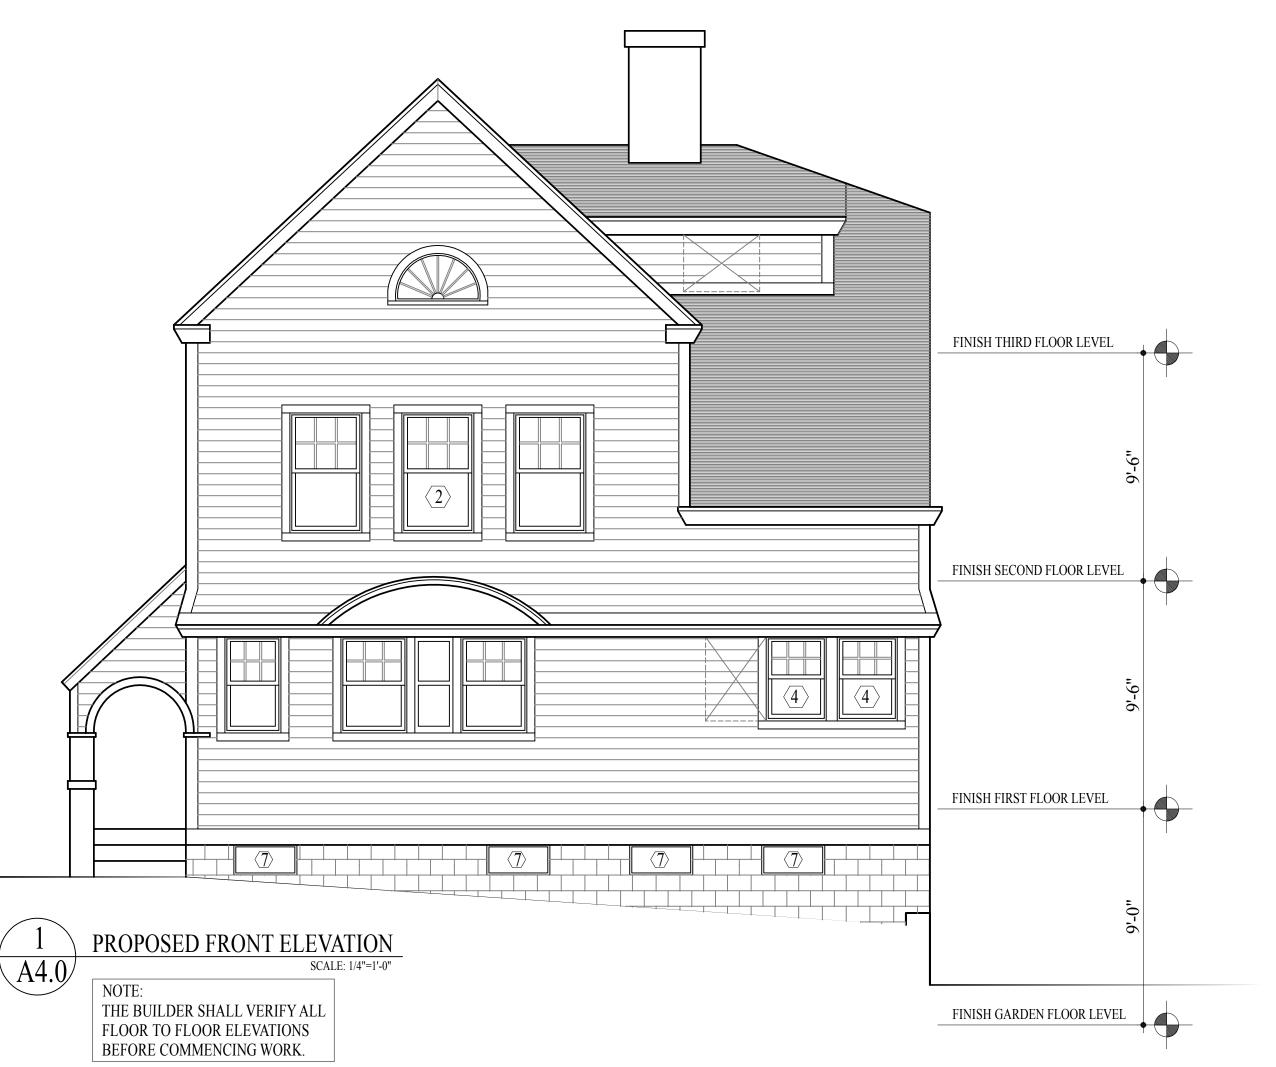

### PROPOSED ADDITION AND ALTERATIONS

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**EXTERIOR NOTES:** 

NEW SIDING OPTION: 1

AZEK BEVEL SIDING PVC (PAINT-PRO TECHNOLOGY)
AZEK SHINGLE PVC (PAINT-PRO TECHNOLOGY)
ALL WINDOWS, DOORS, SKIRTS, FACIA, SOFFITS, CORNER BOARDS,
TRIMS AND MOLDINGS SHALL BE AZEK PVC

NEW SIDING OPTION: 2 HARDI-PLANK CLAPBOARD SIDING ALL WINDOWS, DOORS, SKIRTS, FASCIA, SOFFITS, CORNER BOARDS TRIMS AND MOLDINGS SHALL BE HARDI-PLANK

NEW SIDING OPTION: 3 CEDAR WOOD 4" WEATHER CLAPBOARDS, CEDAR WOOD SHINGLES ALL WINDOWS, DOORS, SKIRTS, FASCIA, SOFFITS, CORNER BOARDS, TRIMS AND MOLDINGS PRE-PRIMED PINE WOOD

ROOFING 40 YEAR ARCHITECTURAL ASPHALT SHINGLES MAIN BODY AND EPDM RUBBER MEMBRANE WITH 1/2" ISO BOARD SUBSTRATE TO BE 5/8" SYSTEM.

WINDOWS PELLA BRAND MANUFACTURING TYPE-LIFE STYLE.

SEE WINDOW SCHEDULE.

DOORS TBD THERMA TRUE OR STANDARDS. SEE DOOR SCHEDULE.

DECKING FRAMING TO BE P.T. LUMBER AND FINISH TO BE TREX.

SPINDLE RAILINGS TO BE A MIXTURE OF P.T., TREX AND AZEK.

GUTTERS/DOWNSPOUTS SEAMLESS 6" VINYL GUTTERS AND DOWN SPOUTS

### WINDOW INSTALLATION INSTRUCTIONS:

1. MEASURE: REPLACEMENT: CONFIRM THAT THE ROUGH OPENING IS AT LEAST 1/4"WX1/2"H LARGER THAN THE OVERALL EXACT SIZE OF THE WINDOW. NEW CONSTRUCTION: CONFIRM THAT THE ROUGH OPENING IS AT LEAST 1/2"WX1/2"H LARGER THAN THE OVERALL EXACT SIZE OF THE WINDOW.

- 2. PREPARE THE OPENING: REPLACEMENT: CLEAN THE OPENING OF ANY DEBRIS. REMOVE PULLEYS, JAMB LINERS, WEATHER-STRIPPING, ANY OLD SCREEN HOOK EYES, OTHER PROTRUDING SCREWS OR FASTENERS. NEW CONSTRUCTION: INSTALL 6" ASPHALTED BUILDING PAPER AROUND EDGE OF WINDOW OPENING.
- 3. INSTALLATION: REPLACEMENT: FROM THE INSIDE OF THE BUILDING, PLACE THE NEW WINDOW INTO THE THE CAULKED OPENING TIGHTLY AGAINST THE STOOL AND USE SHIMS TO BLOCK THE WINDOW INTO THE OPENING. NEW CONSTRUCTION: FROM THE OUTSIDE OF THE BUILDING, PLACE THE NEW WINDOW INTO THE OPENING TIGHT AGAINST THE NAILING FIN. IF THE WINDOW OPENING IS NOT SQUARE, SQUARE THE WINDOW IN THE OPENING.
- 4. SET THE SHIMS: PLACE SHIMS UNDER THE SILL AT EACH CORNER, UNDER EACH MULLION, AT THE LOCATION OF EACH INSTALLATION SCREW ON THE BOTTOM AND THE TOP OF THE SIDE JAMB. A MINIMUM OF 3" PIECES OF SHIM SHOULD BE PLACED UNDER EACH SILL.
- 5. ADJUSTMENT: ADJUST THE SHIMS AND SIDE JAMB ADJUSTERS SO THE WINDOW IS STRAIGHT, LEVEL, PLUMB AND SQUARE. THE DIFFERENCE BETWEEN THE TWO DIAGONAL LINES SHOULD BE LESS THAN 1/4" OR USE SASHE(ES) TO VISUALLY CHECK THE SQUARE.
- 6. SECURING: REPLACEMENT: USE INSTALLATION SCREWS TO SECURELY FASTEN THE WINDOW. BE SURE ALL SASHES CAN BE OPERATED SMOOTHLY DURING THE SECURING PROCESS. INSTALL INTERIOR STOP AND CASING. INSTALL COIL TRIM AS NEEDED ON EXPOSED EXTERIOR WOOD. APPLY CAULKING (APPROXIMATELY 1/4" THICKNESS) EVENLY TO WHERE WINDOW MEETS WALL AND BLIND STOP. SEAL ALL GAPS BOTH INSIDE AND OUTSIDE WITH NOMINAL 3/8" DIAMETER SEALANT. NEW CONSTRUCTION: USE FRAMING NAILS AND NAILING FIN TO SECURELY FASTEN THE WINDOW (FOR WINDOWS WITH A "J" CHANNEL USE A PNEUMATIC/ELECTRIC NAIL GUN TO PREVENT DAMAGE). BE SURE ALL SASHES CAN BE OPERATED SMOOTHLY DURING THE SECURING PROCESS. INSTALL INTERIOR STOP AND CASING. INSTALL COIL TRIM AS NEEDED ON EXPOSED EXTERIOR WOOD. APPLY CAULKING (APPROXIMATELY 1/4" THICKNESS) EVENLY TO WHERE WINDOW MEETS THE WALL AND BLIND STOP. SEAL ALL GAPS BOTH INSIDE AND OUTSIDE WITH NOMINAL 3/8" DIAMETER SEALANT.



Project
40 LINWOOD STREET
Proposed Addition And Alterations
40 Linwood Street, Roxbury, MA 02119
41 Glen Avenue Newton, MA 02466
617.320.3749 hezpratt@aol.com

Title:

PROPOSED FRONT AND RIGHT SIDE ELEVATIONS

Scale: 1/4"=1'-0"

Revisions:

Drawn by: BLS


Approved by: HP

Project No.:

Date: 7-5-24

Drawing No.:



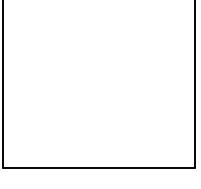

Architect
HEZEKIAH PRATT ARCHITECTURE + DESIGN
47 Glen Avenue Newton, MA 02460
617.320.3749 hezpratt@aol.com

Project
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40 Linwood Street, Roxbury, MA 02119

Title:

PROPOSED REAR AND LEFT SIDE ELEVATION

Scale: 1/4"=1'-0"

Revisions:

Drawn by: BLS


Approved by: HP


Project No.:

Date: 7-5-24

Drawing No.:


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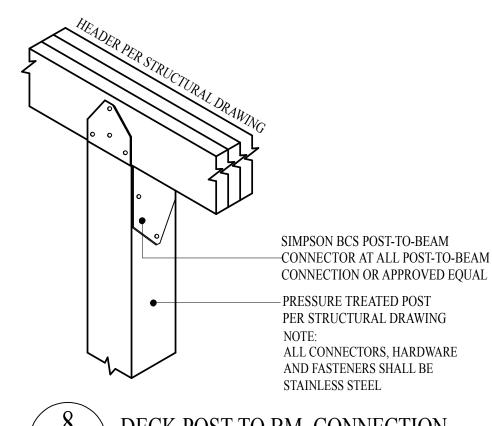
ALL LIGHT FIXTURES AT NEW RATED CEILING SHALL BE ONE

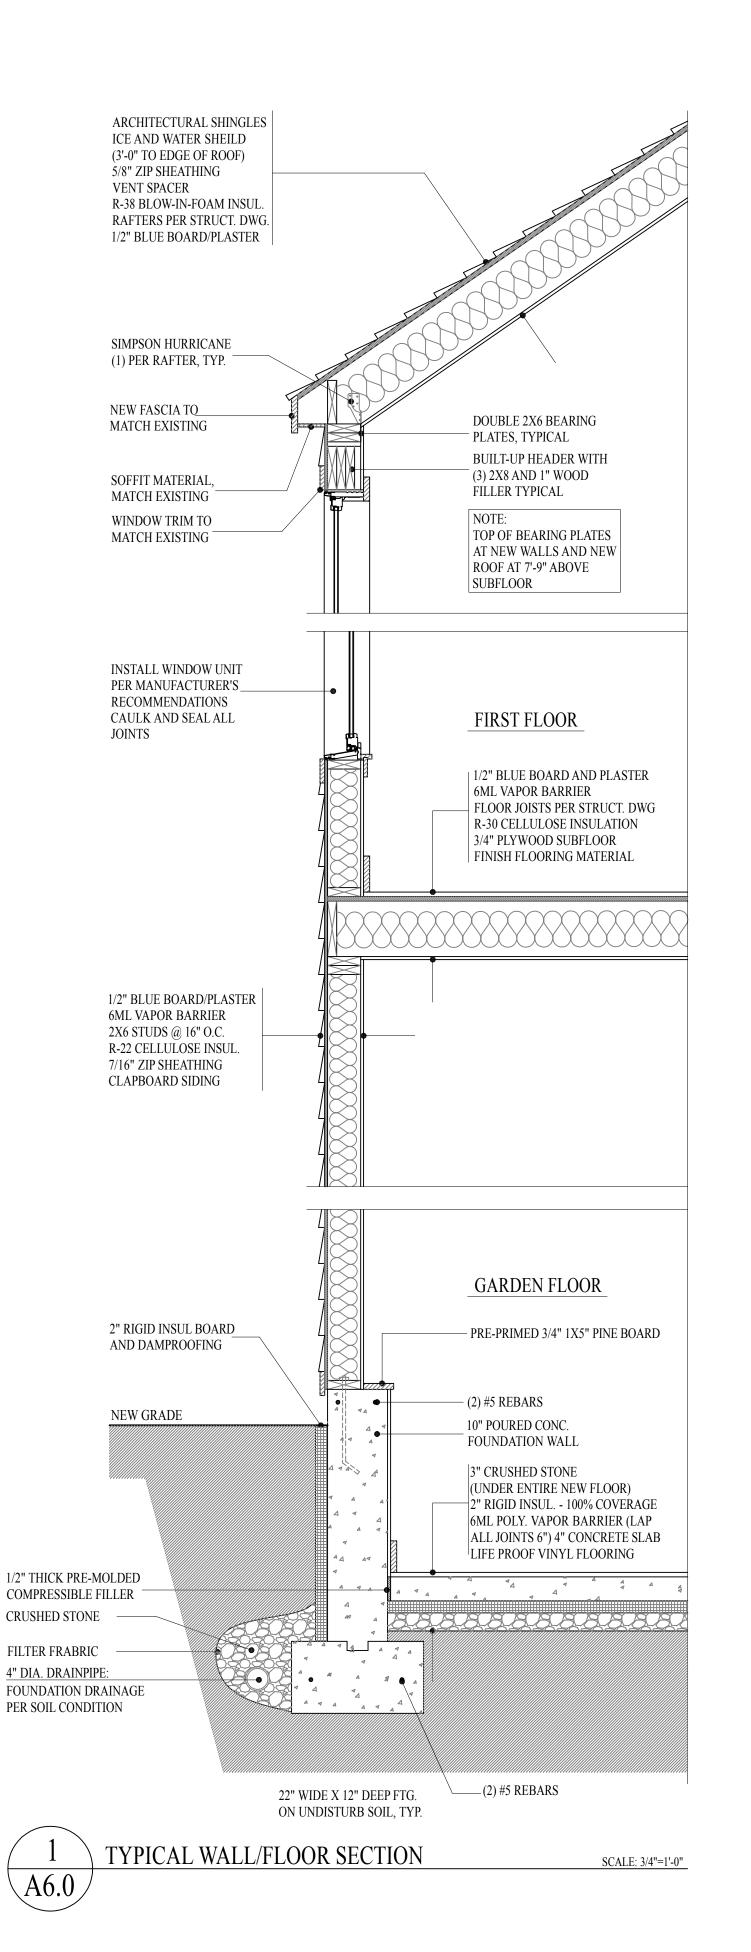HOUR FIRE RATED

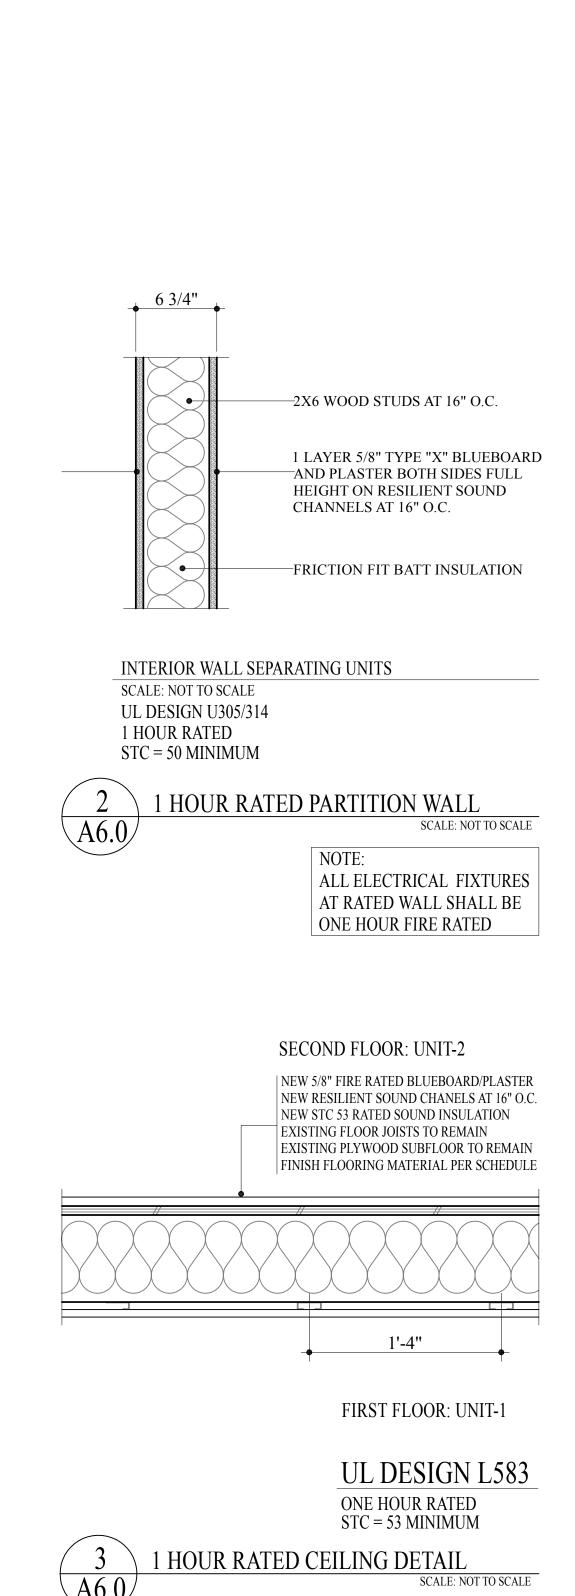


# PROPOSED ADDITION AND ALTERATIONS


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(10) DECK TO WALL FRAMING DETAIL
SCALE: N.T.S.
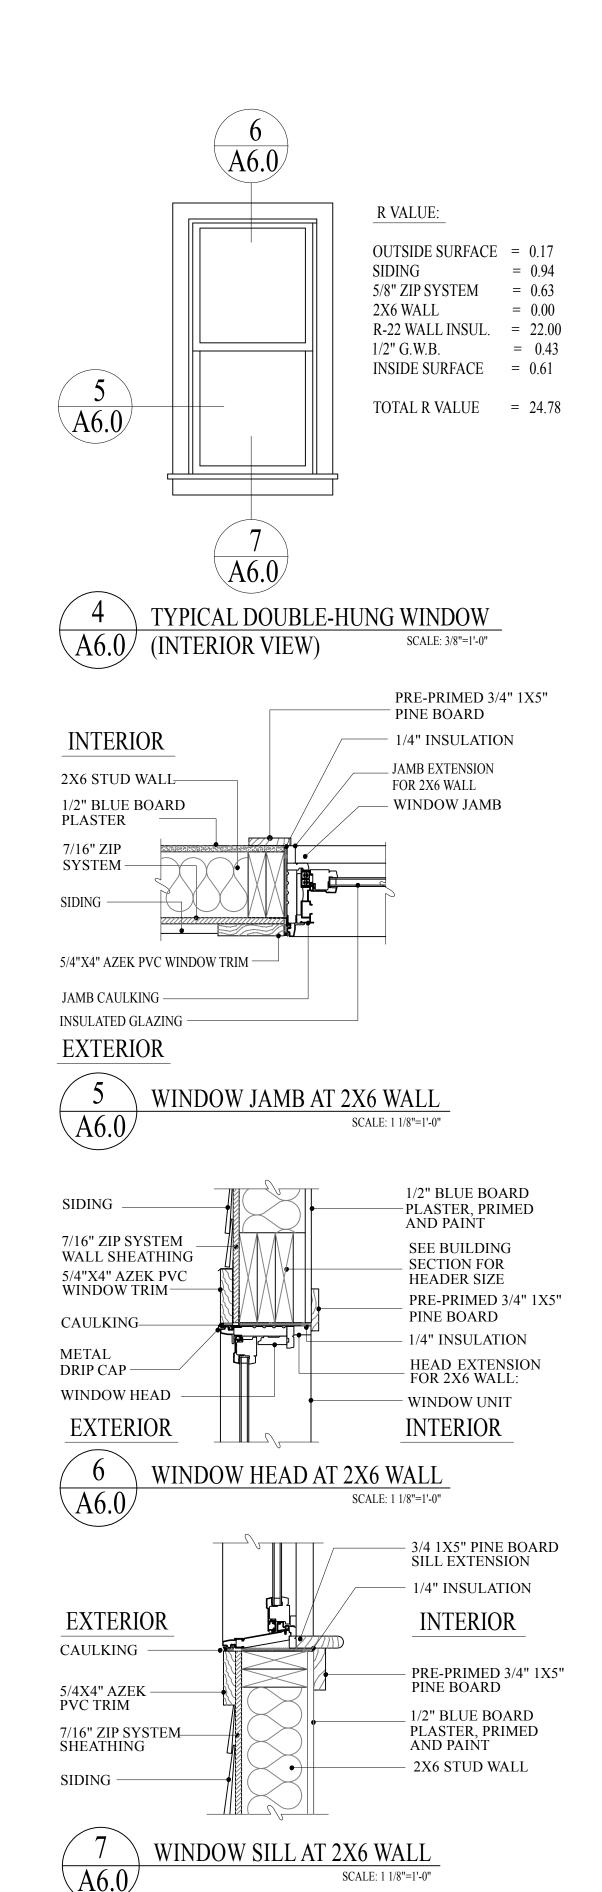
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Project
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Title:

TYPICAL WALL/FLOOR SECTION
AND WINDOW DETAILS

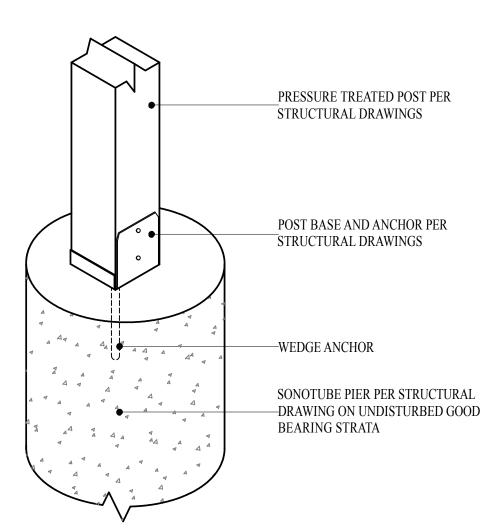Scale: AS NOTED

Revisions:

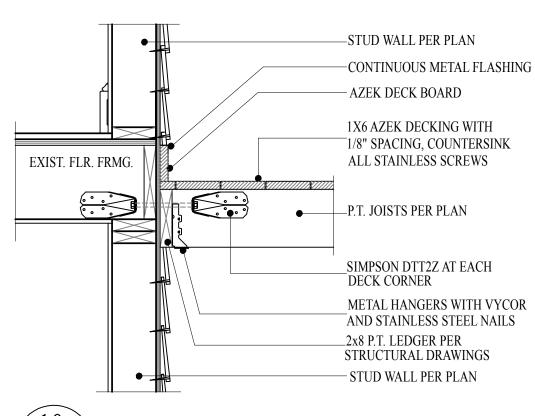Drawn by:
BLS

Approved by:
HP

Project No.:

Date: 7-5-24

Drawing No.:

A6.0

ROOM No.	ROOM NAME	FLOOR	BASE	WALL	CEILING	NOTES
01	BEDROOM-1	LIFE PROOF VINYL	WOOD	1/2" BLUE BOARD PLASTER	5/8" TYPE "X" BLUE BOARD/PLASTER	
02	BATHROOM	CERAMIC TILE	WOOD	1/2" BLUE BOARD PLASTER	5/8" TYPE "X" BLUE BOARD/PLASTER	
03	BEDROOM-2	LIFE PROOF VINYL	WOOD	1/2" BLUE BOARD PLASTER	5/8" TYPE "X" BLUE BOARD/PLASTER	
04	FAMILY ROOM	CERAMIC TILE	WOOD	1/2" BLUE BOARD PLASTER	5/8" TYPE "X" BLUE BOARD/PLASTER	
05	BEDROOM-3	LIFE PROOF VINYL	WOOD	1/2" BLUE BOARD PLASTER	5/8" TYPE "X" BLUE BOARD/PLASTER	
06	WORKROOM/EXERCISE SPACE	LIFE PROOF VINYL	WOOD	1/2" BLUE BOARD PLASTER	5/8" TYPE "X" BLUE BOARD/PLASTER	
07	UNIT-2 STORAGE/MECHANICAL	EXISTING CONCRETE	WOOD	1/2" BLUE BOARD PLASTER	5/8" TYPE "X" BLUE BOARD/PLASTER	
08	CEDAR CLOSET	LIFE PROOF VINYL	WOOD	1/2" BLUE BOARD PLASTER	5/8" TYPE "X" BLUE BOARD/PLASTER	
8A	UNIT-1 MECHANICAL	LIFE PROOF VINYL	WOOD	1/2" BLUE BOARD PLASTER	5/8" TYPE "X" BLUE BOARD/PLASTER	
09	MASTER BEDROOM	HARDWOOD	WOOD	1/2" BLUE BOARD PLASTER	5/8" TYPE "X" BLUE BOARD/PLASTER	
10	MASTER BATHROOM	CERAMIC TILE	WOOD	1/2" BLUE BOARD PLASTER	5/8" TYPE "X" BLUE BOARD/PLASTER	
11	WALK-IN-CLOSET	HARDWOOD	WOOD	1/2" BLUE BOARD PLASTER	5/8" TYPE "X" BLUE BOARD/PLASTER	
12	MASTER SUITE LOUNGE	HARDWOOD	WOOD	1/2" BLUE BOARD PLASTER	5/8" TYPE "X" BLUE BOARD/PLASTER	
13	LIVING AND DINING ROOM	HARDWOOD	WOOD	1/2" BLUE BOARD PLASTER	5/8" TYPE "X" BLUE BOARD/PLASTER	
14	BATHROOM	CERAMIC TILE	WOOD	1/2" BLUE BOARD PLASTER	5/8" TYPE "X" BLUE BOARD/PLASTER	
15	FOYER	HARDWOOD	WOOD	1/2" BLUE BOARD PLASTER	5/8" TYPE "X" BLUE BOARD/PLASTER	
16	LAUNDRY	CERAMIC TILE	WOOD	1/2" BLUE BOARD PLASTER	5/8" TYPE "X" BLUE BOARD/PLASTER	
17	FOYER	HARDWOOD	WOOD	1/2" BLUE BOARD PLASTER	5/8" TYPE "X" BLUE BOARD/PLASTER	
18	KITCHEN	HARDWOOD	WOOD	1/2" BLUE BOARD PLASTER	5/8" TYPE "X" BLUE BOARD/PLASTER	
19	LIVING AND DINING ROOM	EXISTING HARDWOOD	WOOD	1/2" BLUE BOARD PLASTER	5/8" TYPE "X" BLUE BOARD/PLASTER	
20	KITCHEN	EXISTING HARDWOOD	WOOD	1/2" BLUE BOARD PLASTER	5/8" TYPE "X" BLUE BOARD/PLASTER	
21	BEDROOM-1	EXISTING HARDWOOD	WOOD	1/2" BLUE BOARD PLASTER	5/8" TYPE "X" BLUE BOARD/PLASTER	
22	HALLWAY	EXISTING HARDWOOD	WOOD	1/2" BLUE BOARD PLASTER	5/8" TYPE "X" BLUE BOARD/PLASTER	
23	BATHROOM	CERAMIC TILE	WOOD	1/2" BLUE BOARD PLASTER	5/8" TYPE "X" BLUE BOARD/PLASTER	
24	MECHANICAL/LAUNDRY	CERAMIC TILE	WOOD	1/2" BLUE BOARD PLASTER	5/8" TYPE "X" BLUE BOARD/PLASTER	
25	BEDROOM-3	EXISTING HARDWOOD	WOOD	1/2" BLUE BOARD PLASTER	5/8" TYPE "X" BLUE BOARD/PLASTER	
26	MASTER BEDROOM	EXISTING HARDWOOD	WOOD	1/2" BLUE BOARD PLASTER	5/8" TYPE "X" BLUE BOARD/PLASTER	
27	WALK-IN-CLOSET	EXISTING HARDWOOD	WOOD	1/2" BLUE BOARD PLASTER	5/8" TYPE "X" BLUE BOARD/PLASTER	
28	BATHROOM	CERAMIC TILE	WOOD	1/2" BLUE BOARD PLASTER	5/8" TYPE "X" BLUE BOARD/PLASTER	
29	BEDROOM-4	EXISTING HARDWOOD	WOOD	1/2" BLUE BOARD PLASTER	5/8" TYPE "X" BLUE BOARD/PLASTER	

				DOOR SCHED	ULE					
DOOR No.	DOOR WIDTH	DOOR HEIGHT	THICKNESS	CONSTRUCTION TYPE	FINISH	FRAME MATERIAL	FIRE RATING	HARDWARE	NOTES	QUANTITY
1	3'-0"	6'-8"	1 3/4"	WOOD	PAINT	WOOD	N/A		FRENCH DOOR	2
2	2'-6"	6'-8"	1 3/8"	MASONITE	PAINT	WOOD	N/A		6-PANEL	19
2A	2'-4"	6'-8"	1 3/8"	MASONITE	PAINT	WOOD	N/A		6-PANEL	2
3	5'-0"	6'-8"	1 3/8"	MASONITE	PAINT	WOOD	N/A		6-PANEL	5
4	2'-0"	6'-8"	1 3/8"	MASONITE	PAINT	WOOD	N/A		6-PANEL	1
5	3'-0"	6'-8"	1 3/4"	WOOD	PAINT	WOOD	С		2 PANEL	3
6	5'-0"	6'-8"	1 3/4"	WOOD/GLASS	PAINT	WOOD	N/A		FRENCH DOOR	3
7	5'-0"	6'-8"	1 3/4"	WOOD/GLASS	PAINT	WOOD	N/A		FRENCH DOOR	2
8	3'-0"	6'-8"	EXISTING	EXISTING	PAINT	WOOD	N/A		EXISTING	1
8A	3'-0"	6'-8"	MATCH #8	МАТСН #8	PAINT	WOOD	N/A		MATCH #8	1
9	2'-6"	6'-8"	1 3/8"	MASONITE	PAINT	WOOD	N/A		POCKET DOOR	2
10	(2) 3'-0"	6'-8"	1 3/8"	MASONITE	PAINT	WOOD	N/A		POCKET DOORS	1
11	2'-0"	6'-8"	1 3/8"	MASONITE	PAINT	WOOD	N/A		2 PANEL	1
12	4'-0"	6'-8"	1 3/8"	MASONITE	PAINT	WOOD	N/A		2 PANEL	1
13	6'-0"	6'-8"	1 3/8"	MASONITE	PAINT	WOOD	N/A		FIXED LOUVRE	1
										TOTAL = 4

	WINDOW SCHEDULE														
WDW. No.	WINDOW UNIT	ТҮРЕ	SIZE	FRONT ELEV.	RIGHT ELEV.	LEFT ELEV.	REAR ELEV.	COLOR	REMAI	RKS	FIXED	OPERABLE	LEFT	RIGHT	TOTAL
1		DOUBLE-HUNG	3'-6"w x 5'-0"h	0	1	0	3	MATCH EXIST.	PELL LIFESTYLE			4			4
2		DOUBLE-HUNG	3'-0"w x 5'-0"h	1	7	7	3					18			18
2A		DOUBLE-HUNG	2'-0"w x 5'-0"h	0	0	1	0					1			1
3		DOUBLE-HUNG	3'-0"w x 4'-5"h	0	0	3	2					5			5
4		DOUBLE-HUNG	2'-6"w x 3'-6"h	2	1	0	0					3			3
5		DOUBLE-HUNG	3'-0"w x 3'-6"h	0	2	0	0					2			2
6		AWNING	3'-0"w x 3'-0"h	0	0	3	0					3			3
7		AWNING	3'-0"w x 1'-6"h	4	0	1	0					5			5
									ТОТ	TAL		41			

# PROPOSED ADDITION AND RENOVATIONS

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617.320.3749 hezpratt@aol.com

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Proposed Addition And Alterations
40 Linwood Street, Roxbury, MA 02119

Title:
SCHEDULES
C 1
Scale: N/A
Revisions:
Drawn by: BLS
Approved by:
Project No.:
Date: 7-5-24
Drawing No.:

A7.0

# CLOSET CLOSET BEDROOM-2 FUTURE PATIO BEDROOM-3 LOSET WORKROOM & CEDAR CLOS. EXERCISE SPACE UNIT-1 MECH. & MECHANICAL GARDEN LEVEL ELECTRICAL PLAN

**MASTER** BEDROOM

GAS FIREPLACE

**UNIT-1** 

FIRST FLOOR ELECTRICAL PLAN

UP


LIVING/DINING ROOM

\$3D \$3D

MASTER SUITE LOUNGE

# PROPOSED ADDITION AND ALTERATIONS

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GARDEN LEVEL AND FIRST FLOOR ELECTRICAL PLANS 1/4"=1'-0" Drawn by: Approved by: Project No.: 7-5-24

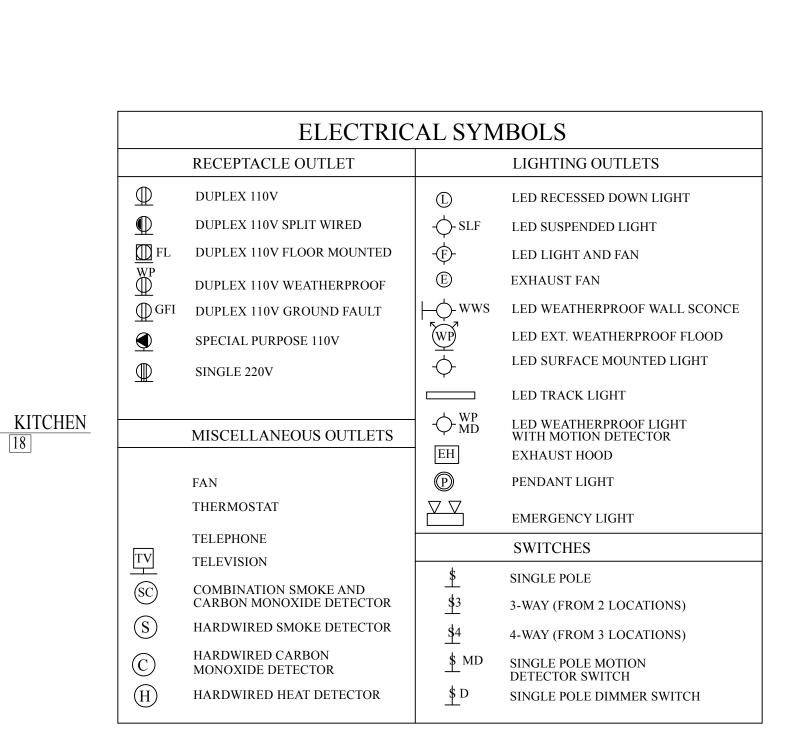E1.0

# DECK BELOW DECK OVER EPDM **ROOF BELOW MEMBRANE** $\bigoplus_{S3D}$ \$3D \$3D \$ LIVING/DINING ROOM **UNIT-2** BEDROOM-1 OPEN TO BELOW MECH./LAUND. 24

SECOND FLOOR ELECTRICAL PLAN
SCALE: 1/4"=1'-0"

# DECK BELOW **ROOF BELOW** DECK BELOW BEDROOM-3 **UNIT-2** ROOF BELOW BEDROOM-4 29

PROPOSED THIRD FLOOR PLAN
SCALE: 1/4"=1'-0"

A3.0

# PROPOSED ADDITION AND ALTERATIONS

DIMENSIONS:
ALL DIMENSIONS, CALCULATIONS OR OTHER DATA PERTAINING
TO THE WORK OF ALL TRADES SHALL BE CAREFULLY CHECKED
BEFORE MANUFACTURE, FABRICATION OR INSTALLATION OF ANY
PORTION OF THE WORK BEFORE IT IS COMMENCED. ANY
DISCREPANCIES DISCOVERED SHALL BE REPORTED IMMEDIATELY
TO THE ARCHITECT FOR HIS DECISION. ALL WORK SHOWN ON THE
DRAWINGS IS INTENDED TO BE CORRECT ACCORDING TO THE SCALE,
BUT FIGURED DIMENSIONS AND DETAIL DRAWINGS ARE IN ALL CASES
TO BE FOLLOWED. THE CONTRACTOR SHALL VERIFY ALL DIMENSIONS
AT THE SITE, REGARDLESS OF DIMENSIONS SHOWN ON DRAWINGS.
HE SHALL BE RESPONSIBLE FOR ALL WORK AFFECTED BY THIS
PROVISION.


	ELECTRIC	AL SYM	IBOLS
	RECEPTACLE OUTLET		LIGHTING OUTLETS
$\oplus$	DUPLEX 110V	(L)	LED RECESSED DOWN LIGHT
$lue{\mathbb{Q}}$	DUPLEX 110V SPLIT WIRED	- <b>\(\rightarrow\)</b> -SLF	LED SUSPENDED LIGHT
FL	DUPLEX 110V FLOOR MOUNTED	- <del>(</del> F)-	LED LIGHT AND FAN
$\bigoplus^{\mathrm{WP}}$	DUPLEX 110V WEATHERPROOF	Œ	EXHAUST FAN
<u></u> GFI	DUPLEX 110V GROUND FAULT	⊢ <u></u> wws	LED WEATHERPROOF WALL SCONCE
	SPECIAL PURPOSE 110V	WP	LED EXT. WEATHERPROOF FLOOD
$\bigcirc$	SINGLE 220V	$\overline{\phi}$	LED SURFACE MOUNTED LIGHT
<u></u>			LED TRACK LIGHT
	MISCELLANEOUS OUTLETS	-\$\rightarrow\text{WP}\text{MD}	LED WEATHERPROOF LIGHT WITH MOTION DETECTOR
		EH	EXHAUST HOOD
	FAN	P	PENDANT LIGHT
	THERMOSTAT		EMERGENCY LIGHT
	TELEPHONE		SWITCHES
TV	TELEVISION	<b>\$</b>	SINGLE POLE
SC	COMBINATION SMOKE AND CARBON MONOXIDE DETECTOR	\$3	
$\bigcirc$			3-WAY (FROM 2 LOCATIONS)
(3)	HARDWIRED SMOKE DETECTOR	\$4	4-WAY (FROM 3 LOCATIONS)
(C)	HARDWIRED CARBON MONOXIDE DETECTOR	<u>\$</u> MD	SINGLE POLE MOTION DETECTOR SWITCH
$\bigcirc$ H	HARDWIRED HEAT DETECTOR	<u>\$</u> D	SINGLE POLE DIMMER SWITCH

Architect
HEZEKIAH PRATT ARCHITECTURE + D
47 Glen Avenue Newton, MA 02460
617.320.3749 hezpratt@aol.com


Title:	
SECOND AND T FLOOR ELECTE PLANS	
Scale:	1/4"=1'-0"
Revisions:	
Drawn by:	BLS
Approved by:	НР
Project No.:	
Date:	7-5-24
Drawing No.:	

Project
40 LINWOOD STREET
Proposed Addition And Alterations
40 Linwood Street, Roxbury, MA 02119

**E2.0** 

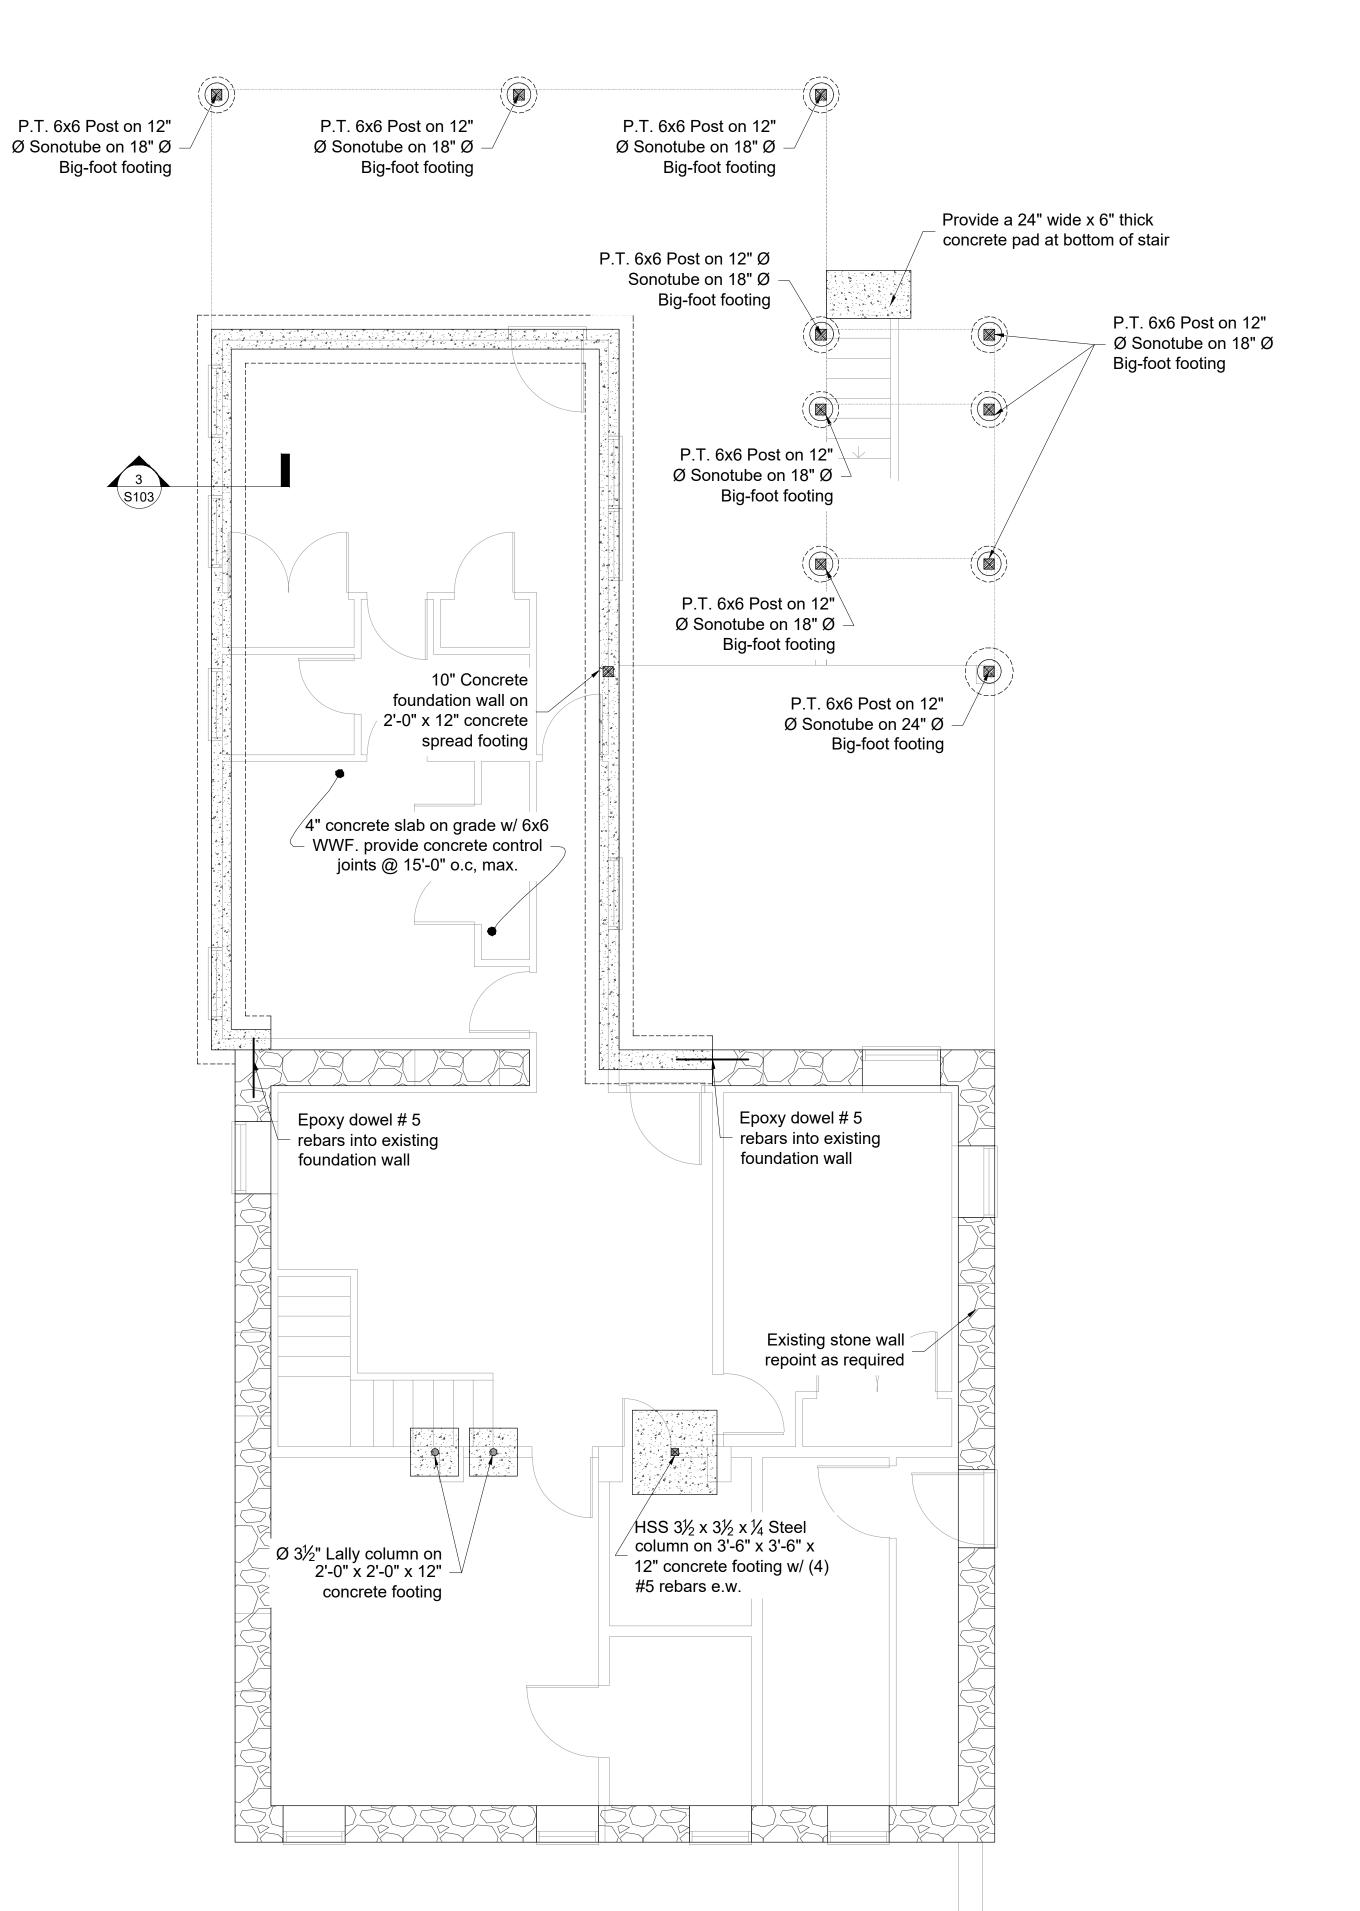

1 Foundation Plan  $\frac{1}{\frac{1}{4}}$ " = 1'-0"

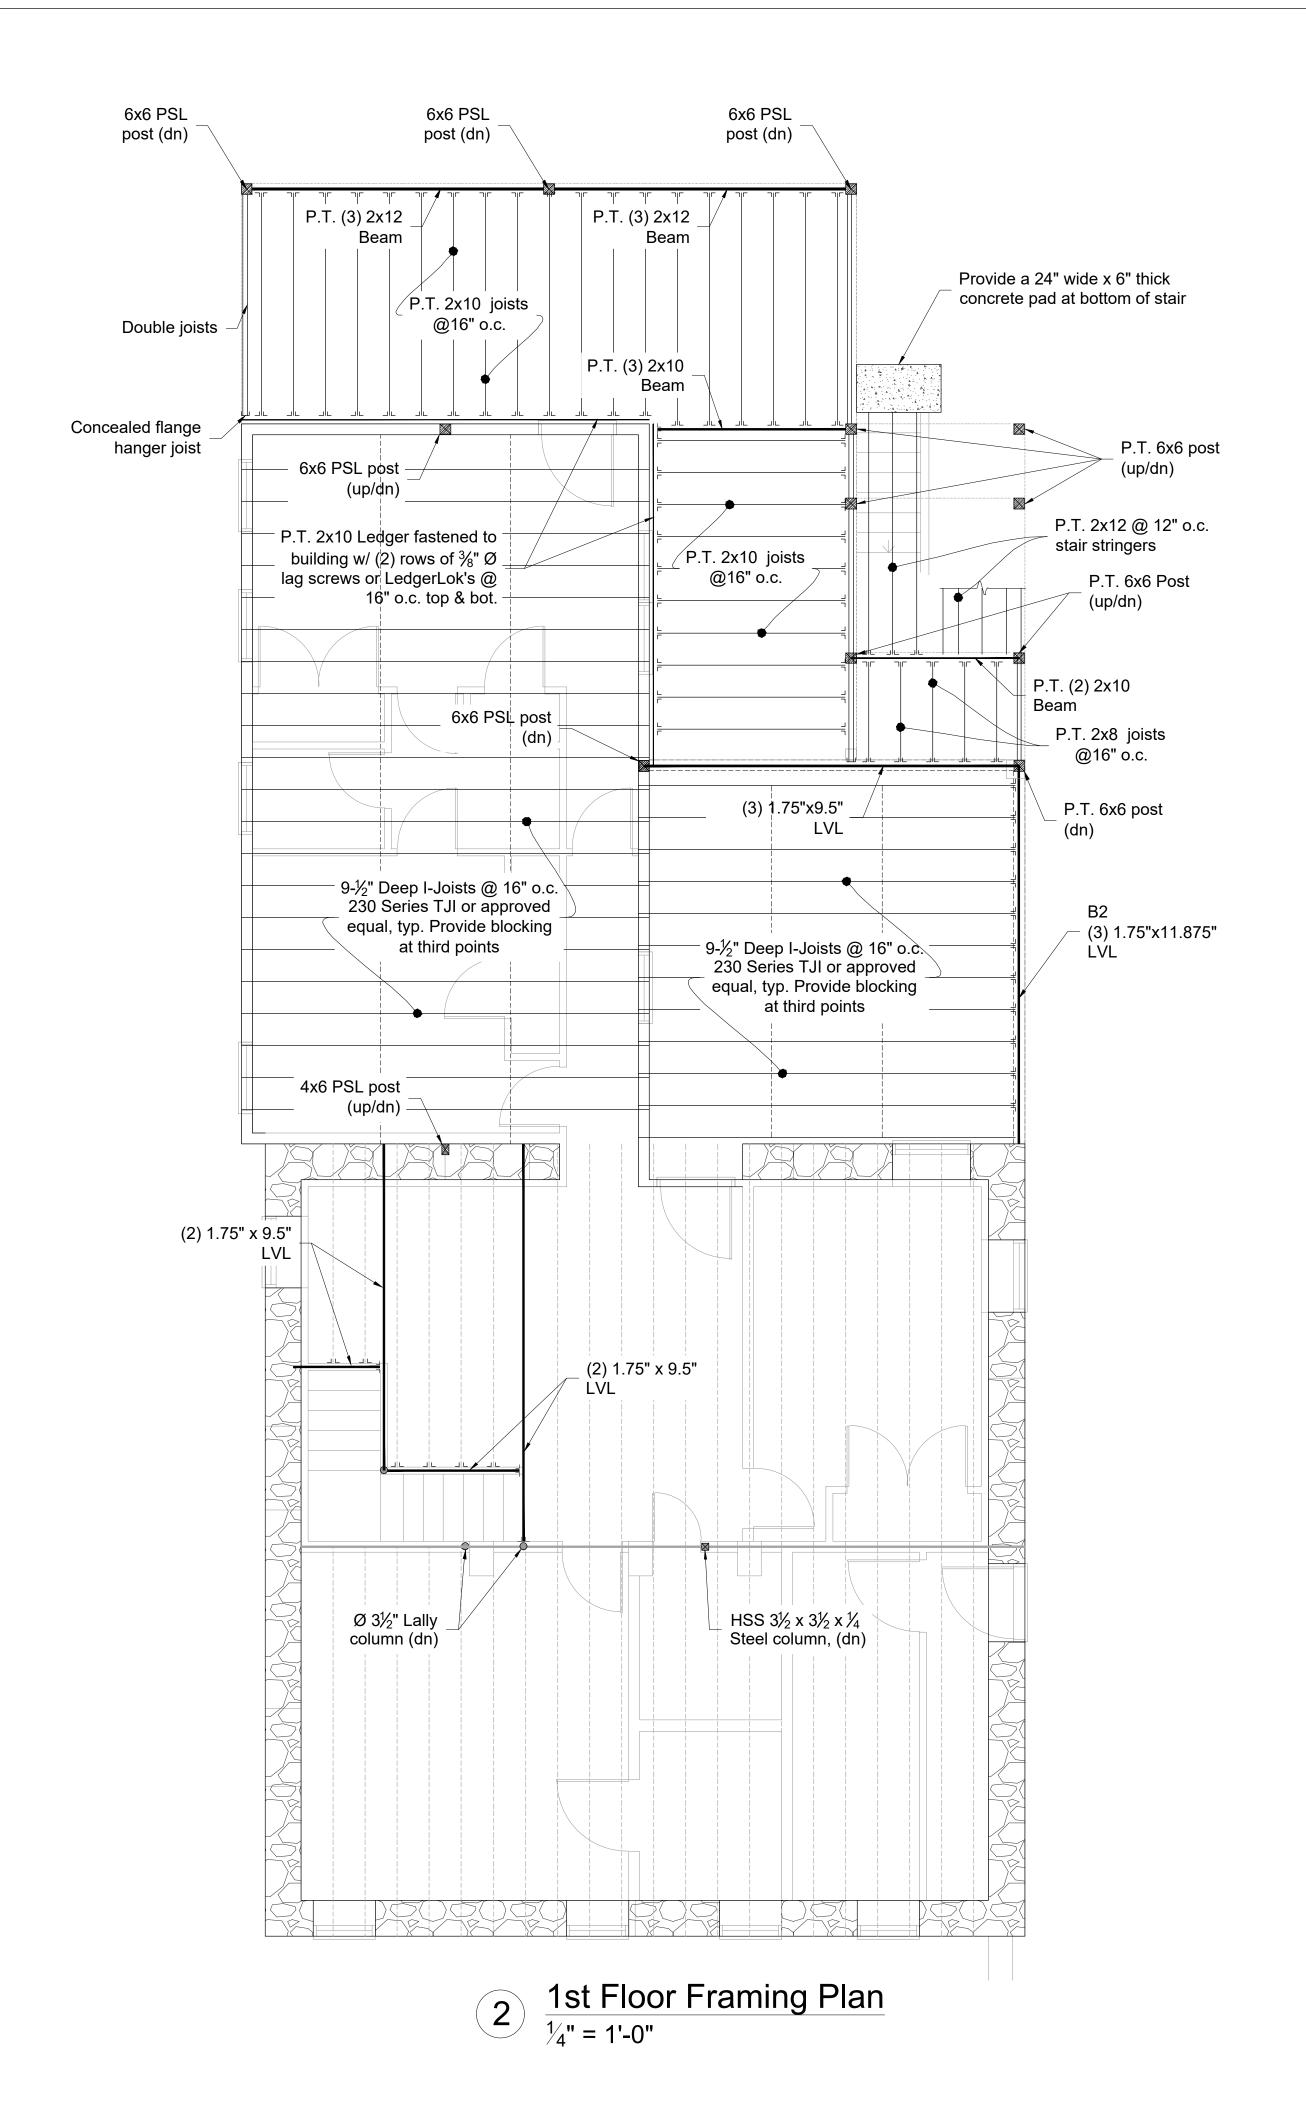

Berdi
Consulting
Structural
Engineering

Tel: (508) 308-9012

40 Linwood St
Roxbury,

Boston, MA

25 Wayland Hills Rd.

Wayland, MA 01778

FRAMING PLANS


PERMIT SET



Scale: ½" = 1'-0"

Date: 2024-07-02

S101

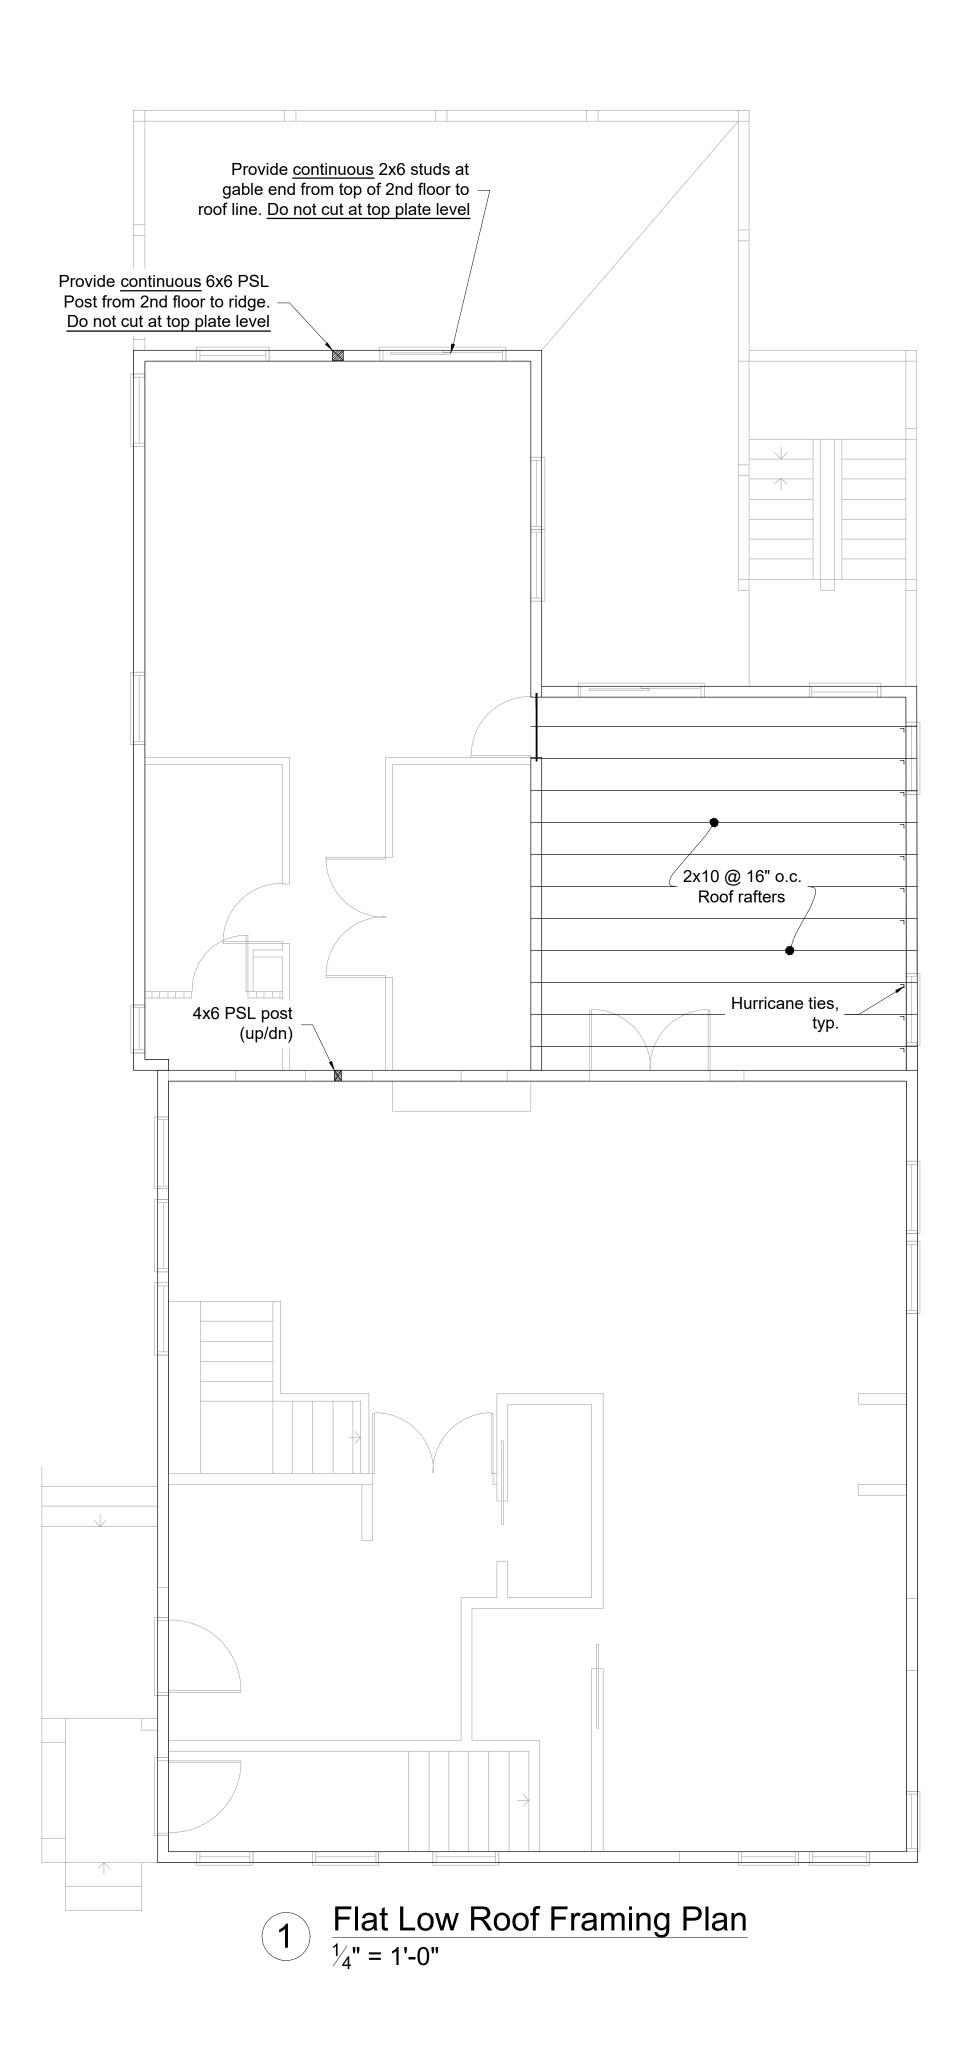

Provide continuous 2x6 studs at gable end from top of 2nd floor to roof line. Do not cut at top plate level P.T. 2x8 joists @16" o.c. P.T. (2) 2x10 Provide continuous 6x6 PSL P.T. 6x6 post Post from 2nd floor to ridge. P.T. 6x6 post Do not cut at top plate level P.T. (3) 2x10 Hurricane ties, P.T. 6x6 post Hurricane ties, P.T. 2x12 @ 12" typ. o.c. stair stringers typ. P.T. 6x6 post P.T. (2) 2x10 P.T. 2x8 joists Beam \_\_\_\_2x10 @ 16" o.c. \_ @16" o.c. Concealed flange Roof rafters hanger joist Secure deck to roof framing with
Simpson LSTA P.T. 2x6 Deck sleepers straps installed along the flat (2) 1.75" x 24" LVL or (3) 1.75" x 20" LVL roof slope Ridge beam Provide sloped cricket to allow  $^{ackslash}$  water drainage  $^{ackslash}$ Raised double P.T. rim \_ board. Raise board to allow water drainage -Secure deck to roof framing with Simpson LSTA straps 4x6 PSL post (dn) (2) 1.75" x 9.5" LVL 4x6 PSL post (up) 6x6 PSL Post (dn) 6x6 PSL Post (dn) (3) 1.75" x 9.25" LVL B3 and B4 <u>shall not</u> be continuous. Cut 6x6 PSL Post (dn) at support (4) 1.75" x 16" LVL Low Roof Framing Plan  $\frac{1}{4}$ " = 1'-0"

Berdi Consulting Structural

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40 Linwood St Roxbury, Boston, MA

FRAMING PLANS


PERMIT SET



Scale: ½" = 1'-0"

Date: 2024-07-02


S102

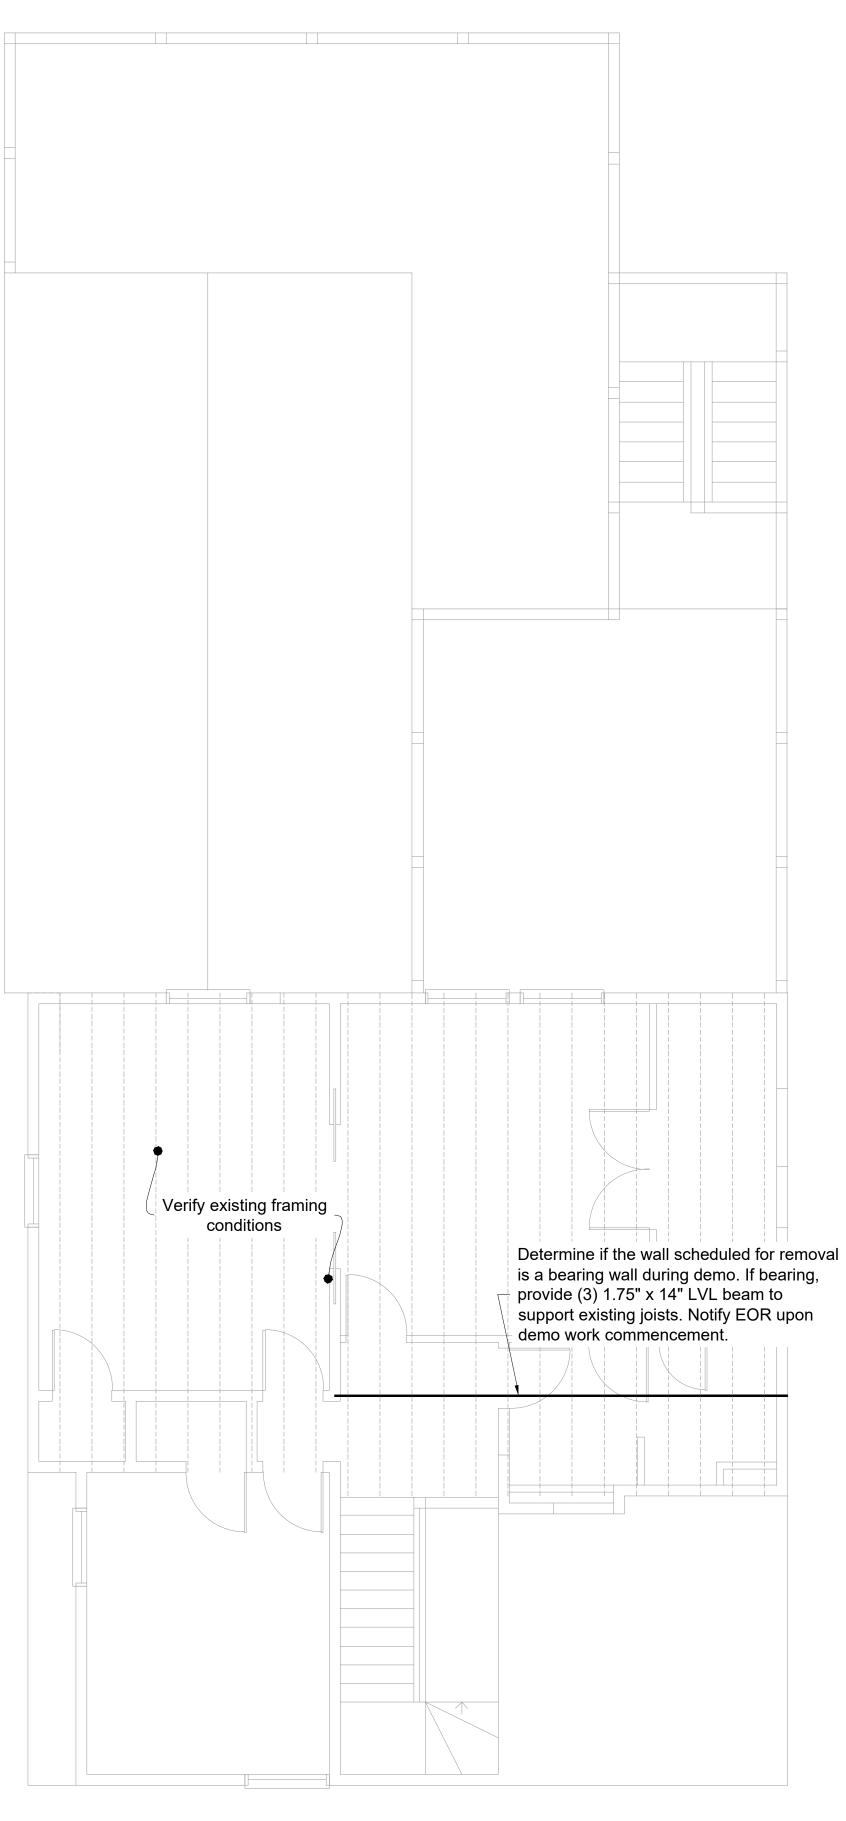


1  $\frac{3\text{rd Floor Ceiling Joists}}{\frac{1}{4}\text{"} = 1\text{'}-0\text{"}}$ 

### **GENERAL NOTES:**

- 1. All work shall conform to Massachusetts Building Code and all Federal, State and City of Boston laws, codes and regulations as each may apply.
- 2. The total liability of Berdi Consulting for any claims arising out of the services performed under this contract shall be limited to a maximum of the net fees received by Berdi Consulting.
- 3. All existing conditions must be verified in field. If discrepancies are found, they have to be reported to the Engineer prior to start of work. Omissions or conflicts between the various elements of the working drawings and/or the specifications shall be brought to the attention of the Engineer prior to the start of
- 4. The contractor shall be responsible for coordinating the scheduling and work of all trades and shall check all dimensions. All discrepancies shall be called to the attention of the Engineer and shall be resolved prior to proceeding with the work.
- 5. The Contractor shall supervise and direct the work and shall be solely responsible for the construction
- means, methods, techniques, sequences and procedures, including but not limited to bracing and shoring. 6. The Contractor agrees that in accordance with generally accepted construction practices, the Contractor shall assume sole and complete responsibility for the job site conditions during the course of construction, including the safety of all persons and property, and that this requirement shall apply continuously and not be limited to normal working hours.
- 7. All work shall be performed in a first class and workmanlike manner in conformity with the plans and specifications, and shall be in good usable condition at the completion of the Project.
- 8. The Contractor shall field verify all existing conditions, utility locations and structure placement, prior to start of the work. The Contractor will observe all possible precautions to avoid damage to same. Any damage to existing structures and utilities, whether shown or not on the drawings, shall be repaired or replaced at the Contractor's expense.
- 9. Prior to bidding the work the Contractor shall visit the site and thoroughly review the actual conditions and quantities, if any. No claim against the Owner or Engineer will be allowed for any excess or deficiency therein, actual or relative.
- 10. Contractor is responsible for all demolition and relocation works, if any.

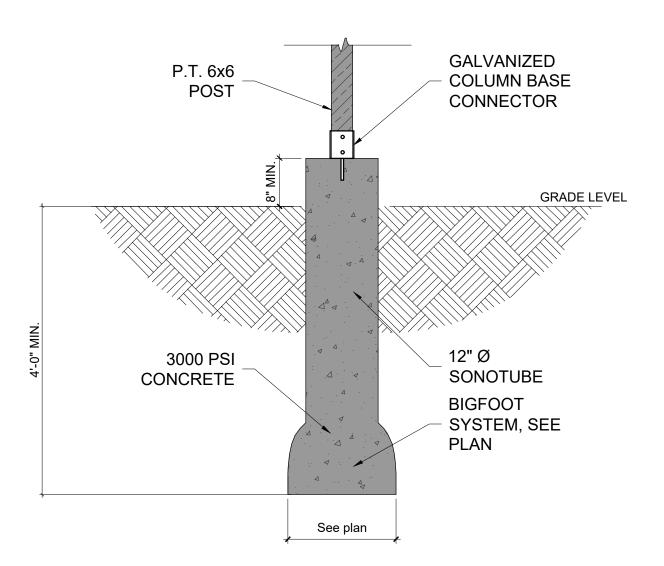

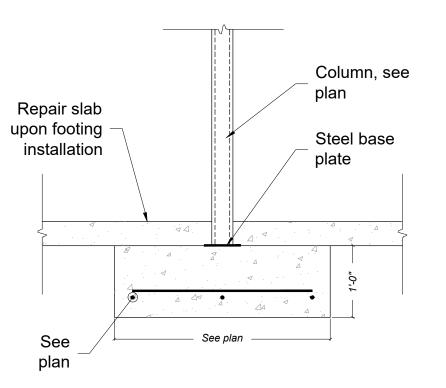

3 Column on Footing

### STRUCTURAL NOTES:

- 1. All loads and loading conditions are per IRC 2015 (9th Edition of Massachusetts Building Code).
- 2. Contractor shall verify all dimensions.
- 3. Concrete shall be  $f_c = 3000$  psi, min.
- 4. Foundation designed based on assumed allowable soil bearing pressure of 2000 psf.
- 6. All exterior walls shall 2x6 @ 16" o.c.
- 5. All rebar shall be  $f_v = 60$  ksi.
- 7. All members designated as 1.75" x \_\_\_\_" shall be LVL beams.
- 8. All members designated as 2x \_\_\_\_ shall be dimensional lumber.
- 9. All dimensional lumber shall be spruce-pine-fir:
- 9.1.  $F_b = 875 \text{ psi.}$ 9.2.  $F_v = 135 \text{ psi.}$
- 9.3. F<sub>c[par]</sub> = 425 psi. 9.4. No. 1/ No. 2 or better
- 10.LVL plies shall be  $F_b = 3100$  psi, PSL's shall be  $F_b = 2650$  psi, min.
- 11. All header sizes shall be in accordance with 2015 IRC, U.N.O.
- 12. Number of jack studs shall be in accordance with 2015 IRC, U.N.O.
- 13. Exterior walls shall be sheathed w/  $\frac{7}{16}$ " plywood or OSB. 14. All floors shall be sheathed w/  $\frac{23}{32}$ " plywood or OSB, U.N.O.
- 15. Roof shall be sheathed with  $\frac{5}{8}$ " plywood or OSB, U.N.O.
- 16. All LVL headers shall be supported by 4x6 PSL posts, U.N.O.
- 17. All LVL girders shall be supported by 4x6 PSL posts, U.N.O.. 18. Apply (2) 2x joists under new partition walls which are parallel to framing.
- 19. Provide blocking under partition walls which are perpendicular to direction of framing.
- 20. Provide hurricane ties at roof rafters.
- 21.PSL posts which extend multiple floors shall be braced on all sides at each level.
- 22. Miscellaneous steel shall be  $f_v = 36$  ksi.
- 23.HSS shapes shall be  $f_v = 46$  ksi.
- 24. Electrodes for all shop and field welding shall be grade E-70.

### **DECK NOTES:**

- 1. Contractor is responsible for all demolition, shoring, and relocation works,
- 2. All wood to be pressure treated, No.2 or better.
- 3. All connectors to be galvanized.
- 4. Concrete shall be f'c = 3000 psi.
- 5. Deck boards shall be attached to each joist with two nails or deck screws.
- 6. Provide hold-down tension device min. capacity 750 lb. at 4 locations evenly distributed along each side of the deck with 1 within 2' of each end of
- the ledger.



Consulting

Structural

Engineering 25 Wayland Hills Rd. Wayland, MA 01778 Tel: (508) 308-9012

40 Linwood St Roxbury, Boston, MA

> FRAMING **PLANS**

PERMIT SET



Scale:  $\frac{1}{4}$ " = 1'-0" Date: 2024-07-02

S103

Architect
HEZEKIAH PRATT ARCHITECTURE + DESIGN
47 Glen Avenue Newton, MA 02460
617.320.3749 hezpratt@aol.com

Project
40 LINWOOD STREET
Proposed Addition And Alterations
40 Linwood Street, Roxbury, MA 02119

Title:	
TREES TO BE I	REMOVED
Scale:	AS NOTED
Revisions:	
Drawn by:	BLS
Approved by:	НР
Project No.:	
Date:	9-8-25
Drawing No.:	

SK1.0

### Tree Removal Report

Project Address:	40 Linwood Street, Roxbury, MA 02119
Applicant:	Andaz Construction Corporation
Prepared For:	Boston Landmarks Commission & Highland Park Architectural Commission
Prepared By:	Mark Williams

### Purpose

This report documents the removal of nine existing trees at 40 Linwood Street, Roxbury, MA 02119. The removals were carried out based on the professional recommendation of the City Arborist due to tree health, safety hazards, and conflicts with the proposed building addition and site improvements. All trees removed will be replanted in accordance with the Arborist's recommendations and the Highland Park Architectural Commission's guidelines.

#### Tree 1 – Oak Tree

Location: Rear yard, centered in the footprint of the new building addition and deck.

Size: Approximately 4' 8" radius at the base.

**Condition:** Declining health; dropping large limbs, creating holes in the roof, breaking windows, and harboring bee infestations in summer.

**Reason for Removal:** Located directly within the footprint of the new addition. Created significant safety and structural hazards. Arborist recommended full removal.

Mitigation: To be replaced with a healthy oak tree, location to be coordinated with Arborist and Commission.

#### Tree 2 - Pine Tree

**Location:** Approximately 10 feet off the right side of the former garage (since demolished).

Size: Approximately 2.75' radius, ~40 feet tall.

**Condition:** Root system heaving sidewalks and grading, creating trip hazards and drainage issues. Also caused water intrusion and roof damage to adjacent structures.

**Reason for Removal:** Blocked new driveway installation and access for construction vehicles. Risk to retaining wall installation and site circulation. Arborist noted fair health but anticipated decline due to root disturbance during construction.

**Mitigation:** To be replaced with an appropriate evergreen species at an alternate location per Arborist's quidance.

### Tree 3 – Maple Tree

Location: Rear right corner of lot, entangled with fencing along neighbor's driveway.

Size: Approximately 18" radius.

Condition: Root system uplifting driveway and fencing, causing structural conflicts.

**Reason for Removal:** Long-term damage to abutting property. Interference with grading and retaining wall work.

Mitigation: Replacement onsite with a like-kind maple tree, as recommended by Arborist and Commission.

#### Tree 4 – Pine Tree

Location: Rear yard, adjacent to proposed driveway and retaining wall.

Size: Approximately 2.75' radius, ~40 feet tall.

**Condition:** Structurally sound but vulnerable to excavation impacts from adjacent oak removal and retaining wall construction.

**Reason for Removal:** Conflict with new grading and retaining walls. Arborist determined survival unlikely due to root zone disturbance.

**Mitigation:** To be replaced with an appropriate species in a suitable onsite location.

### Trees 5 & 6 - Maple Trees

**Location:** Far left rear corner of property. **Size:** Approximately 12"–15" radius each.

**Condition:** Generally healthy but entangled, dropping limbs onto abutting property, and vulnerable to excavation-related root disturbance.

**Reason for Removal:** Obstructed alignment of proposed new driveway. Arborist anticipated decline following adjacent construction. Removal of nearby oak and pine would destabilize site conditions.

**Mitigation:** Replacement with Commission-approved shade trees to restore canopy coverage while supporting new site layout.

### Trees 7, 8 & 9 – Non-Significant Trees

Location: Right side of driveway between 40 and 42 Linwood Street, interwoven with shared fence line.

Size: 8"-12" diameter.

**Condition:** Overgrown, diseased, and non-significant species. One severely rotted; all entangled in fencing with minimal canopy value.

**Reason for Removal:** Fence removal required for construction access. Arborist identified invasive/declining species with limited preservation value. Excavation for new addition, driveway, and retaining walls would accelerate decline.

**Mitigation:** These trees are not considered landmark-quality. Replacements will be incorporated into the site restoration and replanting plan.

### Summary & Mitigation Plan

All removals at 40 Linwood Street were carried out in accordance with the City Arborist's recommendations to address public safety, structural hazards, and conflicts with proposed improvements. Replacement trees will be provided as part of the replanting plan, with species and locations to be finalized in consultation with the

Arborist and the Highland Park Architectural Commission.

Respectfully submitted,

Mark Williams Andaz Construction Corporation