# SINGLE FAMILY INTERIOR RENOVATION

# 384 MARLBOROUGH STREET, BOSTON MA 02115

## BOSTON ZONING GISS MAP



https://acortar.link/2KcDL2

## EXISTING FRONT FACADE



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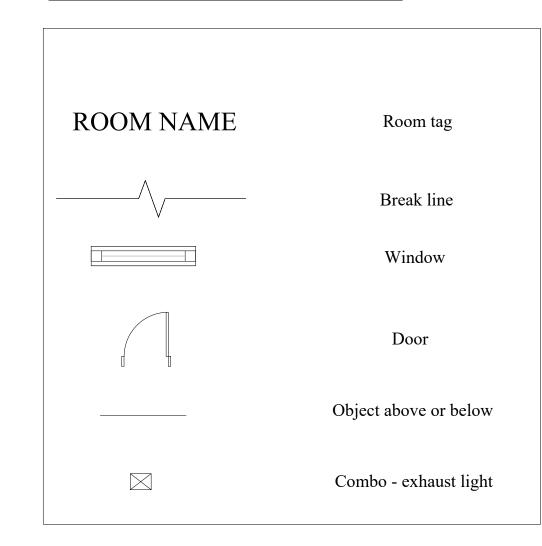
## GENERAL NOTES

- 1. All work shall be performed in conformance to the latest edition of the massachusetts state building code and all other applicable codes.
- 2. The contractor is responsible for obtaining and paying for all permits required for this project.
- 3. The contractor is solely responsible for means, methods, techniques, sequencing, scheduling and safety for this project.
- 4. The contractor shall visit the site and be thoroughly aquatinted with the project prior to submitting a price. additional money will not be granted for work not clarified prior to bidding.
- 5. The contractor shall report any discrepancies between drawings specifications or field conditions to this office immediately.
- 6. The contractor is responsible for repairing any work damaged by his forces while performing this
- 7. The contractor shall give a warranty for his work for a period of one year from the date of final completion.
- inconsistencies immediately upon discovery and before proceeding with the work.

8. All dimensions and conditions shall be field verified, and this office shall be notified of

9. Take field measurements before fabrication work to ensure that components fit together properly.

## GENERAL SYMBOLS



## ZONING

Zoning district:	Boston Proper
Zoning subdistrict:	H-3-65
Subdistrict type:	Apartment Residential
Overlays:	Groundwater Conservation Overlay Distric
Map NO:	1
Article:	Underlying Zoning

## ASSESSOR'S REPORT

Parcel ID:	0503608000
Property type:	One family
Classification code:	0101 (Residential Property/Single Fam Dwelling)
Lot size:	2,576 sq ft

	DISTRICT	TYPE OF USE	LOT SIZE minimum (sq. ft.)	LOT AREA minimum (sq. ft.)	LOT WIDTH minimum (Feet)	FLOOR AREA RATIO maximum	Build Heig Stories	_	USABLE OPEN SPACE minimum (sq. ft.)	FRONT YARD Minimum Depth (Feet) (14)	SIDE YARD Minimum Width (Feet)	REAR YARD Minimum Depth (Feet)	SET BACK PARAPET minimum distance from lot line	REAR YARD maximum % occup. by accessory buildings
							Siories	rect	(84. 11.)	(reet)	(reet)		Hom for time	buildings
		ANY DWELLING	NONE	NONE	NONE	3.0	-	65 <sup>(9)</sup>	50	(10)	(4)	25% of lot depth all use	<u>H + L</u> 1 (9)	40
	H-3-65	OTHER USE	NONE	NONE	NONE	3.0	-	65 <sup>(9)</sup>	NONE	(10)	(4)	acpoint and asc	all uses	40
EXISTING			N/A	N/A	N/A	N/A	-	50	N/A	N/A	N/A	N/A	N/A	N/A
PROPOSED		ONE FAMILY	N/A	N/A	N/A	N/A	-	50.6*	N/A	N/A	N/A	N/A	N/A	N/A

\*PROPOSED ROOF DECK

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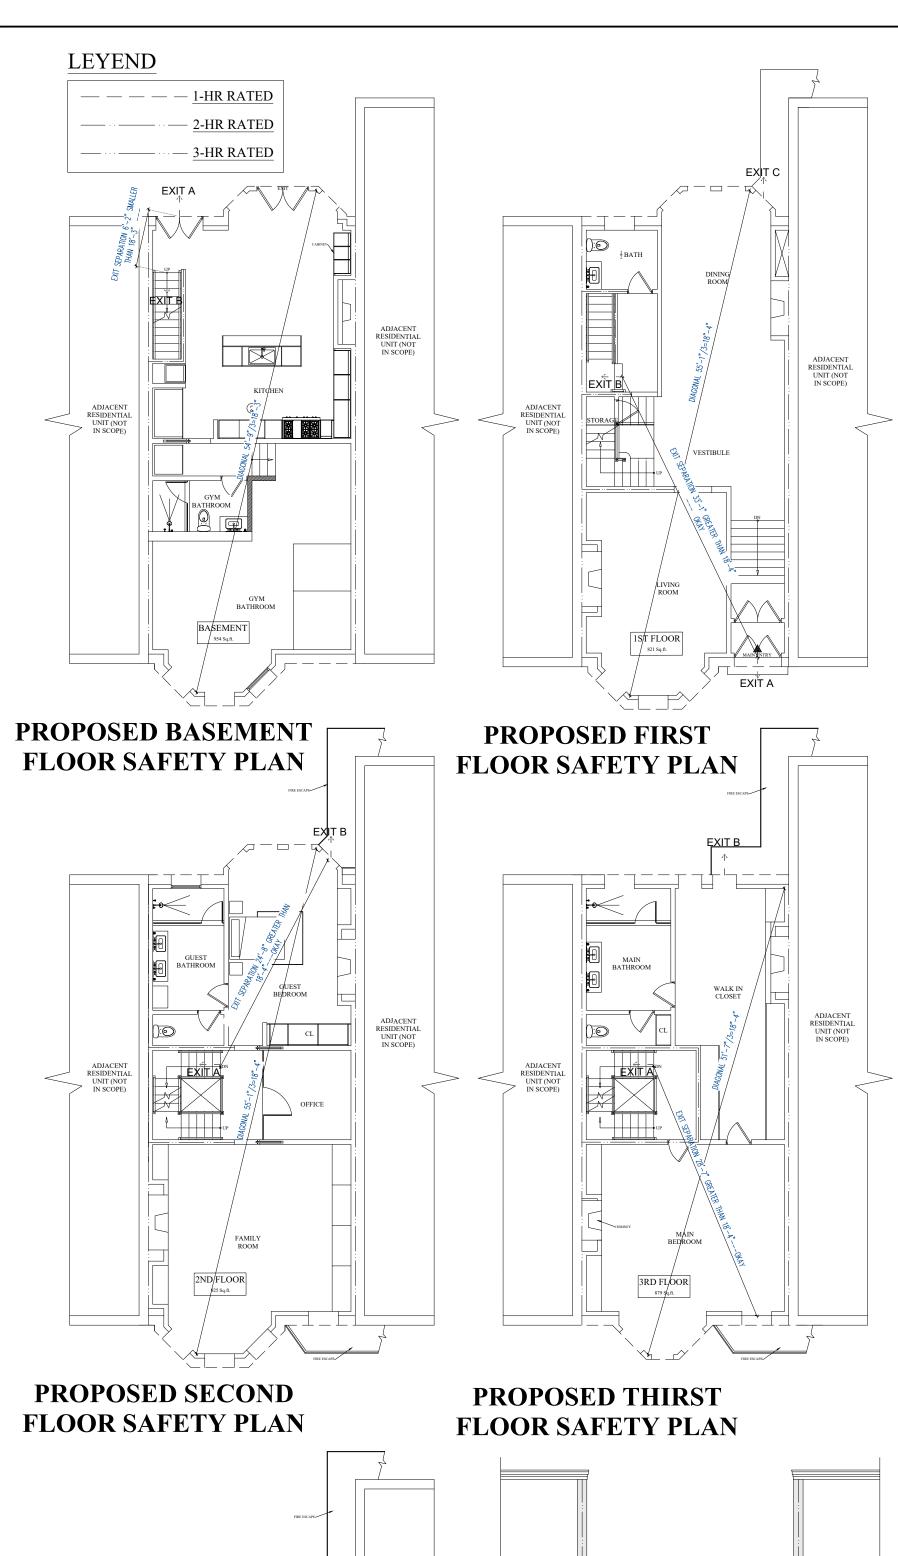
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DRAWING TITLE:

**COVER SHEET** 

SHEET NUMBER:

A-0.0



## **GENERAL NOTES**

- 1. ALL WORK SHALL CONFORM TO THE IBC / 2015 REQUIREMENTS AND ITS APPLICABLE REFERENCED STANDARDS
- 2. IT IS THE RESPONSIBILITY OF THE GENERAL CONTRACTOR TO VERIFY ALL EXISTING CONDITIONS AND DIMENSIONS AS THEY RELATE TO NEW CONSTRUCTION, REPORT TO THE ARCHITECT / ENGINEER ALL OBSERVATIONS AND ANY DISCREPANCIES BEFORE PROCEEDING WITH ANY WORK.
- 3. CONTRACTOR TO VERIFY DIMENSIONS PRIOR TO CONSTRUCTION
- 4. CONTRACTOR SHALL SHORE, BRACE OR OTHERWISE SUPPORT THE STRUCTURE AS REQUIRED IN ORDER TO MAINTAIN STRUCTURAL INTEGRITY AT ALL TIMES. (MASONRY, STEEL, WOOD, ETC.)
- 5. CONTRACTOR WILL NOTIFY DESIGNER IMMEDIATELY OF ANY DISCREPANCIES IN THE DRAWINGS AND WILL NOT PROCEED WITH WORK IN THOSE AREAS UNTIL DISCREPANCIES ARE RESOLVED.
- 6. ANY DEVIATIONS FROM THE CONTENTS OF THESE PLANS WITHOUT WRITTEN CONSENT OF THIS DESIGNER WOULD MAKE IT NULL AND VOID.
- 7. THIS DESIGNER HAS NO CONTRACT WITH OWNER TO SUPERVISE OR OBSERVE THE CONSTRUCTION OF THIS PROJECT. IT IS THE OWNER'S AND CONTRACTOR'S RESPONSIBILITY TO ENSURE FULL COMPLIANCE AND NOT OF THIS DESIGNER
- 8. THIS DESIGNER IS NOT RESPONSIBLE FOR MECHANICAL, PLUMBING, AND ELECTRICAL WORK OR DESIGN, AS WELL AS FIRE ALARM DESIGN.
- 9. LOCATIONS OF ALL UTILITIES MUST BE DETERMINED IN THE FIELD BEFORE EXCAVATING BY THE CONTRACTOR. WE ASSUME NO RESPONSIBILITY FOR DAMAGES INCURRED AS A RESULT OF UTILITIES OMITTED OR INACCURATELY
- 10. NOTIFY THE DESIGNER OF ANY FIELD CONDITIONS WHICH DIFFER FROM THOSE SHOWN IMPLIED ON THE DRAWINGS.
- 11. THIS DESIGNER IS NOT RESPONSIBLE FOR ANY HIDDEN STRUCTURAL PROBLEMS.

## WORK DESCRIPTIONS

RENOVATION OF RESIDENTIAL FOURTH (4) STORY BUILDING.

SPRINKLERS AND FIRE ALARM.

STAIRS

DOORS

CORRIDORS

TWO HOURS FIRE RESISTANCE RATED SEPARATION TO BE EXTENDED TO ALL STAIRS AND FIRE DOOR TO BE NINETY MINUTES.

- MEANS OF EGRESS (NFPA 101 / 2012) CHAPTER 7 &12 IBC - 2015 SECTIONS 1001
- MINIMUM REQUIRED EGRESS WIDTH:

(ACCORDING TO IBC - 2015 SECTION 1005.1) & NFPA 101 / 2012 TABLE

THE TOTAL WIDTH OF MEANS OF EGRESS SHALL NOT BE LESS THAN THE TOTAL OCCUPANT LOAD SERVED BY THE MEANS OF EGRESS MULTIPLIED BY .2"/PERSON FOR DOORS, CORRIDORS & .3"/PERSON FOR STAIRS

(SEE LIFE SAFETY PLANS)

### NUMBER OF EXITS

(BASED ON IBC - 2015 TABLE 1006.3.1) MINIMUM NUMBER OF EXITS FOR OCCUPANT LOAD PERSONS PER STORY 1 - 500 = 2 EXITS

OCCUPANT LOAD LESS THAN 500 = 2 EXITS REQUIRED 2 SEPARATE EXISTS LOCATIONS PROVIDED

### EXIT SEPARATION DISTANCE:

(ACCORDING TO IBC - 2015 SECTION 1007) WHERE A BUILDING IS EQUIPPED THROUGHOUT WITH AN AUTOMATIC SPRINKLER SYSTEM EXIT DOORS OR EXIT ACCESS DOORWAY MIN. SEPARATION DISTANCE SHALL NOT BE LESS THAN 1/3 OF THE LENGTH OF THE MAXIMUM OVERALL DIAGONAL DIMENSION OF THE AREA SERVED PROPOSED DOORWAY CONFIGURATION --- OK (SEE SAFETY PLAN)

### **EXIT ACCESS TRAVEL DISTANCE:**

(BASED ON IBC - 2015 TABLE 1017.2) ASSUMED OCCUPANCY (B) WITH SPRINKLER SYSTEM = 300' OCCUPANCY (R) WITH SPRINKLER SYSTEM = 250' PROPOSED BUILDING --- OK (SEE SAFETY PLAN)

## **EXIT ENCLOSURES:**

INCLUDING ANY BASEMENT.

(ACCORDING TO IBC - 2015 SECTION 1023) 2 HOURS FIRE RESISTANCE RATING WHERE CONNECTING FOUR STORIES OR MORE AND 1 HOUR WHEN CONNECTING LESS THAN FOUR STORIES

## **CODE ANALYSIS**

USE AND OCCUPANCY CLASSIFICATION IBC - 2015 SECTION 310 & 312

EXISTING USE: RESIDENTIAL UNIT.

### TYPE OF CONSTRUCTION IBC - 2015 SECTION 601

(IV-HT) EXTERIOR WALLS ARE OF NONCOMBUSTIBLE MATERIAL AND INTERIOR BUILDING ELEMENTS ARE OF ANY MATERIALS PERMITTED BY THIS CODE.

### **USE SEPARATION & FIRE PROTECTION ASSEMBLY** IBC - 2015 SECTIONS 508, TABLE 716.5, TABLE 1020.1, & 1023

ASSUMED USES (A) OR (B) / (R) = 1- HOUR WHEN BUILDING IS EQUIPPED THROUGHOUT WITH AN AUTOMATIC SPRINKLER SYSTEM. CORRIDOR FIRE RESISTANCE RATING 0.5 HOUR & DOORS 20 MINUTES WHEN BUILDING IS EQUIPPED THROUGHOUT WITH AN AUTOMATIC SPRINKLER SYSTEM. INTERIOR EXIT STAIRWAY ENCLOSURES SHALL BE 2- HOURS WHEN CONNECTING 4 STORY OR MORE INCLUDING BASEMENT.

### FIRE PROTECTION SYSTEMS IBC - 2015 SECTIONS 903 & 906-907

PROPOSED BUILDING WILL BE EQUIPPED THROUGHOUT WITH AN AUTOMATIC SPRINKLER SYSTEM.

PROPOSED BUILDING WILL BE EQUIPPED THROUGHOUT WITH AN APPROVED FIRE ALARM DETECTION SYSTEM.

### REFENCED CODE

INTERNATIONAL BUILDING CODE - 2015 INTERNATIONAL RESIDENTIAL CODE - 2015 NFPA 101 / 2012

#### PROPOSED BASEMENT FLOOR OCCUPANT LOAD = 5 OCCUPANTS EGRESS WIDTH REQUIREMENTS MIN. WIDTH REQUIREMENTS WIDTH BASED ON OCC. LOAD WIDTH PROVIDED 36" (R311.7.1) 0.3" X 5 OCC = 1.5" (1005.3.1) 36" EQUAL OR GREATER THAN 36" 32" (R311.2) 0.2" X 5 OCC = 1" / 2 = 0.5" (1005.3.2) 60" EQUAL OR GREATER THAN 32" 36" (R311.6) 0.2" X 5 OCC = 1" (1005.3.2) 42" EQUAL OR GREATER THAN 36"

## PROPOSED FIRST FLOOR OCCUPANT LOAD = 4 OCCUPANTS

	EGRESS WIDTH REQUIREMENTS											
MIN. WIDTH REQUIREMENTS WIDTH BASED ON OCC. LOAD WIDTH PROVIDE												
STAIRS	36" (R311.7.1)	0.3" X 4 OCC = 1.2" (1005.3.1)	68" EQUAL OR GREATER THAN 36"									
DOORS	32" (R311.2)	0.2" X 4 OCC = 0.8" (1005.3.2)	60" EQUAL OR GREATER THAN 32"									
CORRIDORS	36" (R311.6)	0.2" X 4 OCC = 0.8" (1005.3.2)	51" EQUAL OR GREATER THAN 36"									

## PROPOSED SECOND FLOOR TOTAL OCCUPANT LOAD = 4 OCCUPANTS

		EGRESS '	WIDTH REQUIREMENTS	
		MIN. WIDTH REQUIREMENTS	WIDTH BASED ON OCC. LOAD	WIDTH PROVIDED
	STAIRS	36" (R311.7.1)	0.3" X 4 OCC = 1.2" (1005.3.1)	48" EQUAL OR GREATER THAN 36
	CORRIDORS	36" (R311.6)	0.2" X 4 OCC = 0.8" (1005.3.2)	72" EQUAL OR GREATER THAN 36
	WINDOWS EGRESS/ FIRE ESCAPE	20" (R310.2.1)	0.2" X 4 OCC = 0.8" (1005.3.2)	30" EQUAL OR GREATER THAN 20

#### EGRESS WIDTH REQUIREMENTS MIN. WIDTH REQUIREMENTS WIDTH BASED ON OCC. LOAD WIDTH PROVIDED 36" (R311.7.1) 0.3" X 40 OCC = 1.2" (1005.3.1)

PROPOSED THIRD FLOOR TOTAL OCCUPANT LOAD = 4 OCCUPANTS

#### STAIRS 48" EQUAL OR GREATER THAN 36 CORRIDORS 36" (R311.6) 72" EQUAL OR GREATER THAN 36' 0.2" X 4 OCC = 0.8" (1005.3.2) VINDOWS EGRESS 20" (R310.2.1) 0.2" X 4 OCC = 0.8" (1005.3.2) 30" EQUAL OR GREATER THAN 20 FIRE ESCAPE

## PROPOSED FOURTH FLOOR TOTAL OCCUPANT LOAD = 3 OCCUPANTS

	EGRESS WIDTH REQUIREMENTS												
	MIN. WIDTH REQUIREMENTS	WIDTH BASED ON OCC. LOAD	WIDTH PROVIDED										
STAIRS	36" (R311.7.1)	0.3" X 3 OCC = 0.9 (1005.3.1)	48" EQUAL OR GREATER THAN 36"										
CORRIDORS	36" (R311.6)	0.2" X 3 OCC = 0.6" (1005.3.2)	72" EQUAL OR GREATER THAN 36"										
WINDOWS EGRESS/ FIRE ESCAPE	20" (R310.2.1)	0.2" X 4 OCC = 0.8" (1005.3.2)	30" EQUAL OR GREATER THAN 20"										

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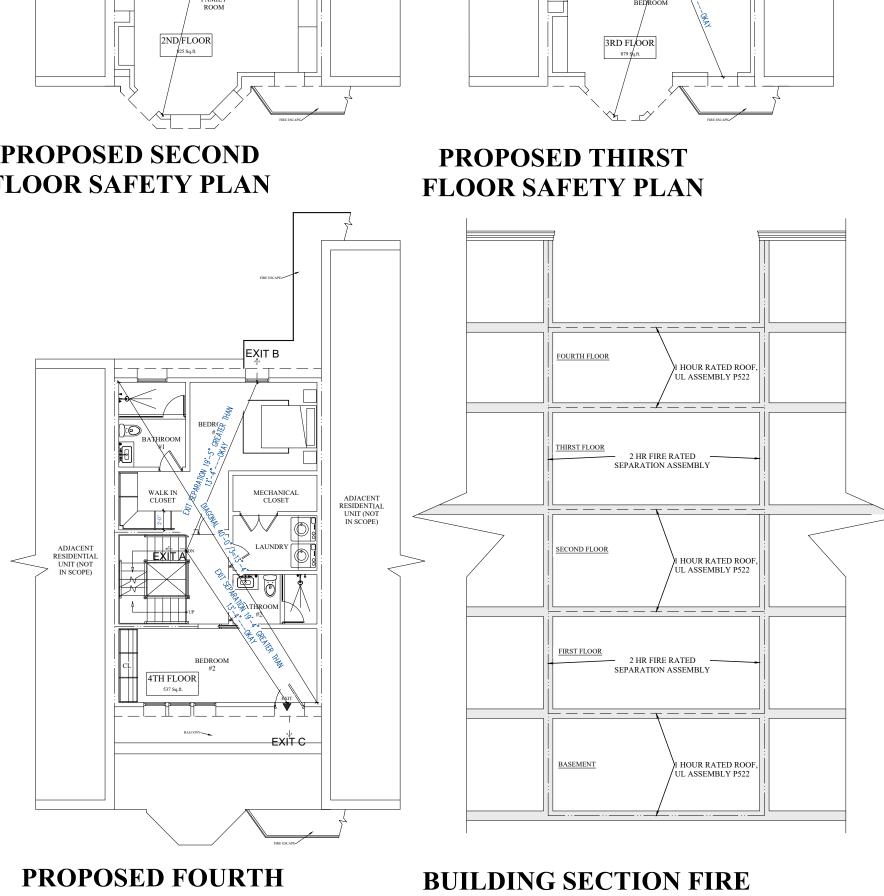
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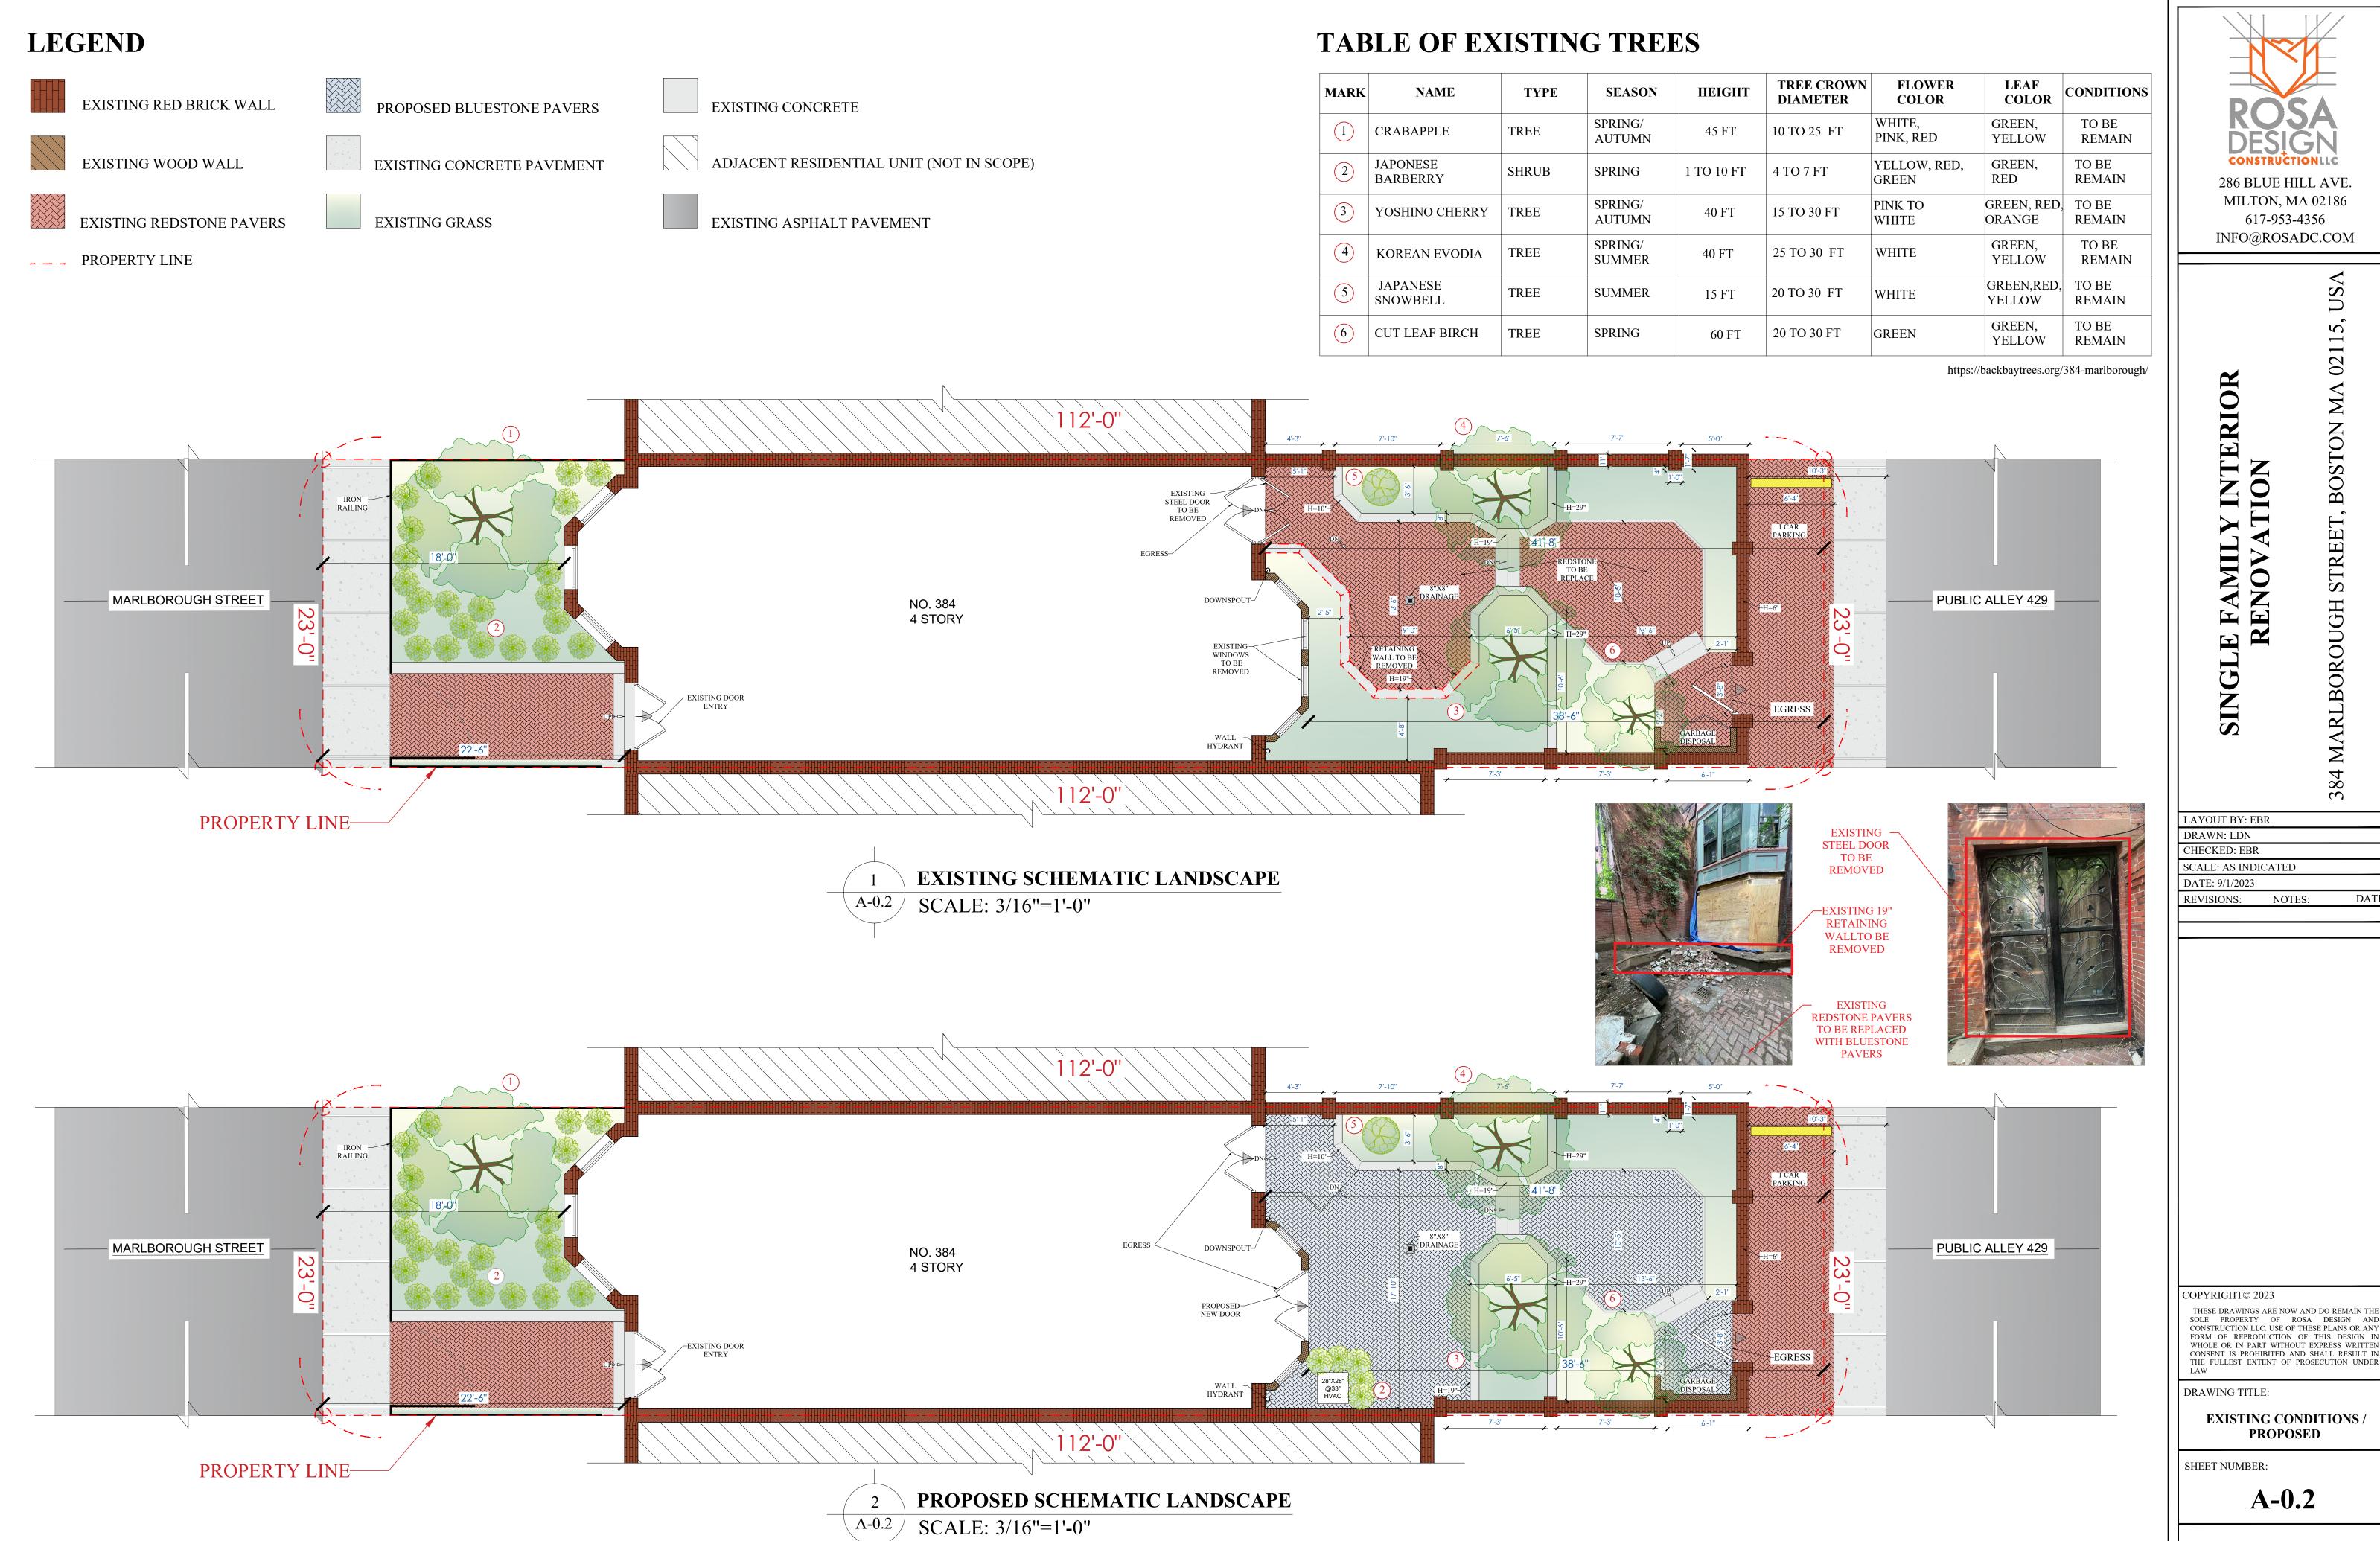
**CODE ANALYSIS** 

SHEET NUMBER:

A-0.1



FLOOR SAFETY PLAN **RATING DIAGRAM** 





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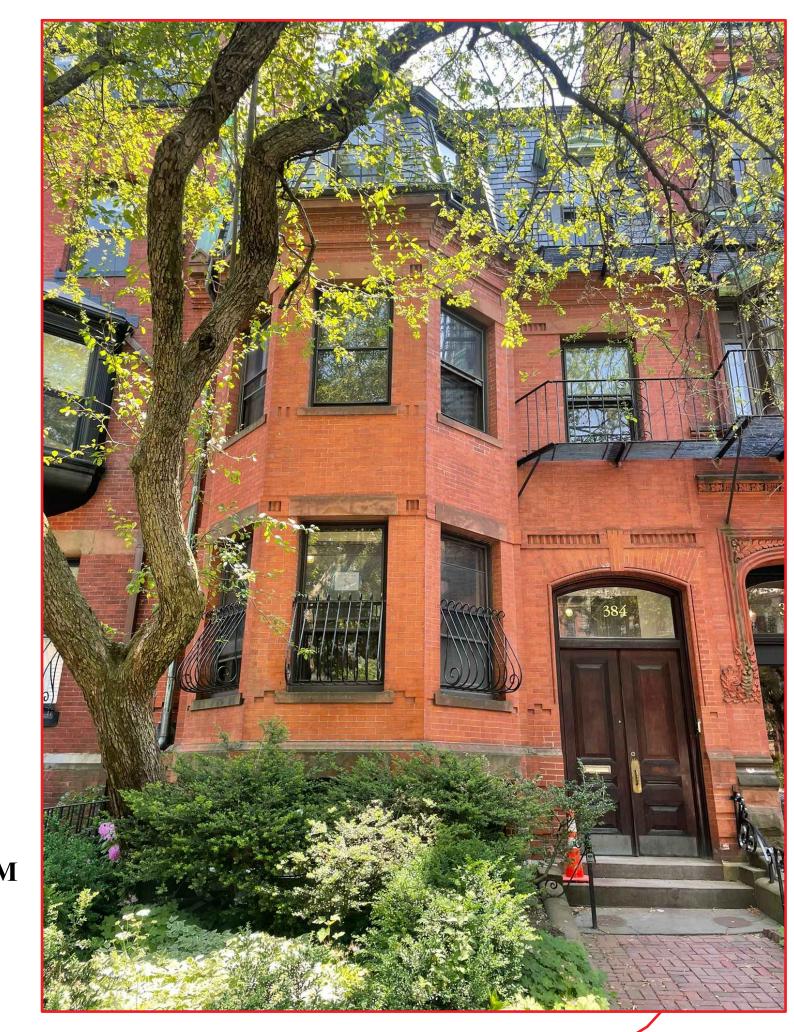


**PUBLIC** 

ALLEY 429

## EXISTING REAR VIEW FROM THE **PUBLIC ALLEY 429**

ADJACENT RESIDENTIAL



MARLBOROUH ST

**EXISTING FRONT VIEW FROM** MARLBOROUGH STREET

UNIT (NOT IN SCOPE) PROPOSED 42" STEEL BLACK RAILING 384 MARLBOROUGH REAR WALL − IRON RAILING

SCHEMATIC LINE OF SIGHT TO THE RAILING FROM BOTH STREETS



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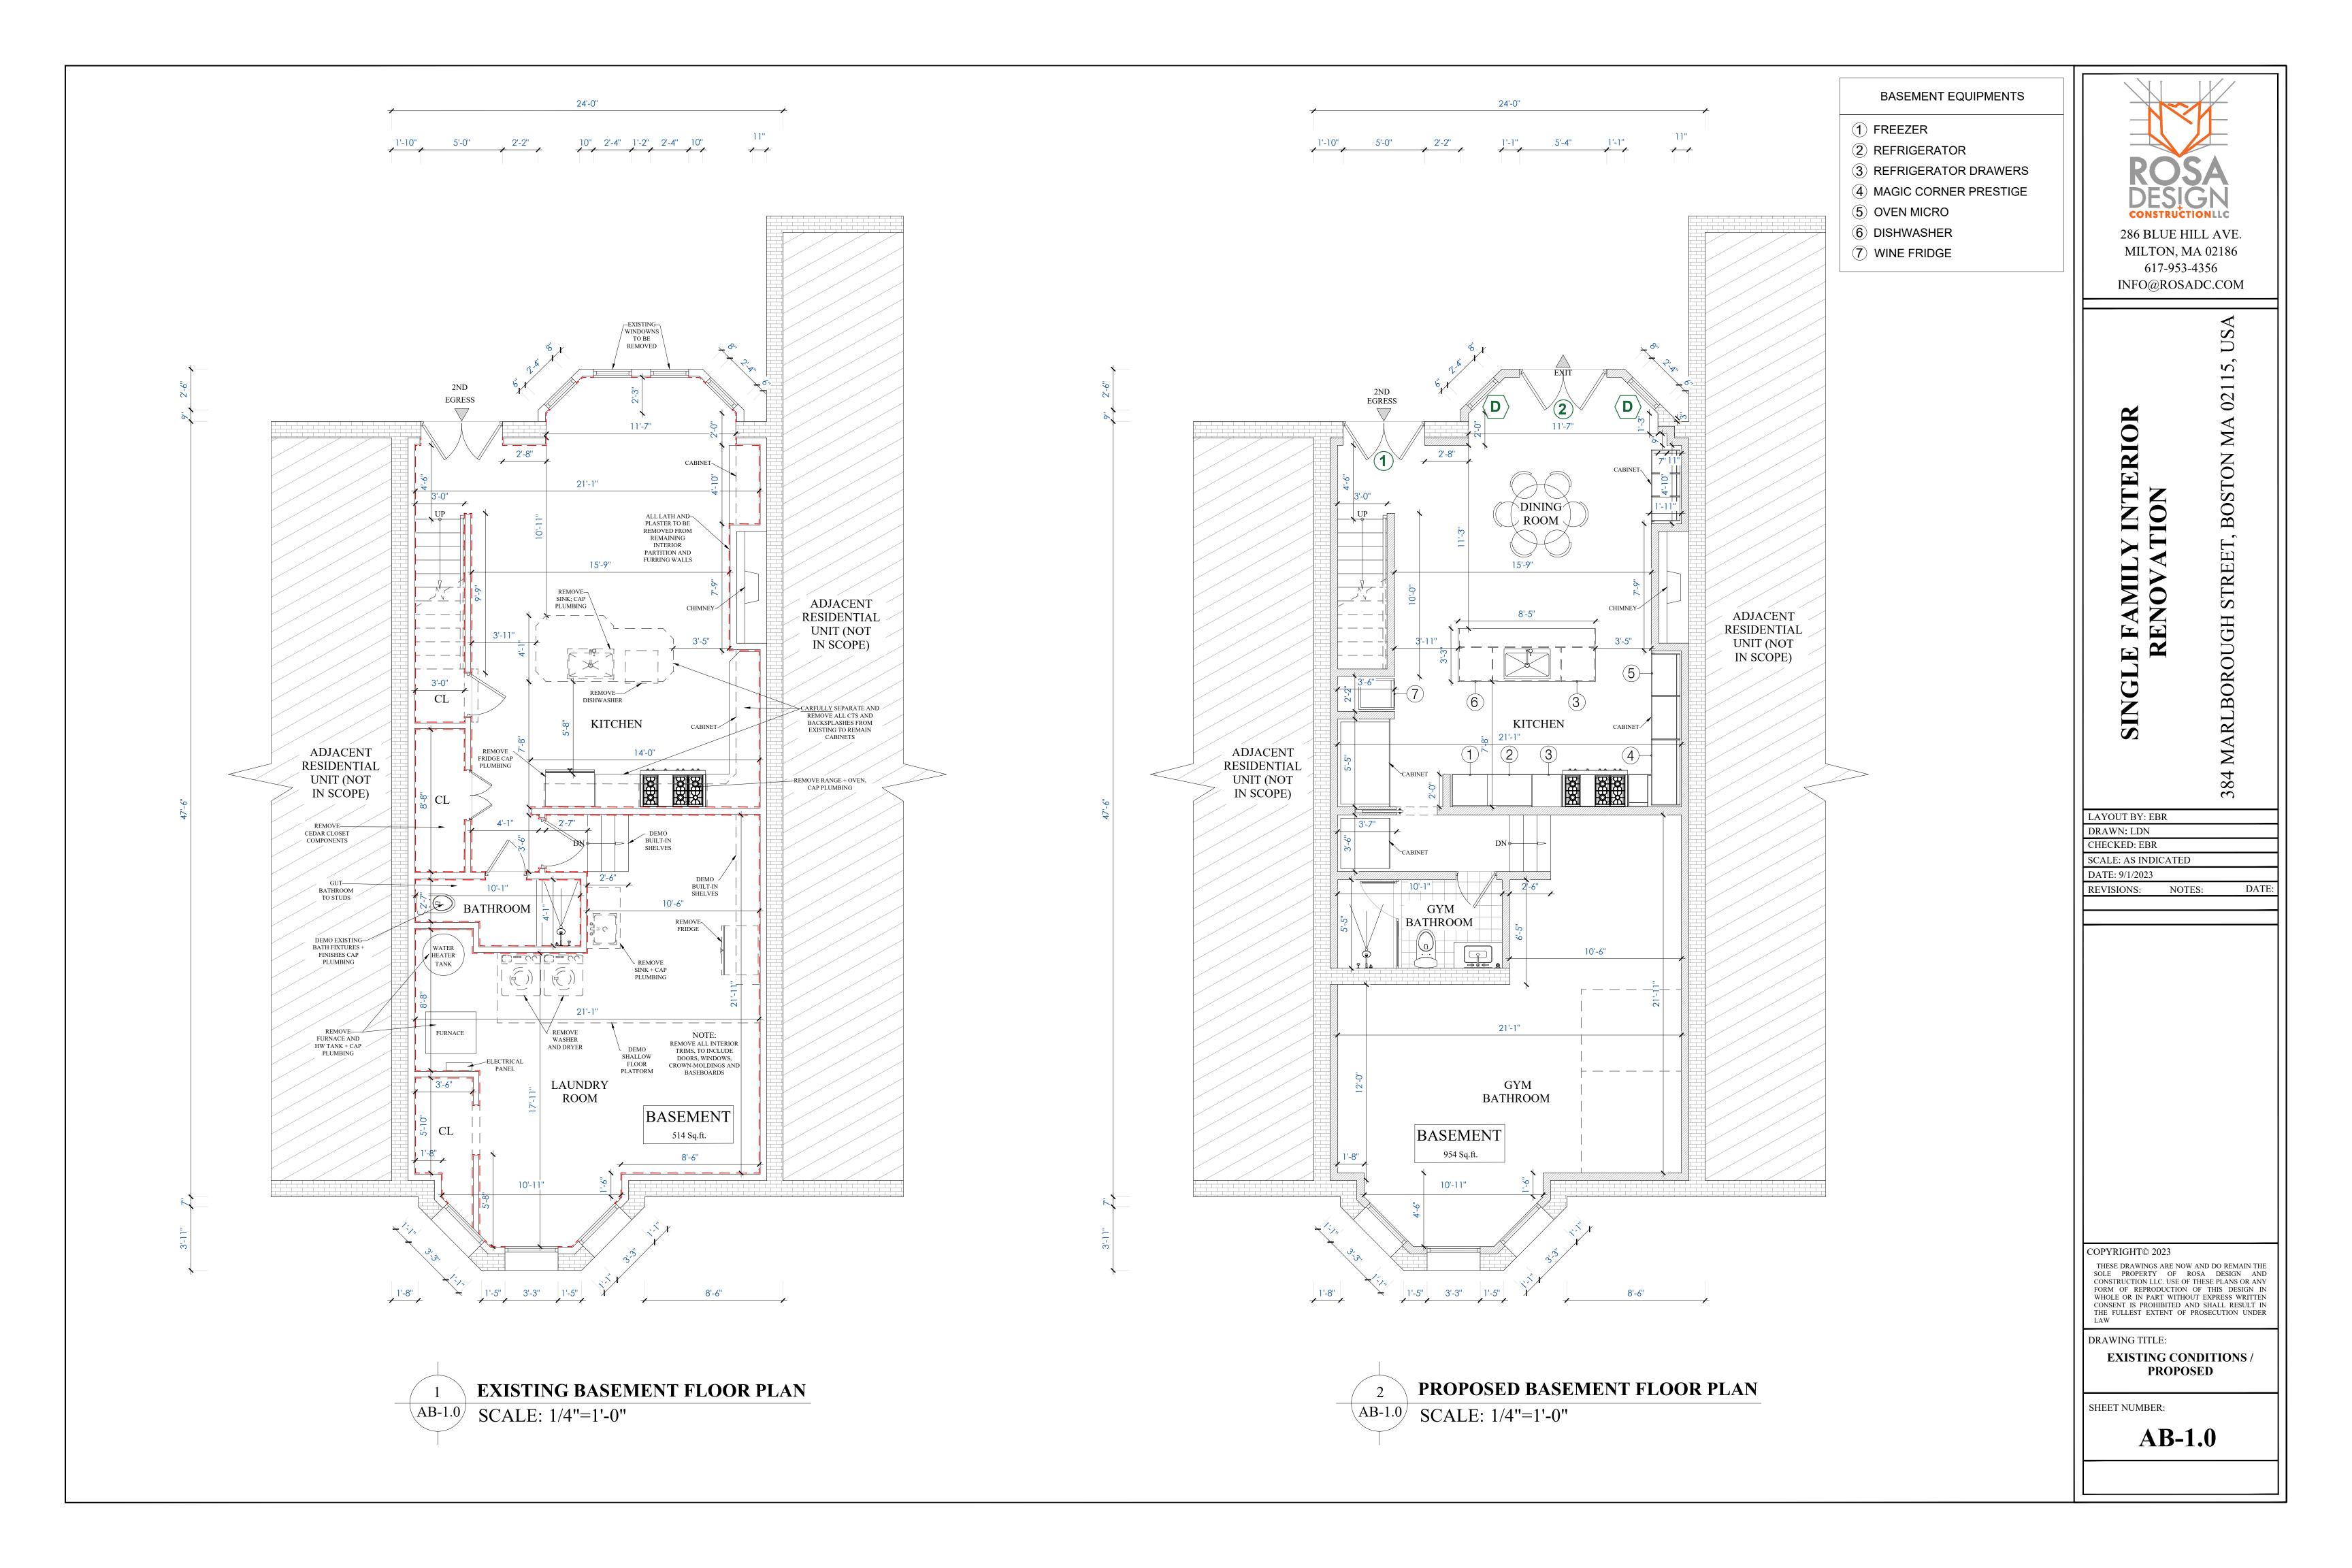
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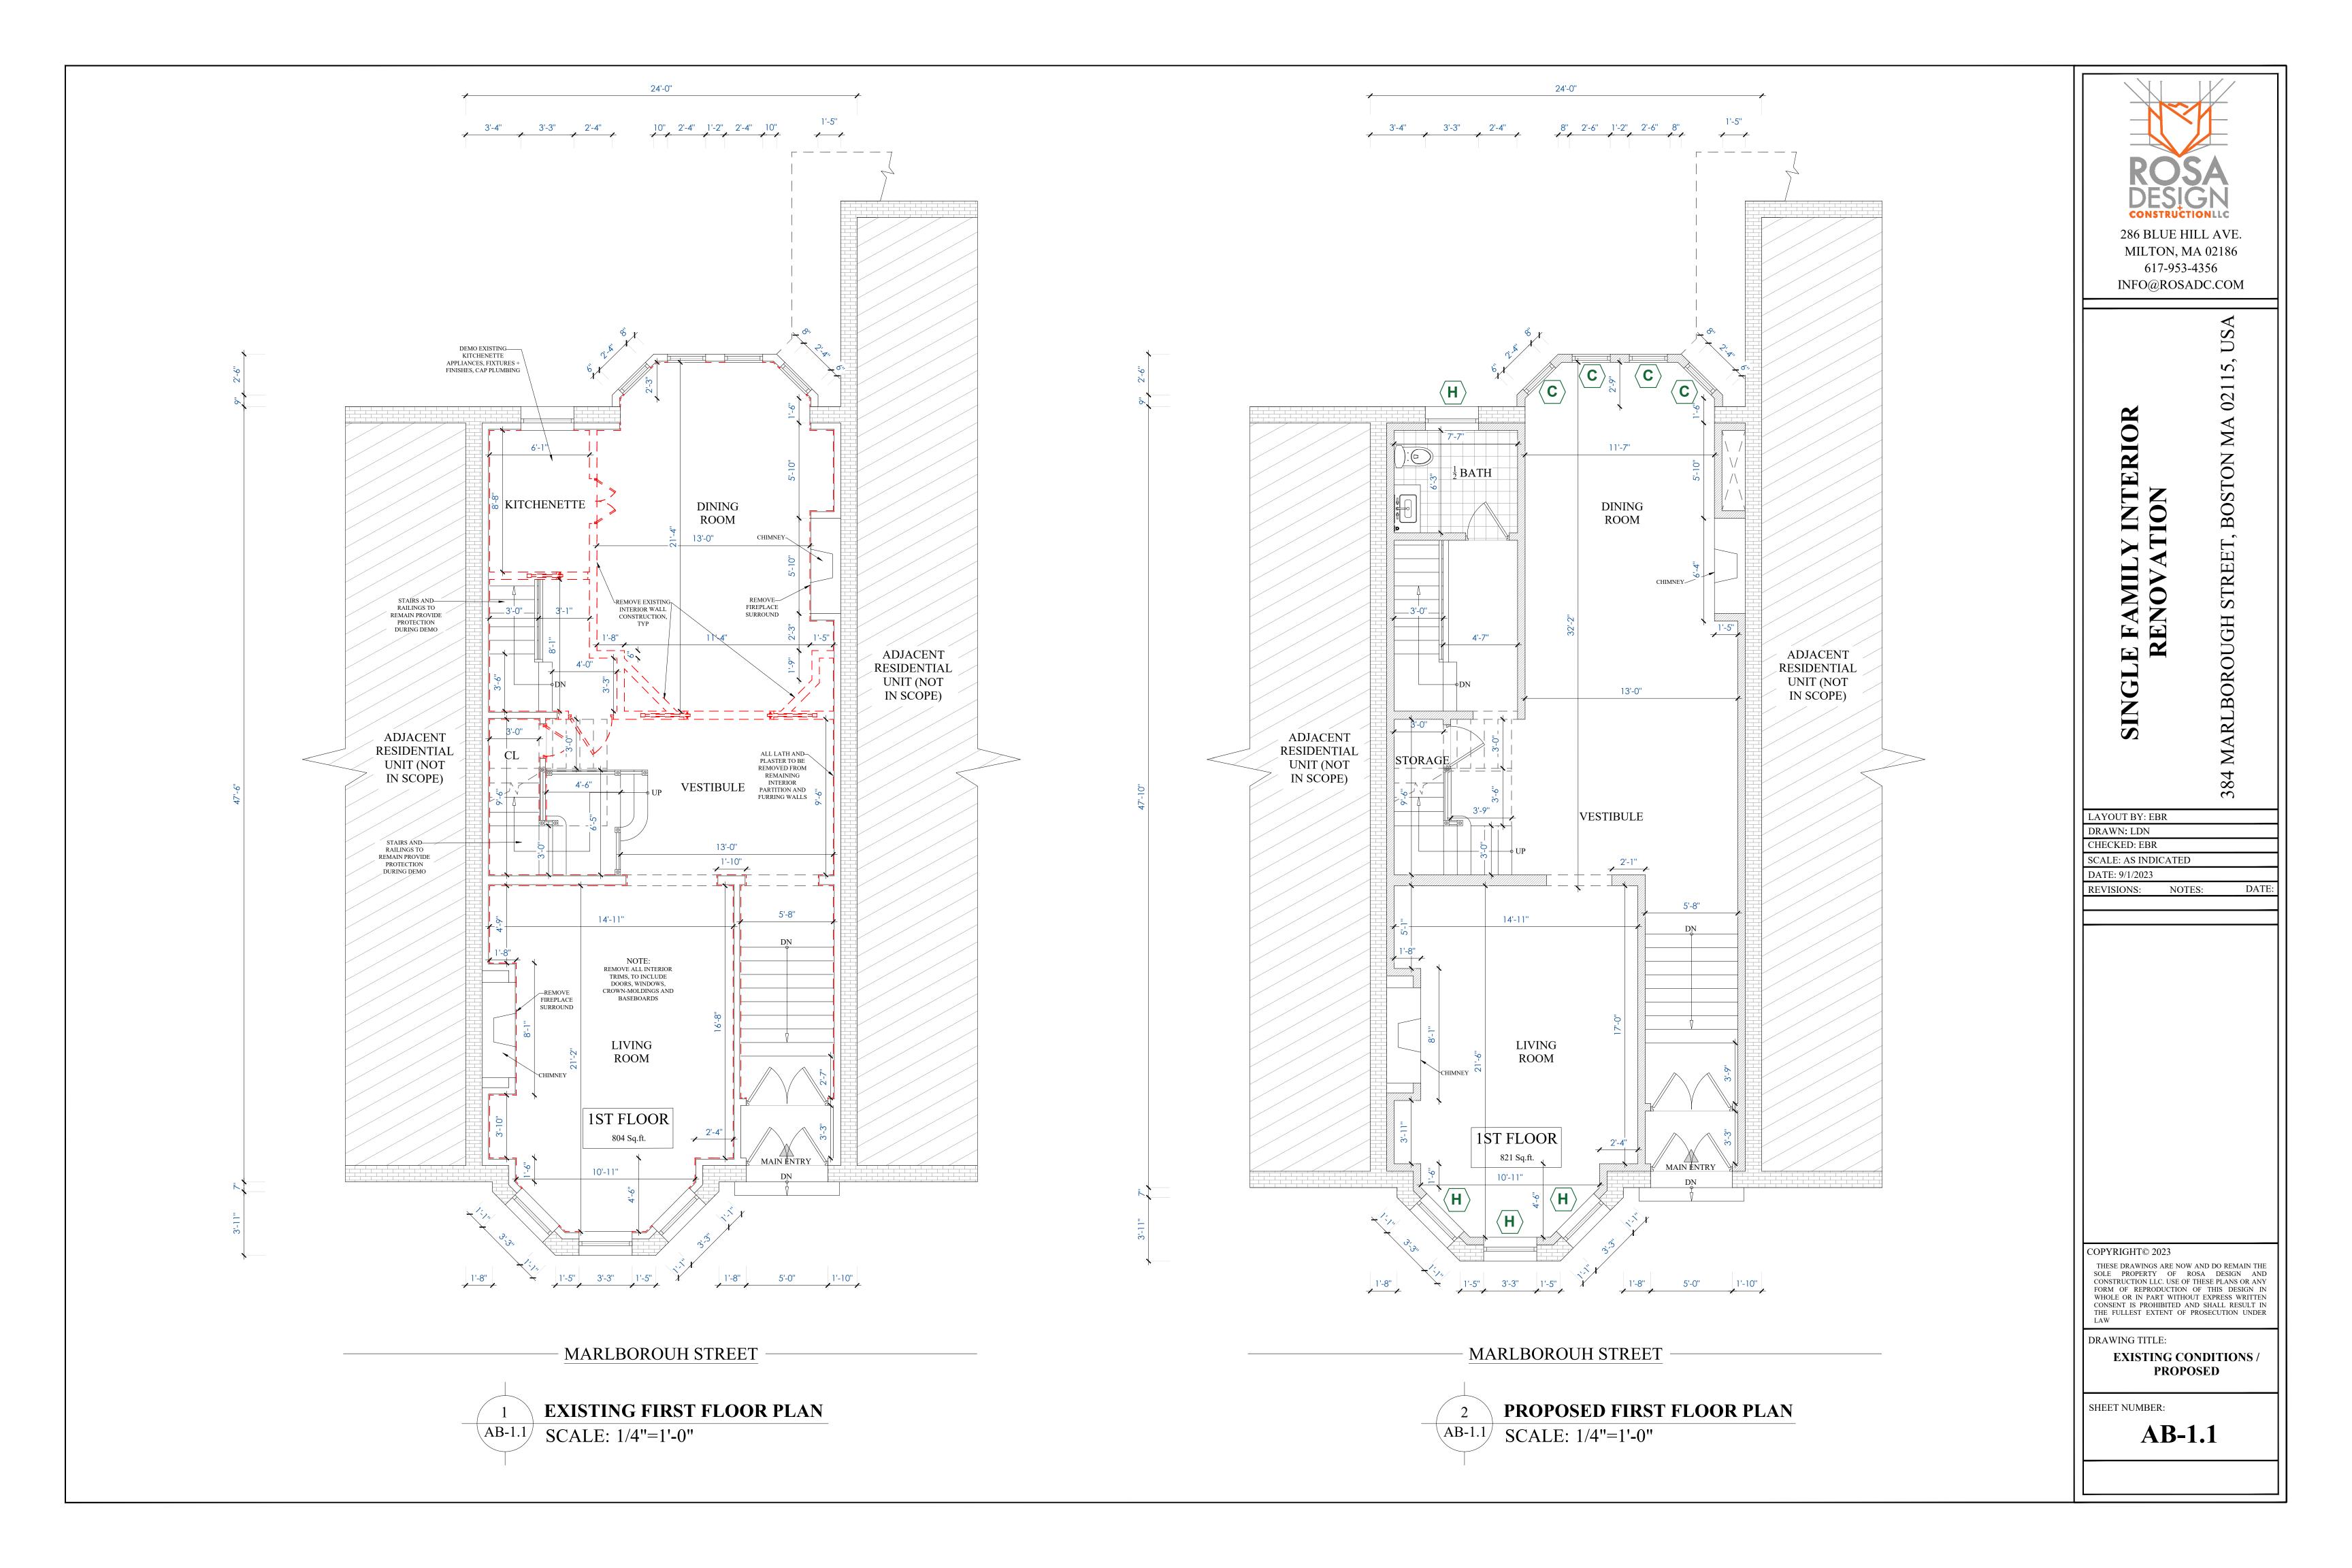
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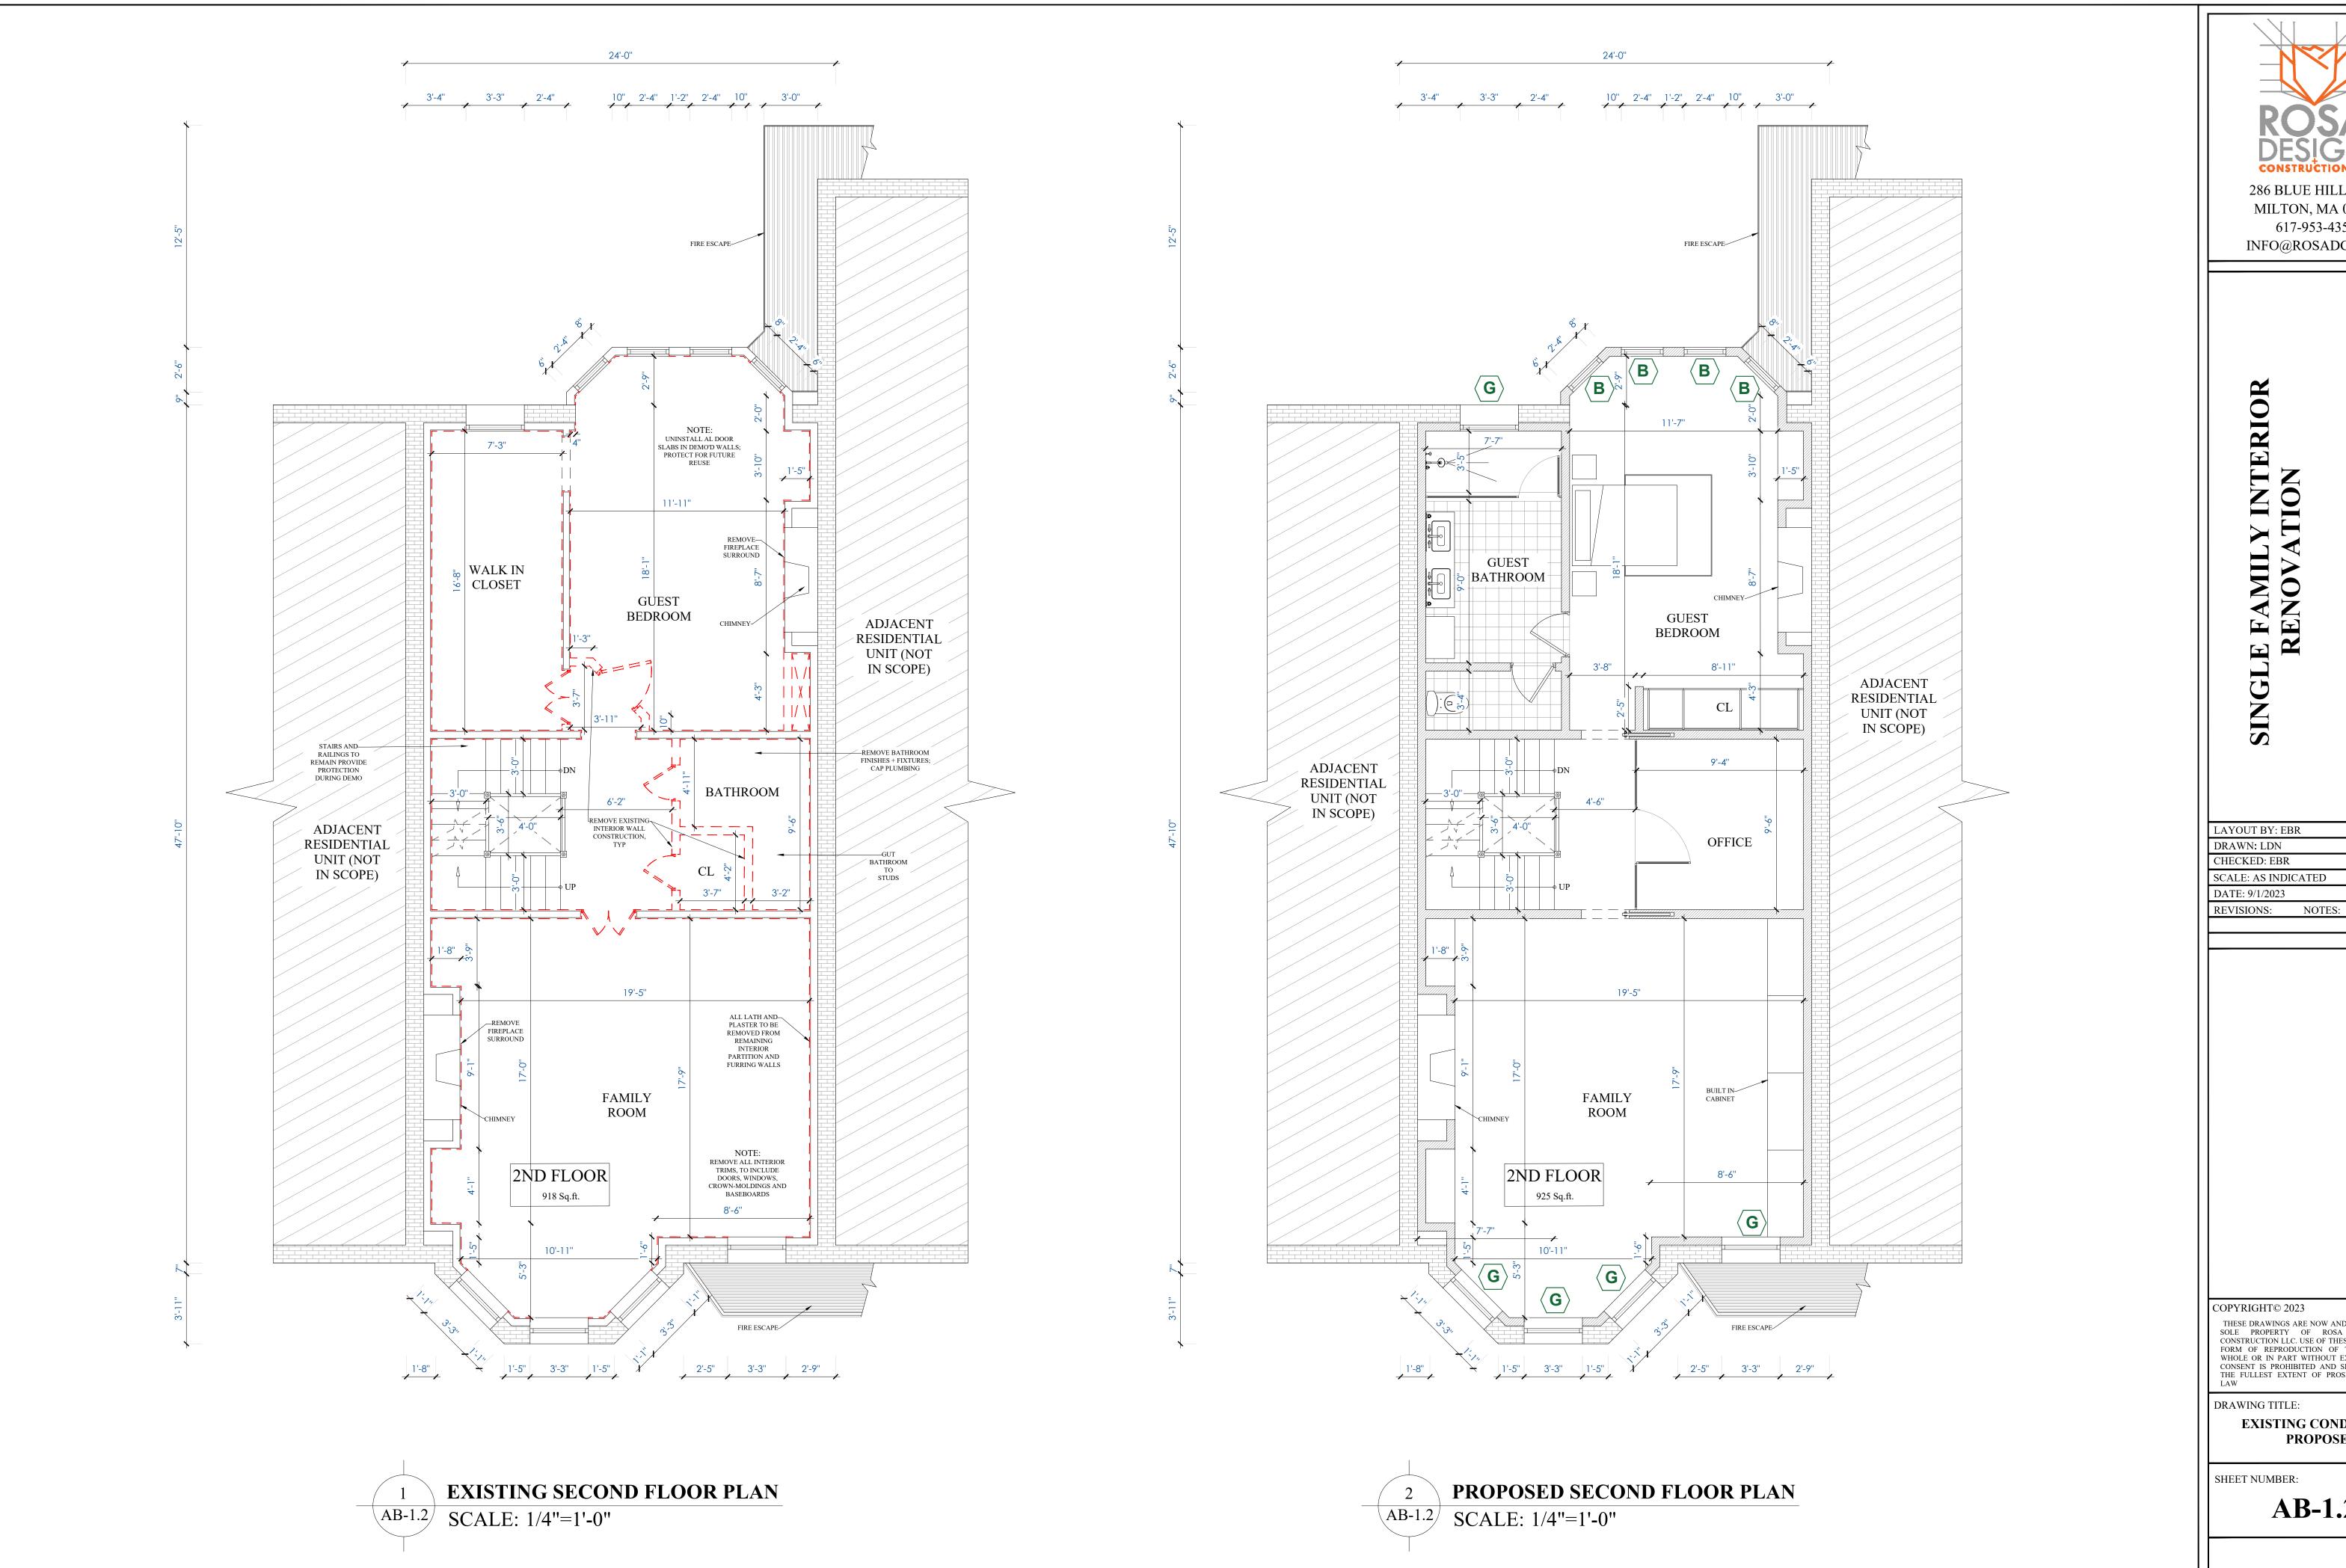
**EXISTING CONDITIONS** 

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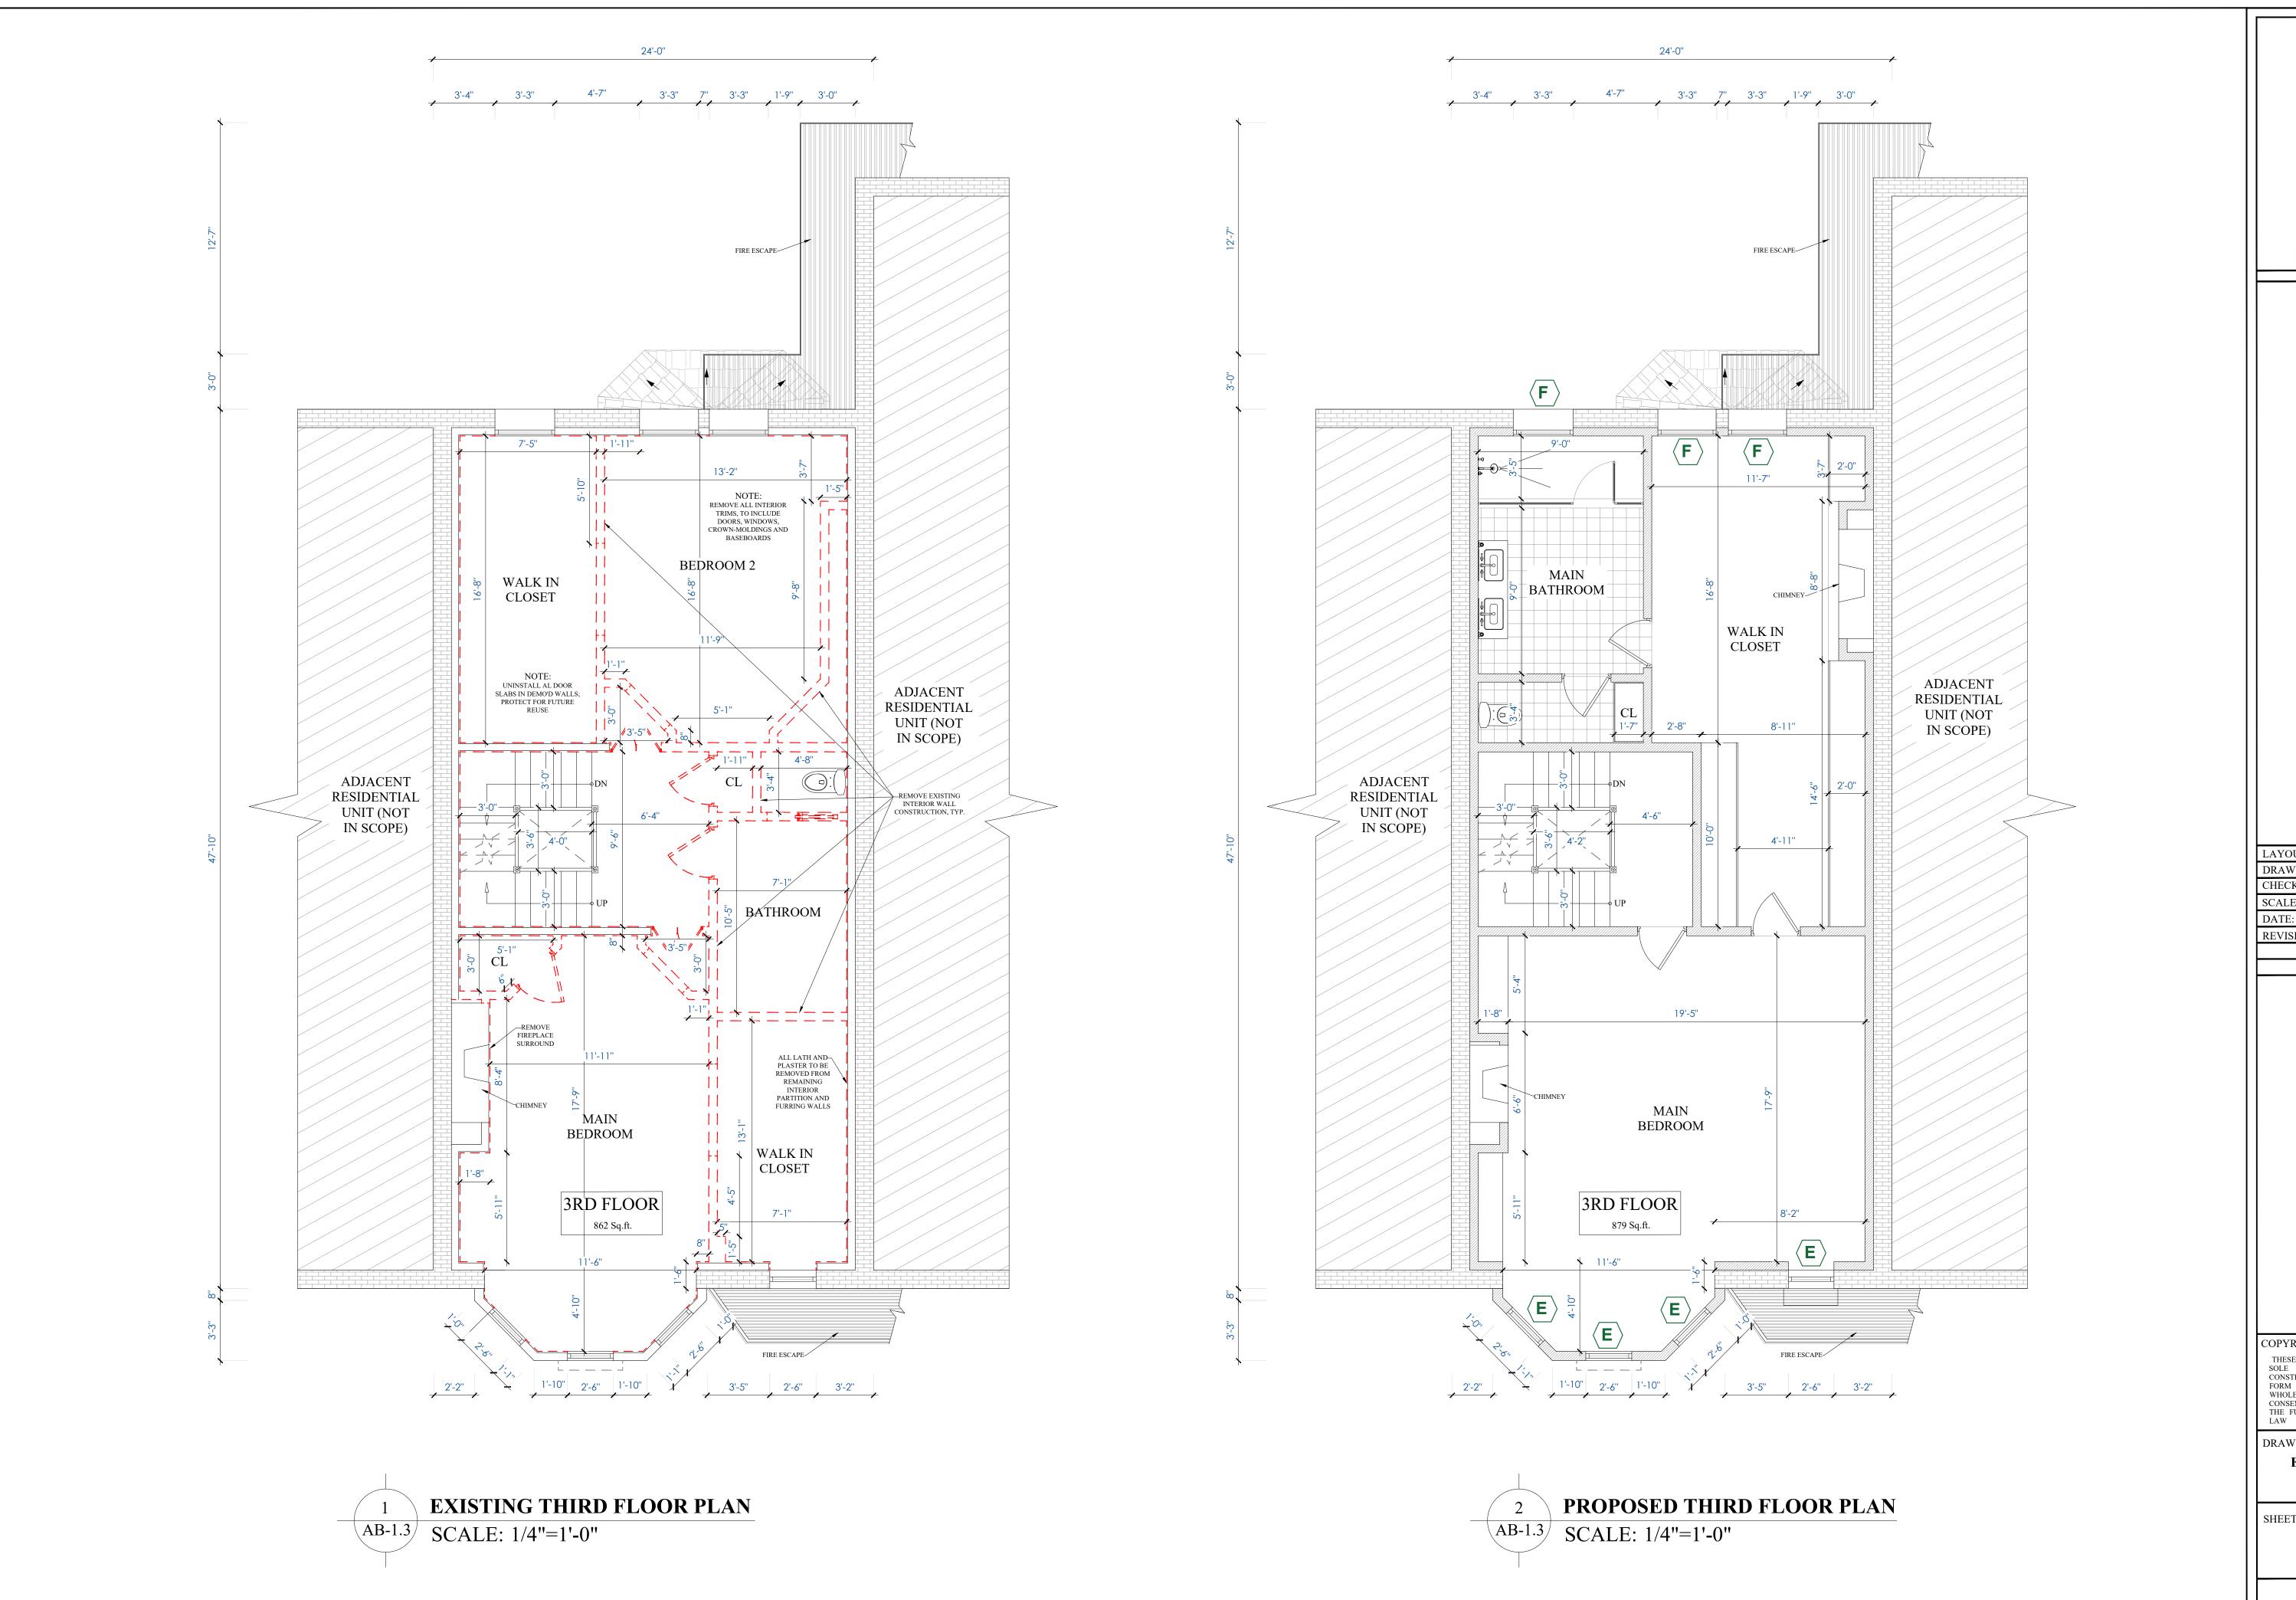
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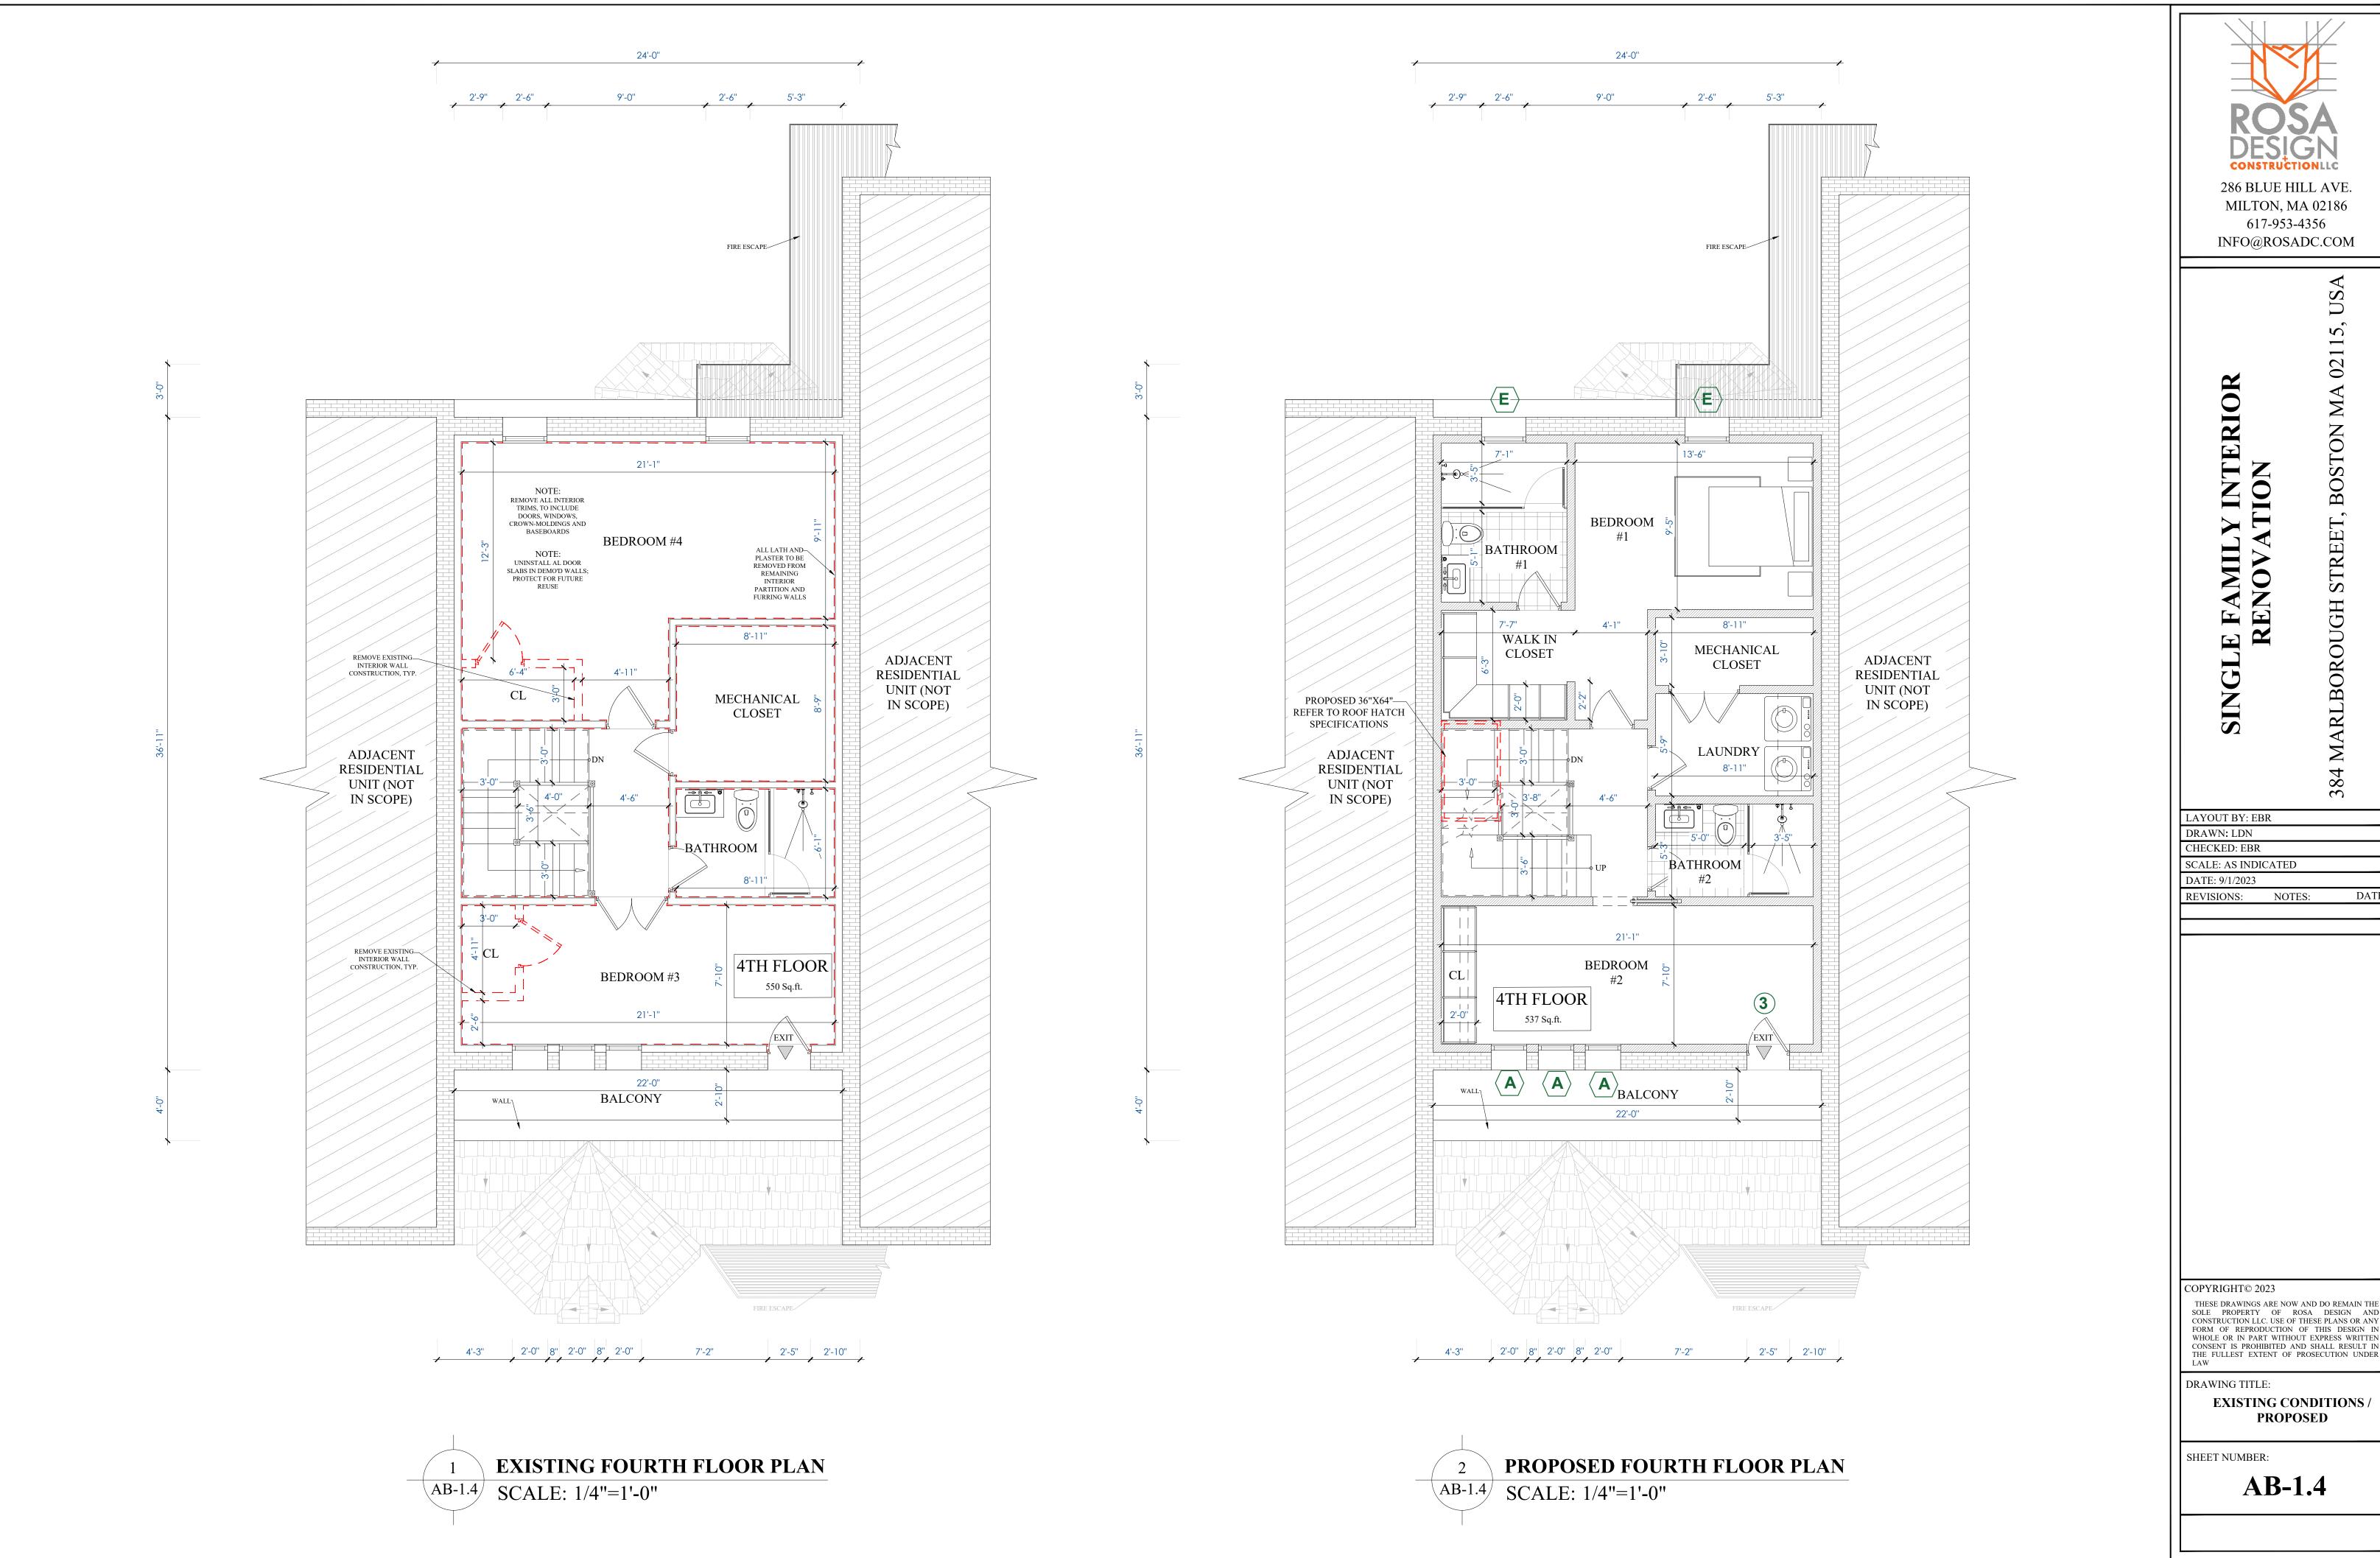
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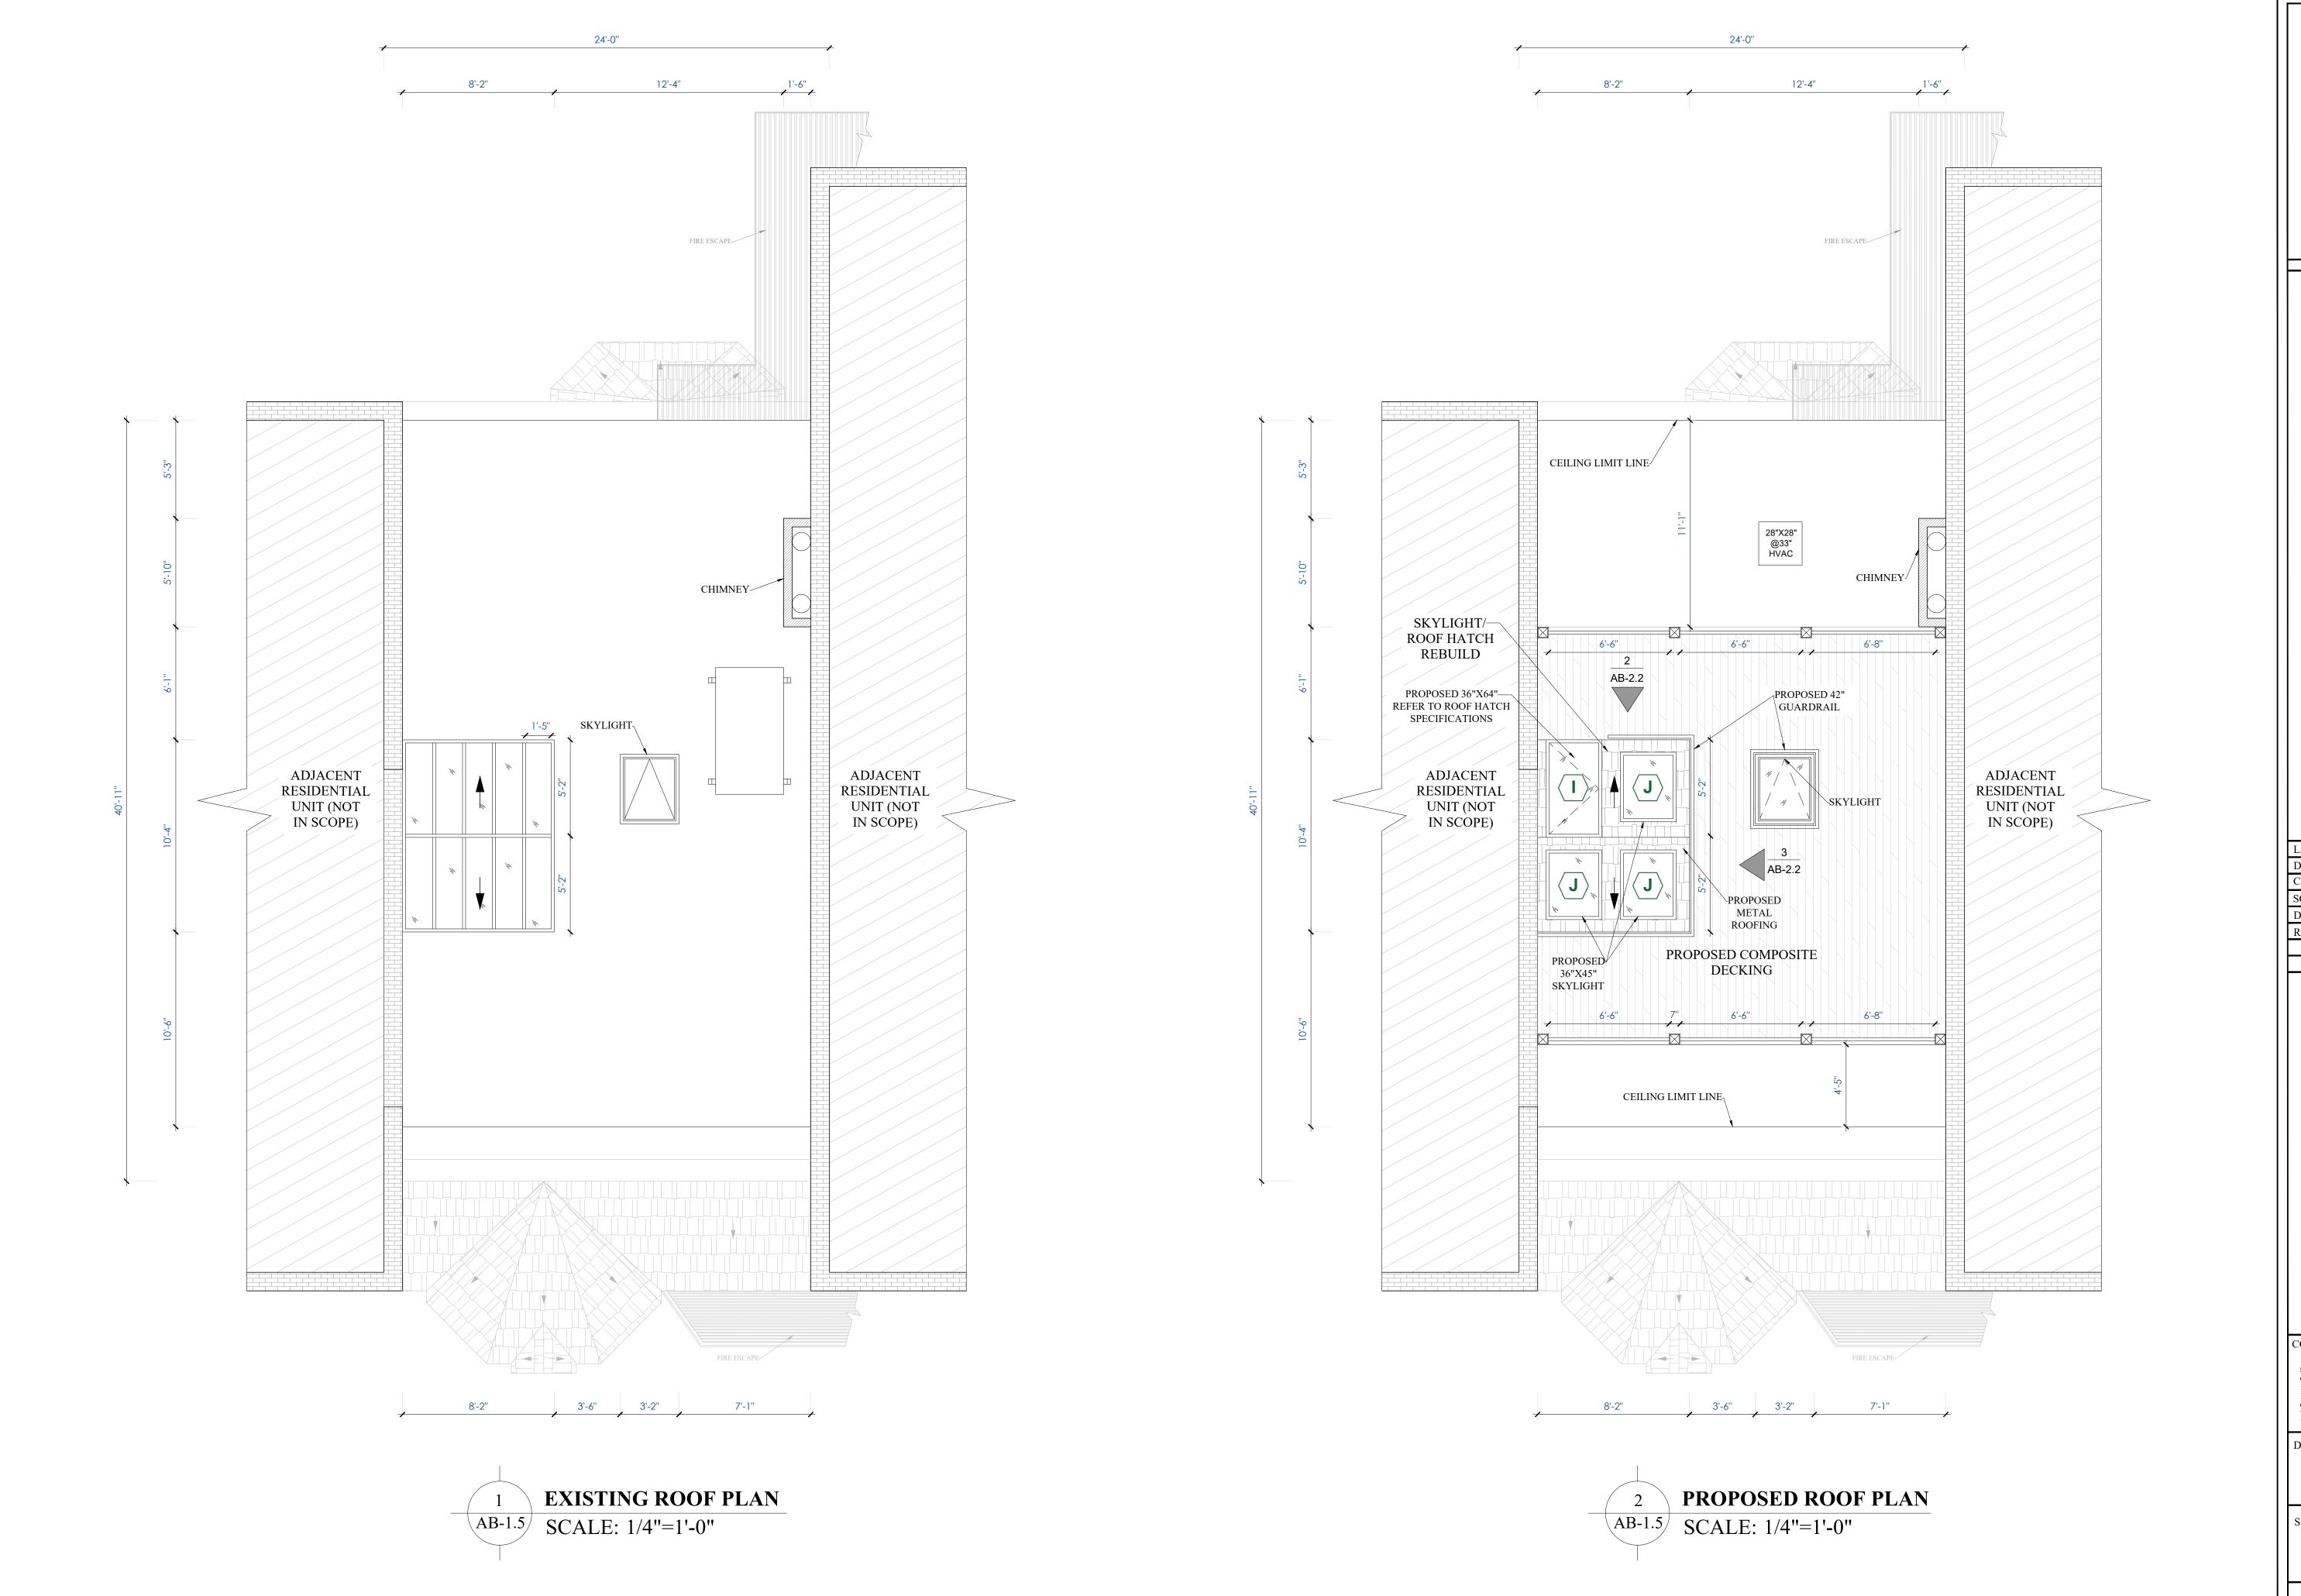


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LY INTERIOR
'ATION SINGLE FAMILY
RENOVAL

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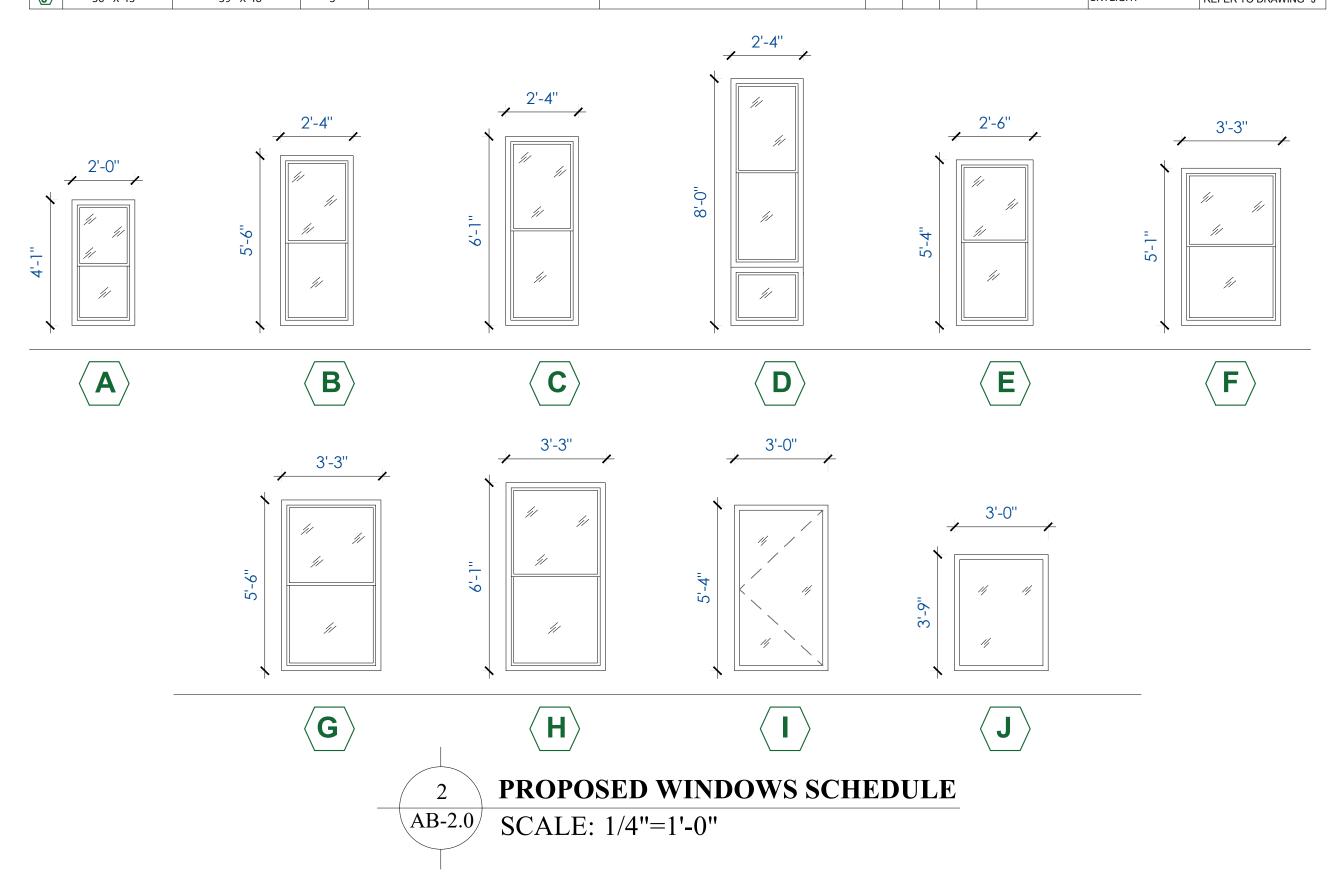





**EXISTING FRONT ELEVATION( NO CHANGES)** 

AB-2.0/ SCALE: 1/4"=1'-0"

			WINDOWS	SCHEDULE						
SYM UNIT DIMENSION	YM UNIT DIMENSION ROUGH OPENING QUANTITY REMARKS / COMMENTS ROOM / SPACE NAME GRID STYLE EXISTING									
ONLY DIMENSION	KOOGII OF LIVING	Q0/11111	,		4 LT	6 LT 9 LT				
<b>(A)</b> 24" X 49"	27'' X 52''	3	WINDOW-SINGLE LEAF	BEDROOM #2 (FOURTH FLOOR)				SINGLE LEAF	REFER TO DRAWING "A"	
<b>(B)</b> 28" X 66"	31" X 69"	4	WINDOW-SINGLE LEAF	GUEST BEDROOM (SECOND FLOOR)				SINGLE LEAF	REFER TO DRAWING "B"	
<b>ⓒ</b> 28" X 73"	31" X 76"	4	WINDOW-SINGLE LEAF	DINING ROOM (FIRST FLOOR)				SINGLE LEAF	REFER TO DRAWING "C"	
<b>(D)</b> 28" X 96"	31" X 99"	4	WINDOW-SINGLE LEAF	DINING ROOM (BASEMENT FLOOR)				SINGLE LEAF	REFER TO DRAWING "D'	
<b>(E)</b> 30" X 64"	33" X 67"	6	WINDOW-SINGLE LEAF	MAIN BEDROOM (THIRD FLOOR) / BEDROOM - BATHROOM #1 (FOURTH FLOOR)				SINGLE LEAF	REFER TO DRAWING "E"	
<b>(F)</b> 39" X 61"	42" X 64"	3	WINDOW-SINGLE LEAF	WALK IN CLOSÈT / MAIN BATHRÓOM (THIRD FLOOR)				SINGLE LEAF	REFER TO DRAWING "F"	
<b>©</b> 39" X 66"	42" X 69"	5	WINDOW-SINGLE LEAF	FAMILY ROOM / GUEST BATHROOM (SECOND FLOOR)				SINGLE LEAF	REFER TO DRAWING "G"	
⟨H⟩ 39" X 73"	42" X 76"	4	WINDOW-SINGLE LEAF	LIVING ROOM / ½ BATH (FIRST FLOOR)				SINGLE LEAF	REFER TO DRAWING "H"	
(I) 36" X 64"	39" X 67"	1	ROOF HATCH, SUNLIT SERIES, 36X64, S DR, ZINC HDW, ALUM, MILL, DBL WALL CURB, 2" POLYISO W/ FIBERGLASS CURB CLEAR/ CLEAR DOME	ROOF				ROOF HATCH	REFER TO DRAWING "I"	
⟨ <b>J</b> ⟩ 36" X 45"	39" X 48"	3	SKYLIGHT	ROOF				SKYLIGHT	REFER TO DRAWING "J"	



	DOOR SCHEDULE														
ROOM /	DOOR	ROUGH	DOOR					FRAME		DOOR SWING					
SPACE NAME	TYPE	OPENING	WIDTH	HEIGHT	THICKNESS	MATERIAL	FINISH	MATERIAL	QUANTITY	LH	RH	LHR RH	COMMENTS		
MAIN ENTRY BASEMENT	1	60"X96"	5' - 0"	8' - 0"	0' - 1 1/2"	PVC	PAINT	WOOD	01				EXTERIOR DOUBLE DOOR, FULL GLASS		
EXIT BASEMENT	2	64"X96"	5' - 4"	8' - 0"	0' - 1 1/2"	PVC	PAINT	WOOD	01				EXTERIOR DOUBLE DOOR, FULL GLASS		
EXIT BEDROOM #2	3	29"X66"	3' - 2"	6' - 8"	0' - 1 1/2"	WOOD	PAINT	WOOD	01				EXTERIOR DOOR, FULL GLASS		

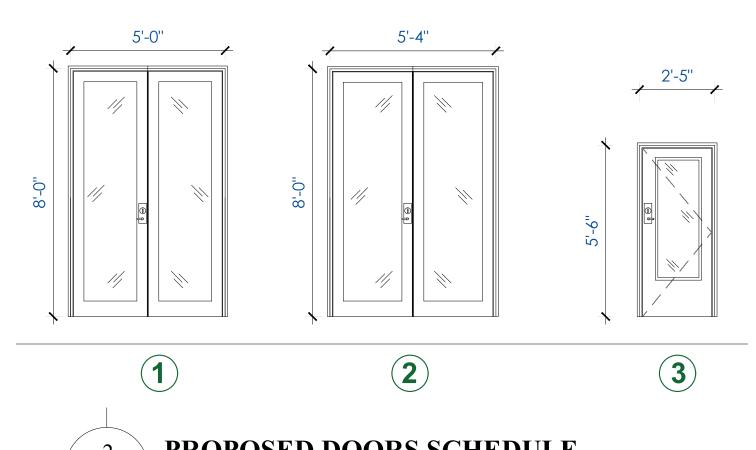

PROPOSED DOORS SCHEDULE AB-2.0/ SCALE: 1/4"=1'-0"

NOTE GENERAL CONTRACTOR TO CONFIRM WINDOWS AND DOORS SIZES WITH

OWNER PRIOR STARTING WORK.



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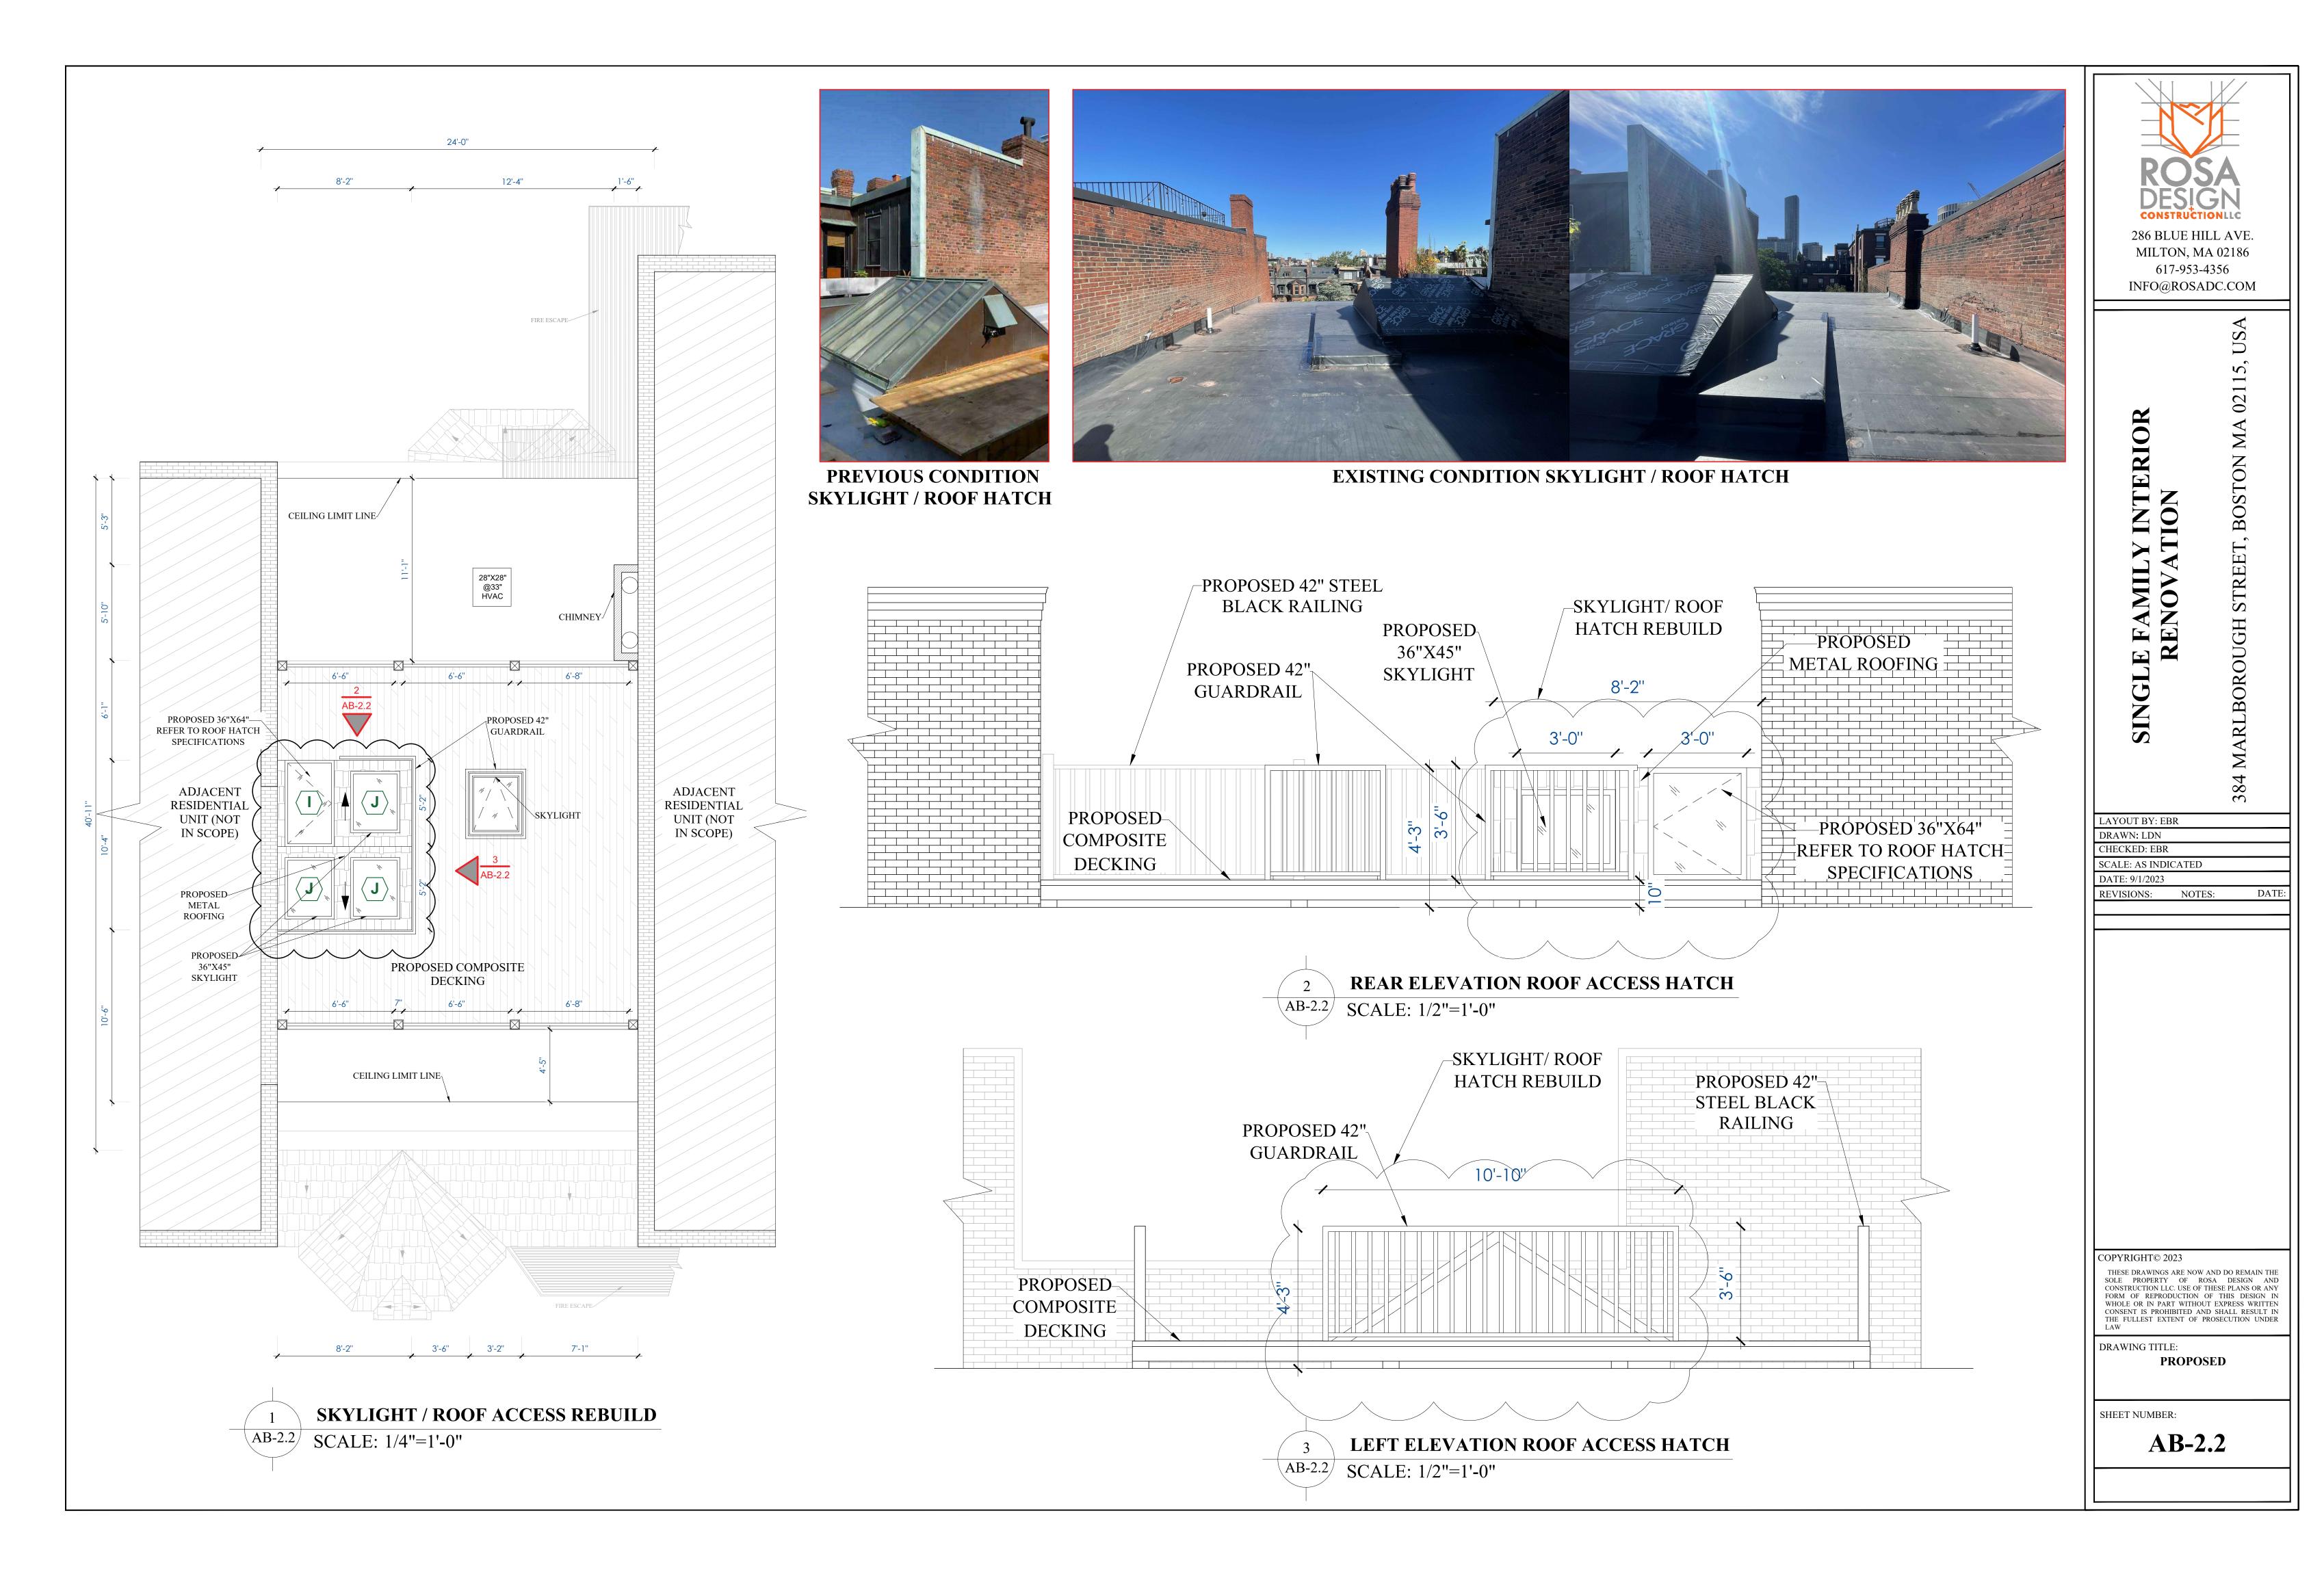
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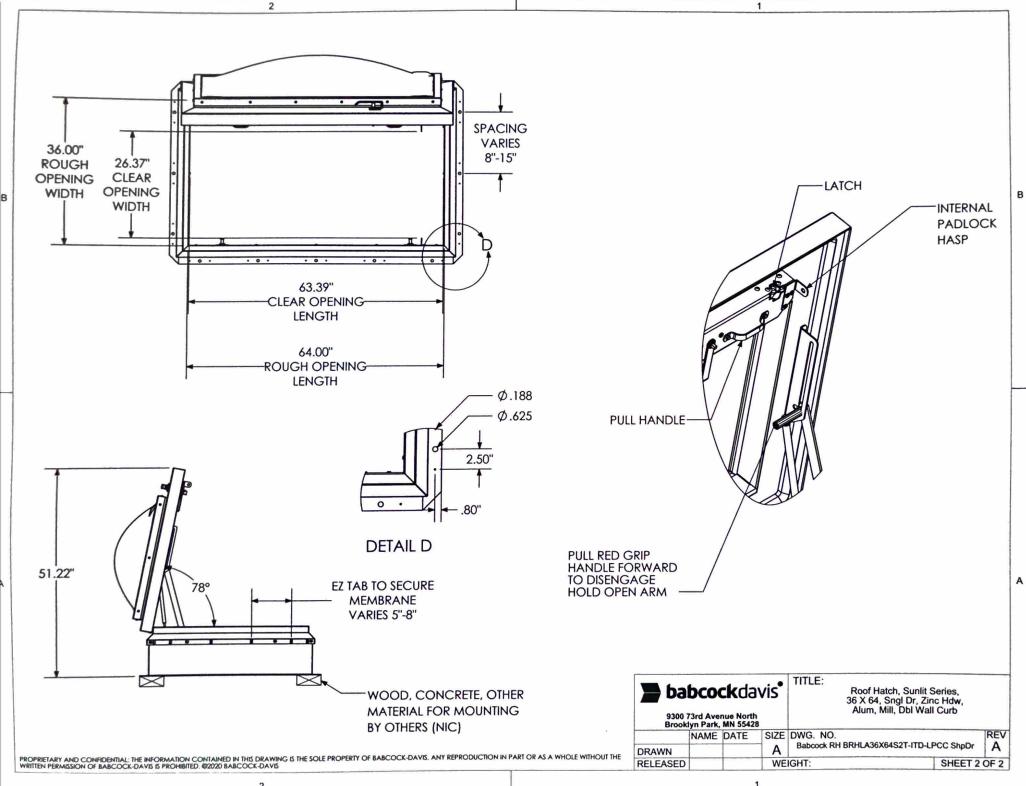
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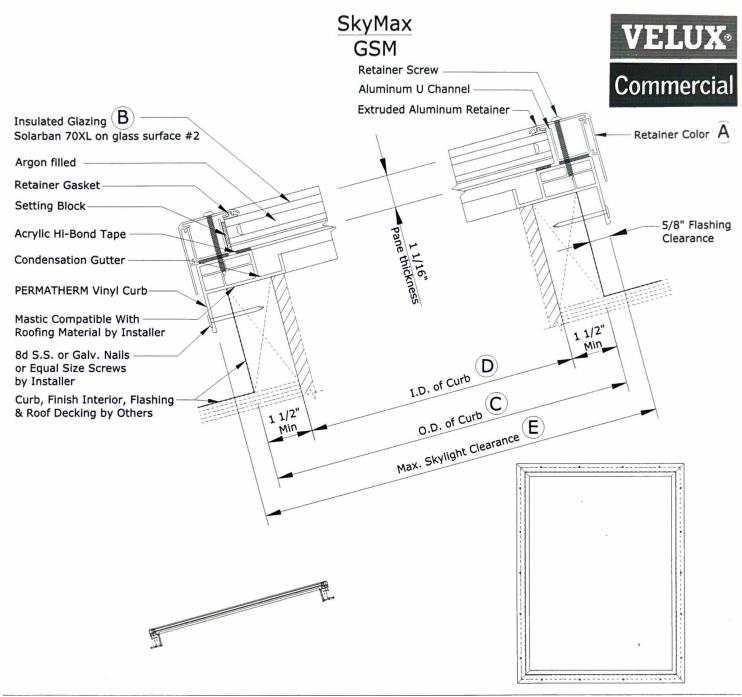
SHEET NUMBER:

**AB-2.0** 









### Skylight Details & Measurements

- A Finish: VELUX Grey
- ® Glazing:SOLARBAN® 70XL Clear Tempered /Clear Heat Strengthened Laminated or equivalent
- © OCD:48.75 in. x 78 in.
- D RO/ICD:45.75 in. x 75 in.
- (E) Max Clearance:50 in. x 79.25 in.

### **Skylight Testing & Certification**

Thermal (NFRC) Testing

Quote # VAT-CV7GNN Rev 1

Job Name

Line # on cover 1

GSM\_48757800\_0099100

Material # B





### J4HP4042A1000AA

TAG: \_\_\_\_\_\_

## SUBMITTAL

## 3.5 Ton Split System Heat Pump - 1 Phase J4HP4042A1000AA

#### **Product Specifications**

Product Specifications							
OUTDOOR UNIT	J4HP4042A1000AA						
POWER CONNS. — V/PH/HZ	208/230/1/60						
MIN. BRCH. CIR. AMPACITY	21.6						
BR. CIR. PROT. RTG MAX. (AMPS)	35						
COMPRESSOR	SCROLL						
NO. USED - NO. SPEEDS	1 - 1						
VOLTS/PH/HZ	208/230/1/60						
R.L. AMPS - L.R. AMPS	15.9-112.3						
FACTORY INSTALLED START COMPONENTS	NO						
INSULATION/SOUND BLANKET	NO NO						
COMPRESSOR HEAT	YES						
OUTDOOR FAN	PROPELLER						
DIA. (IN.) - NO. USED	23 - 1						
TYPE DRIVE - NO. SPEEDS	DIRECT - 1						
CFM @ 0.0 IN. W.G.	3700						
NO. MOTORS - HP	1 - 1/3						
MOTOR SPEED R.P.M.	1075						
VOLTS/PH/HZ F.L. AMPS	208/230/1/60 1.7						
OUTDOOR COIL — TYPE	PLATE FIN						
ROWS - F.P.I.	2 - 21						
FACE AREA (SQ. FT.)	17.4						
TUBE SIZE (IN.)	3/16						
REFRIGERANT CONTROL	ORIFICE						
REFRIGERANT							
LBS. — R-410A (O.D. UNIT)	8 LBS 3 OZ.						
FACTORY SUPPLIED	YES						
LINE SIZE - IN. O.D. GAS	3/4						
LINE SIZE - IN. O.D. LIQ.	3/8						
CHARGING SPECIFICATION	00.5						
SUBCOOLING	8º F						
DIMENSIONS	H X W X D 34-1/2x29x29						
CRATED (IN.)	34-1/2329329						
WEIGHT							
SHIPPING (LBS.)	212						
NET (LBS.)	201						

## AIR DISCHARGE: ALLOW 60" MINIMUM CLEARANCE. 00000000000000000000000000000 Н AIR INLETS LOUVERED **PANELS** ALLOW 12" MINIMUM **CLEARANCE** SERVICE ACCESS ALLOW 24" CLEARANCE NOTE: GRILL APPEARANCE MAY VARY. CONTROL WIRING 1

DETAIL A	SEE DET  KNOCKOU 1-11/32" (34.5mm)  HOLE 1-3/32" (27.8mm)	ALA TOTAL	CONTROL WIRIN 7/8" (22.2mm)
	SERVICI FITTING	E	SERVICE FITTING VAPOR LINE CONNECTION

#### NOTE: All dimensions are in mm/inches.

Model	Н	W	L	LIQUID VALVE SIZE	GAS VALVE SIZE
J4HP4042A1000AA	843 (33-3/16)	710 (28)	710 (28)	3/8	3/4

## Mechanical Specification Options

#### General

The J4HP40 is fully charged from the factory. This unit is designed to operate at outdoor ambient temperatures as high as 115°F. Cooling capacities are matched with air handlers and furnace coils that are AHRI certified. The unit is certified to ETL. Exterior is designed for outdoor application.

#### Casing

Unit casing is constructed of heavy gauge, Galvanized steel and painted with a weatherresistant powder paint on all grilles, panels, pre-paint on all other panels. And had 500hours salt spray tested.

#### Refrigerant Controls

Refrigeration system controls include condenserfan, compressor contactor, high pressure switch and low pressure switch. The factory installed crankcase heat can protect compress when it stands by.

#### Scroll Compressor

Features include low vibration and noise.

#### Condenser Coil

The outdoor coil provides low airflow resistance and efficient heat transfer. The coil is protected on all four sides by grille panels.

#### Optional accessories Liquid line drier —

It is used to filter out impurities and water in the system, ensures system clean and dry.





