







Design Study
Fixtures + shields mounted to new struts
Fixtures + shields rotated to follow aim









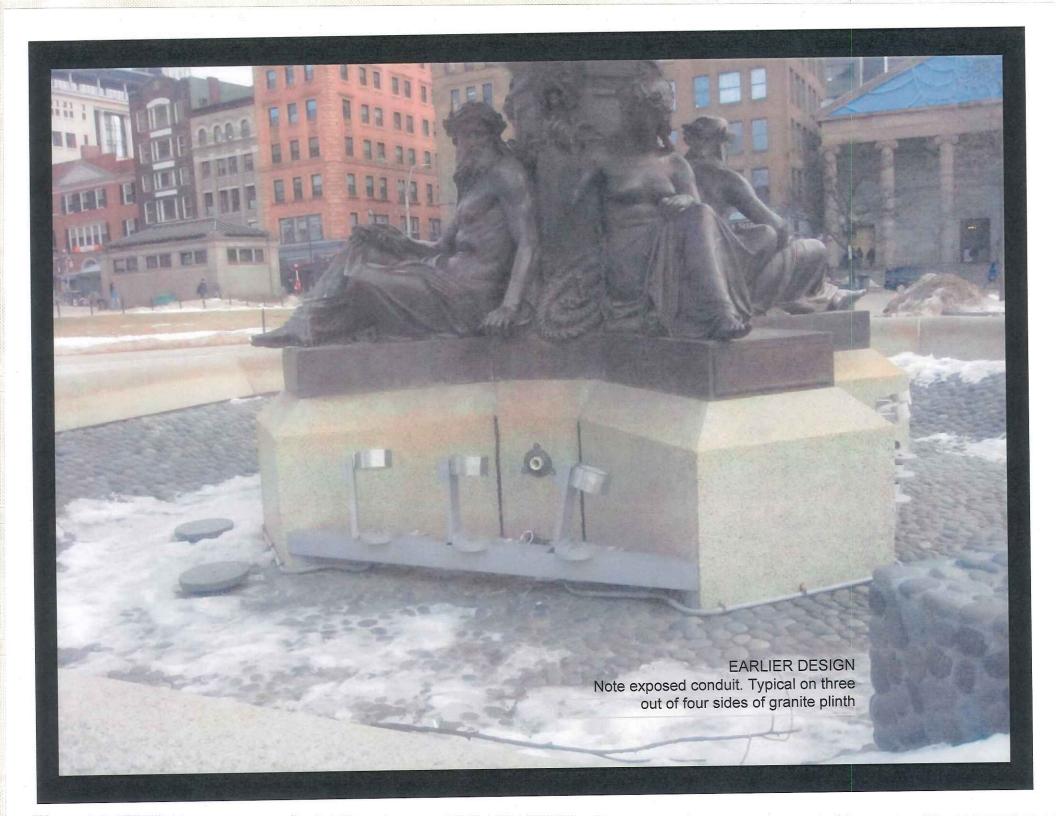


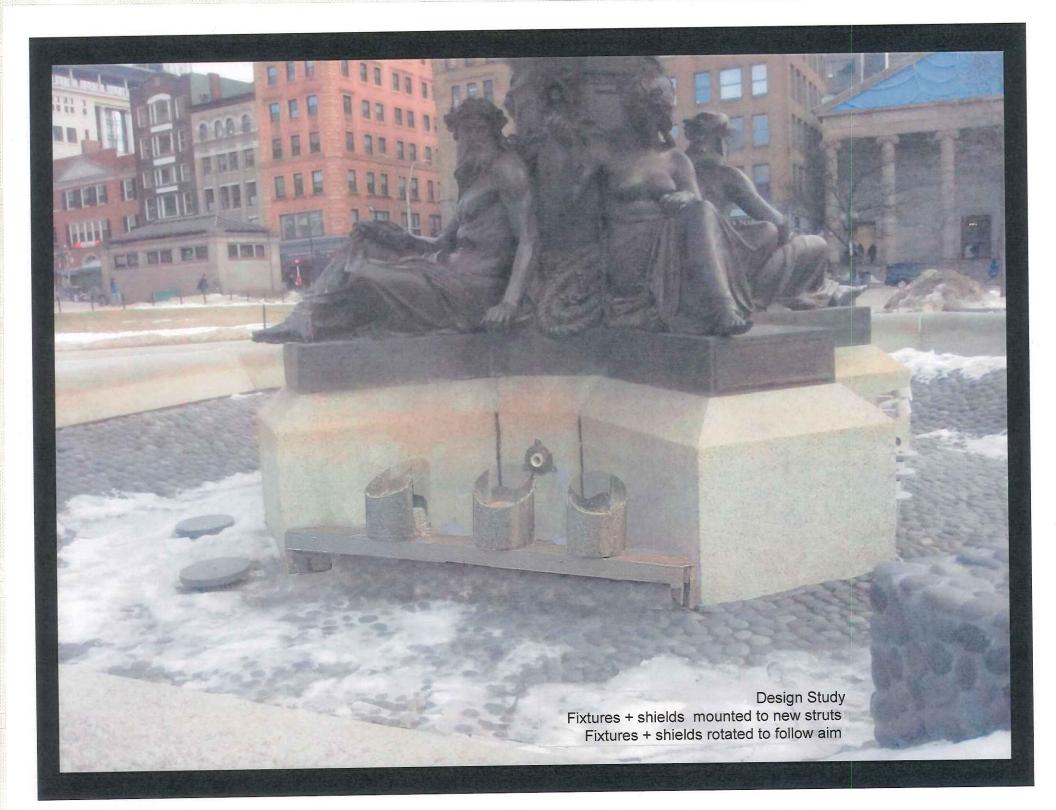


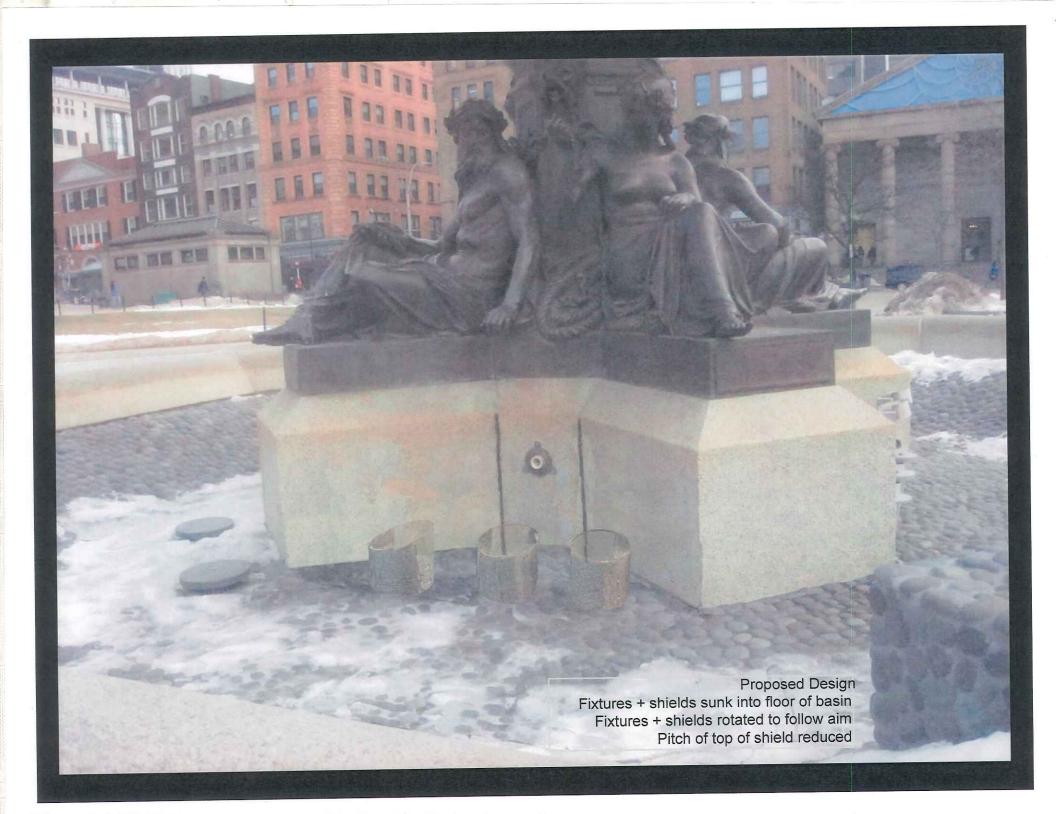

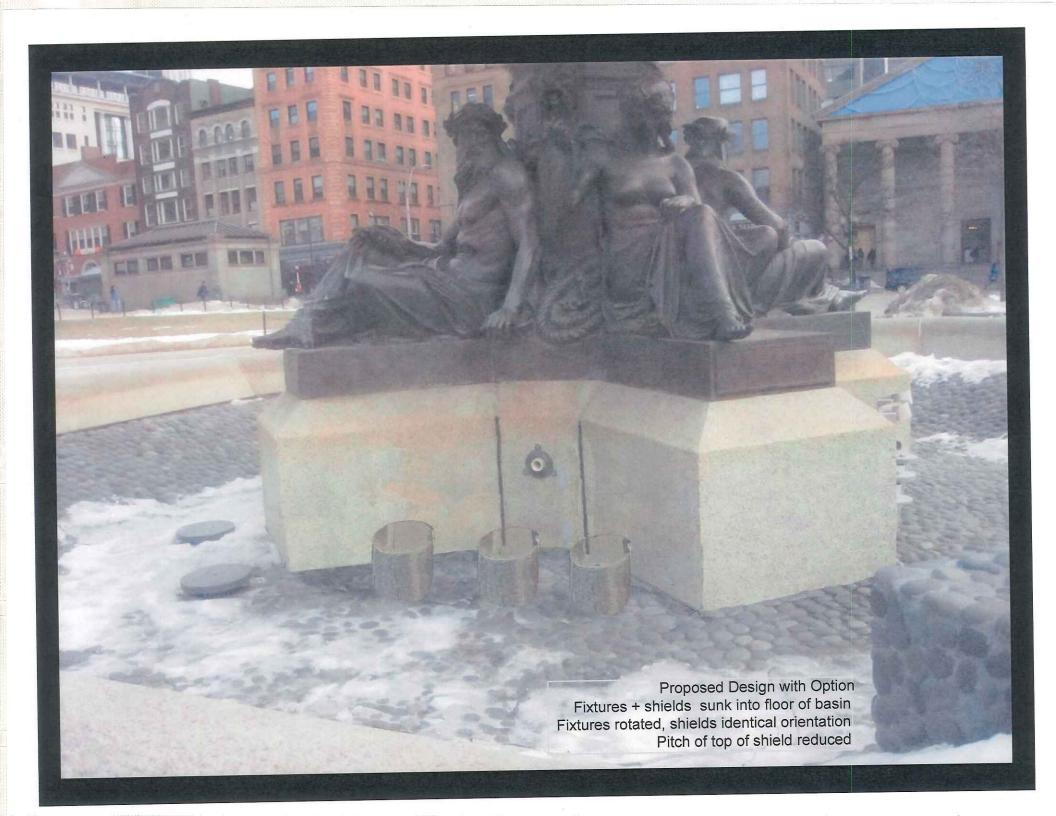



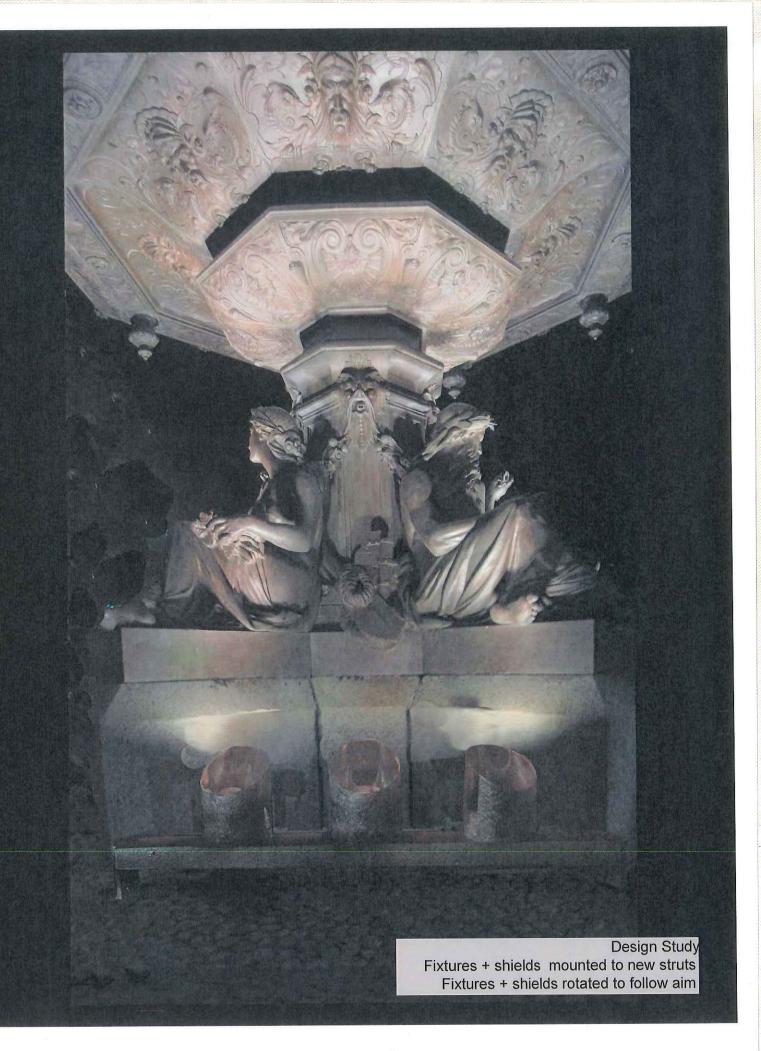

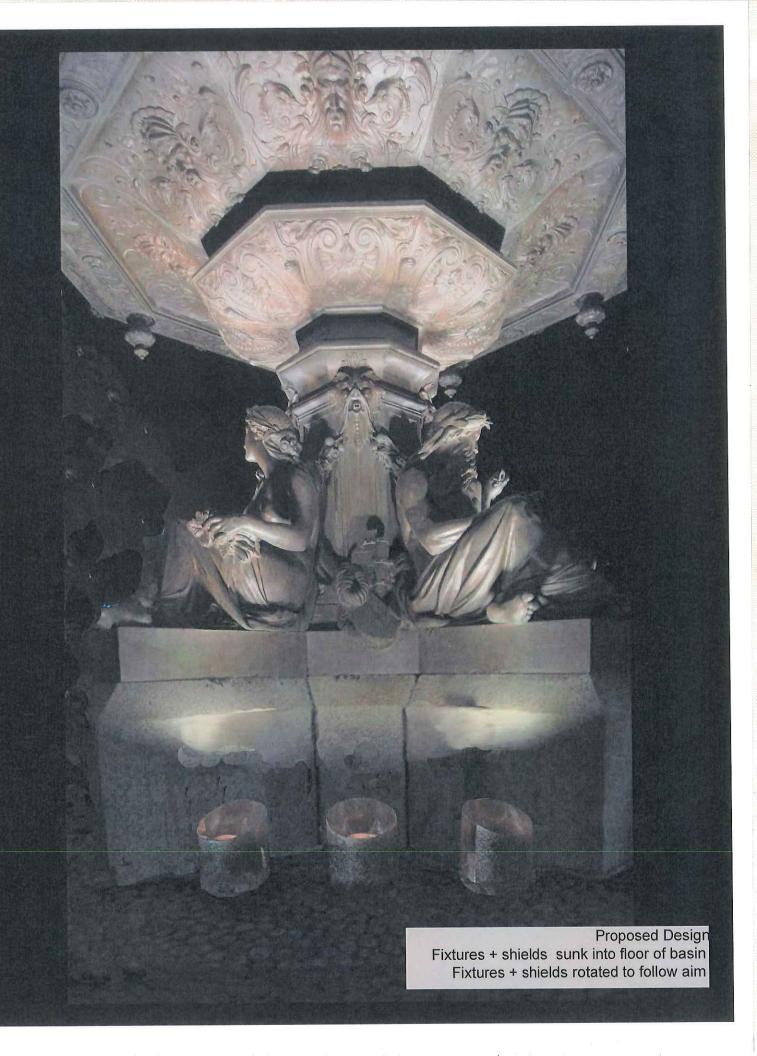











Client:

Project:

Type:

Order Code:

Quantity:

Aqua Drum is a series of high output, submersible, LED flood fixtures. It features an all stainless steel construction, included in-grade housing mounting option, and is submersible up to 20' (6M). Available in multiple color temperatures of white and color changing versions, it is ideal for outdoor facade wash, fountains, ponds, and landscape applications.

SPECIFICATIONS

2700K, 3000K, 3500K, 4000K, RGBW (W=4000K), RGBA Colors

10° x 10°, 25° x 25°, 40° x 40°, 10° x 60°, 10° x 35° **Beam Angles**

4000K 10° - EO: 700 lm / SO: 1600 lm / HO: 3259 lm **Photometrics**

EO (8 LED), SO (18 LED), HO (36 LED) **Fixture Sizes**

DMX via Aqua Driver 150, 0-10V via external UDM Control

EO & SO: 4 fixtures / **HO:** 2 fixtures Max Fixtures per Aqua Driver 150

EO: 8W / SO: 18W / HO: 36W **Power Consumption**

Operating Voltage L70 @ 150,000 hours (25° C) Lumen Maintenance

0.47" (11mm) mounting holes on mounting bracket Mounting

Silver / stainless steel, marine environment ready Finish

316 marine grade stainless steel housing, sealed glass top Material

24VDC, constant current

-40° F to 122° F (-40° C to 50° C) **Ambient Operating Temperature**

IP68, submersible up to 20' (6M) **IP Rating**

IK08, protection against 5 joule impact, walk over rated **IK Rating**

98.4' (30m) cable included, attached 8 pin terminal blocks **Fixture Connectors**

5 Years, limited Warranty

EO: 4 lbs (1.8kg) / **SO:** 6.6 lbs (3kg) / **HO:** 8 lbs (3.6kg) Weight

See page 4 Dimensions

Certifications


TERMINAL BLOCKS TO BE SUITABLE FOR FIELD REMOVAL AND REPLACEMENT FOR PULLING **CABLES** THROUGH CONDUIT





ORDER CODES

* indicates special order

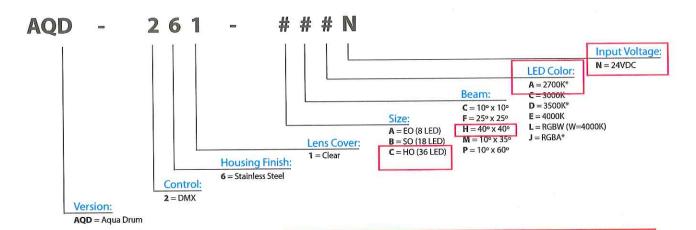

ACCLAIM "AQUA DRUM" #AQD-261-C-H-A-N

RELATED COMPONENTS

Mounting Accessories



AQD-IGH-EO

In-grade housing for Aqua Drum EO Includes sleeve, trim ring, and screws

AQD-IGH-SO

*In-grade housing for Aqua Drum SO*Includes sleeve, trim ring, and screws


AQD-IGH-HO

In-grade housing for Aqua Drum HO Includes sleeve, trim ring, and screws




RELATED COMPONENTS


Remote Driver / Power Supply

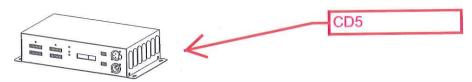

ADR150 Aqua Driver 150 100-277V Input, 24VDC + PWM Output Powers up to 4 Aqua Drum EO or SO units, or up to 2 Aqua Drum HO units


DIMENSIONS

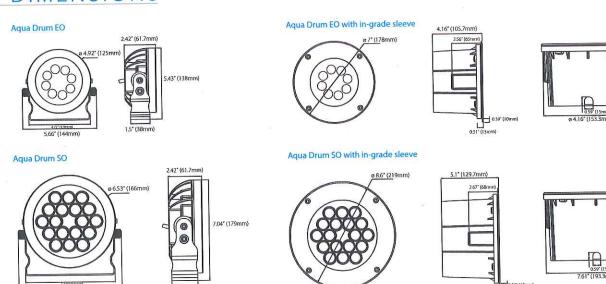

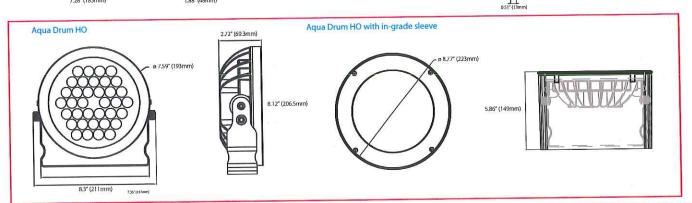



WIRING

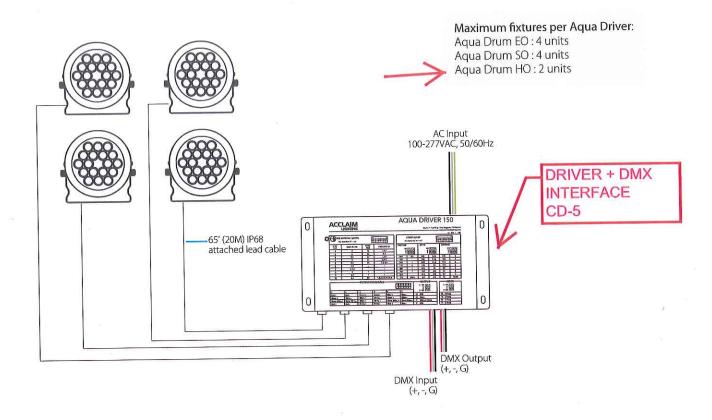

PHOTOMETRICS

Size / Color Temp	Lumens	Center Candela	Efficacy (I/pw)	CRI (Ra)	CRI (r9)
EO, 2700K	668	8006	41	81.5	æ
SO, 3500K	1568	20055	64	82.7	- - [
HO, 4000K	3259	41849	73	80.8	-
EO, RGBW	424	6502	27		-
		2700K REQUIRE	ĒD		

SPEC/规格: STOW 18AWGX5C	Customer/客户:	Co	ding/客户编码	5 :
DIAGRAMS OF/结	构图		EXPLAIN/产品	品说明
	导体 Conductor	STANDARD 参考标准		UL62
	,,,,,	INSTITUTIONS 认证机构		UL
MARKING/印字要		Rated Voltage 额定电压 (V)		600
		积足电压(1)		
 STOW 105 ℃ VW-1 18A			- SQ	
JINGYI 463217-001 600V¤C(L	IL) STOW 105°C	Temperature ra	ting	105
600V FT1 18AWG (0.82		额定温度(℃)		
Process parameters/				
Project/项目	parameters/技术参数			/中层州台
CONDUCTOR/导体	Bare copper/裸铜	Elec	trical Perform	ance/电气性能
CONSTRUCTIOM/构造规格	48/0.15TS±0.005		And A Desire of Street to	
	20.2	Conductor Resi		40
INSULATION/绝缘	PVC	子体电阻(22/10	m, 20°C) ≤22.	40
Nom. Thickness平均厚度(mm)	0.76			
Min. Thickness/最薄点厚度(mm)	0. 69 2, 5±0. 05			
OD/绝缘外径(m)	2, 5 ± 0. 05		深圳市首亮电子	子有限公司
ASSEMBLE/绞线	5C	SHENZHEN		ECTRONICS CO., LTD
FILLER/填充	PVC or other PVC条或其它			
			产品规格。	承认书
,		P	roduct specifi	cation Book
JACKET/护套	PVC		电话/TEL: 0755	-81758041
Nom. Thickness平均厚度(mm)	2.03			
Min. Thickness/最薄点厚度(mm)	1. 62			in the second se
DIAMETER/直径(mm)	12±0.5			
Extrude method/挤押方法	Tight/挤压	-		
	7-3-3-3	MAKE 制作 CHECK	林阳	The new version 新版发行
Colour/颜	<u></u>	审核	张小平	DATE日期:2018-05-03
	ite green red yellow	APPROVAL	T: 000 MC	DATE日期:2018-05-03
	自绿红 黄	核准	王亚新	DATE日期:2018-05-03
		Version版本	A/0	page页码: 1/1
JACKET/护套	black(黑)		ACKNOWLEDGED 中确认	









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Aqua Drum is a series of high output, submersible, LED flood fixtures. It features an all stainless steel construction, included in-grade housing mounting option, and is submersible up to 20' (6M). Available in multiple color temperatures of white and color changing versions, it is ideal for outdoor facade wash, fountains, ponds, and landscape applications.

SPECIFICATIONS

2700K, 3000K, 3500K, 4000K, RGBW (W=4000K), RGBA Colors 10° x 10°, 25° x 25°, 40° x 40°, 10° x 60°, 10° x 35° **Beam Angles**

4000K 10° - **EO**: 700 lm / **SO**: 1600 lm / **HO**: 3259 lm **Photometrics**

EO (8 LED), SO (18 LED), HO (36 LED) **Fixture Sizes**

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EO & SO: 4 fixtures / **HO:** 2 fixtures Max Fixtures per Aqua Driver 150

EO: 8W / SO: 18W / HO: 36W **Power Consumption** 24VDC, constant current Operating Voltage

L70 @ 150,000 hours (25° C) Lumen Maintenance

0.47" (11mm) mounting holes on mounting bracket Mounting

Silver / stainless steel, marine environment ready Finish

316 marine grade stainless steel housing, sealed glass top Material

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98.4' (30m) cable included, attached 8 pin terminal blocks **Fixture Connectors**

5 Years, limited Warranty

EO: 4 lbs (1.8kg) / **SO:** 6.6 lbs (3kg) / **HO:** 8 lbs (3.6kg) Weight

See page 4 **Dimensions**


Certifications

TERMINAL BLOCKS TO BE SUITABLE FOR FIELD REMOVAL AND REPLACEMENT FOR PULLING **CABLES THROUGH** CONDUIT



ORDER CODES

* indicates special order

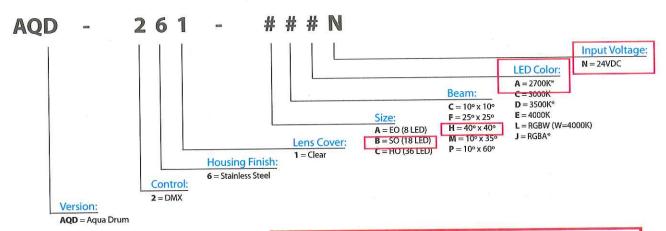

ACCLAIM "AQUA DRUM" #AQD-261-B-H-A-N

RELATED COMPONENTS

Mounting Accessories



AQD-IGH-EO

*In-grade housing for Aqua Drum EO*Includes sleeve, trim ring, and screws

AQD-IGH-SO

In-grade housing for Aqua Drum SO Includes sleeve, trim ring, and screws

AQD-IGH-HO

In-grade housing for Aqua Drum HO Includes sleeve, trim ring, and screws




RELATED COMPONENTS

Remote Driver / Power Supply



ADR150 Aqua Driver 150 100-277V Input, 24VDC + PWM Output Powers up to 4 Aqua Drum EO or SO units, or up to 2 Aqua Drum HO units


DIMENSIONS

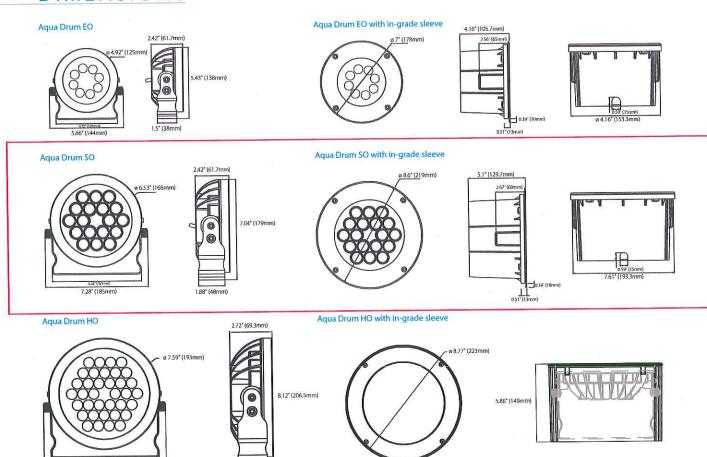

8.3" (211mm)



WIRING

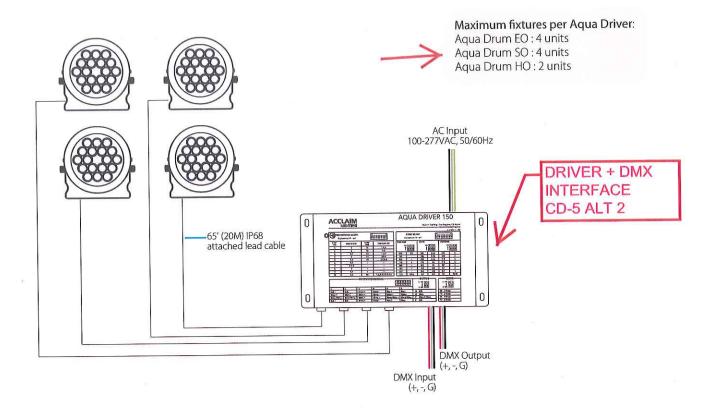

PHOTOMETRICS

Size / Color Temp	Lumens	Center Candela	Efficacy (I/pw)	CRI (Ra)	CRI (r9)
EO, 2700K	668	8006	41	81.5	0
>> SO, 3500K	1568	20055	64	82.7	=
HO, 4000K	3259	41849	73	80.8	12
EO, RGBW	424	6502	27	2	-

PEC/规格: STOW 18AWGX5C	Customer/客户:	Co	oding/客户编码	
DIAGRAMS OF/结	构图		EXPLAIN/产。	品说明
	导体 Conductor	STANDARD 参考标准		UL62
	绝缘 Insulation 填充 Filler 护套 Jacket	INSTITUTIONS 认证机构		ÜL
MARKING (FIRE II	4-11	Rated Voltage		600
MARKING/印字罗		额定电压(V)		
 STOW 105 °C VW-1 18A				
JINGYI 463217-001 600V#C(UL) STOW 105℃		Temperature ra	iting	105
600V FT1 18AWG (0.824mm2) x5C		额定温度(℃)		
Process parameters,		(
Project/项目	parameters/技术参数			/ th / th Ah
CONDUCTOR/导体	Bare copper/裸铜	Elec	ctrical Perform	nance/电气性能
CONSTRUCTIOM/构造规格	48/0.15TS±0.005	- 1		
	2002	Conductor Res		40
INSULATION/绝缘	PVC	导体电阻(Ω/Ι	an, 20°C) ≤22.	40
Nom. Thickness平均厚度(mm)	0.76	-		
Min. Thickness/最薄点厚度(mm)	0.69	4		
OD/绝缘外径 (mm)	2.5±0.05		深圳市首亮电	子有限公司
Aggunt p //dc/b	5C	SHENZHEN		ECTRONICS CO., LTD
ASSEMBLE/绞线	PVC or other	SHEREIDI	T DIOC LILLO LL	,
FILLER/填充	PVC条或其它			
	170米以来日		产品规格	承认书
		1	Product specifi	40.20.1
JACKET/护套	PVC	- s	电话/TEL: 0755	
Nom. Thickness平均厚度(mm)	2, 03			
Min. Thickness/最薄点厚度(mm)	1.62			,
DIAMETER/直径(m)	12±0.5			
Extrude method/挤押方法	Tight/挤压]		
		MAKE	林阳	The new version
,		制作 CHECK	张小平	新版发行
Colour/颜	色	审核		DATE日期:2018-05-03
DESCRIPTION OF THE PROPERTY OF	nite green red yellow	APPROVAL	王亚新	DATE日期:2018-05-03
绝缘 黑	白绿红 黄	核准	4	DATE日期:2018-05-03
JACKET/护套	black(黑)	Version版本 CUSTOMER	A/O ACKNOWLEDGED	page页码: 1/1
5		客	户确认	











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Project:

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Order Code:

Quantity:

Aqua Drum is a series of high output, submersible, LED flood fixtures. It features an all stainless steel construction, included in-grade housing mounting option, and is submersible up to 20' (6M). Available in multiple color temperatures of white and color changing versions, it is ideal for outdoor facade wash, fountains, ponds, and landscape applications.

SPECIFICATIONS

Colors

Beam Angles

Photometrics

Fixture Sizes

Control

Max Fixtures per Aqua Driver 150

Power Consumption

Operating Voltage

Lumen Maintenance

Mounting

Finish

Material

Ambient Operating Temperature

IP Rating

IK Rating

Fixture Connectors

Warranty

Weight

Dimensions

Certifications

2700K, 3000K, 3500K, 4000K, RGBW (W=4000K), RGBA

10° x 10°, 25° x 25°, 40° x 40°, 10° x 60°, 10° x 35°

4000K 10° - EO: 700 lm / SO: 1600 lm / HO: 3259 lm

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0.47" (11mm) mounting holes on mounting bracket

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-40° F to 122° F (-40° C to 50° C)

IP68, submersible up to 20' (6M)

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98.4' (30m) cable included, attached 8 pin terminal blocks

5 Years, limited

EO: 4 lbs (1.8kg) / **SO:** 6.6 lbs (3kg) / **HO:** 8 lbs (3.6kg)

See page 4




CE

TERMINAL
BLOCKS TO BE
SUITABLE FOR
FIELD REMOVAL
AND
REPLACEMENT
FOR PULLING
CABLES
THROUGH
CONDUIT



ORDER CODES

* indicates special order

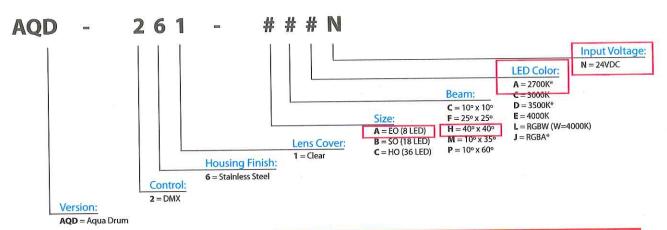

ACCLAIM "AQUA DRUM" #AQD-261-A-H-A-N

RELATED COMPONENTS

Mounting Accessories



AQD-IGH-EO

In-grade housing for Aqua Drum EO Includes sleeve, trim ring, and screws

AQD-IGH-SO

In-grade housing for Aqua Drum SO Includes sleeve, trim ring, and screws


AQD-IGH-HO

In-grade housing for Aqua Drum HO Includes sleeve, trim ring, and screws


ACCLAIVI


RELATED COMPONENTS

Remote Driver / Power Supply

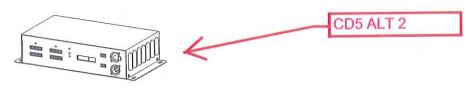


ADR150 Aqua Driver 150 100-277V Input, 24VDC + PWM Output Powers up to 4 Aqua Drum EO or SO units, or up to 2 Aqua Drum HO units

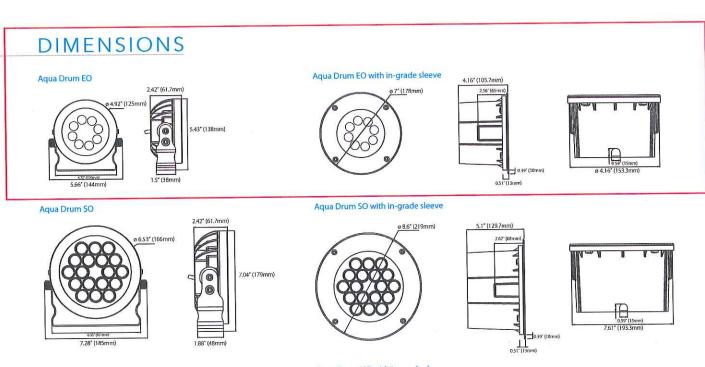

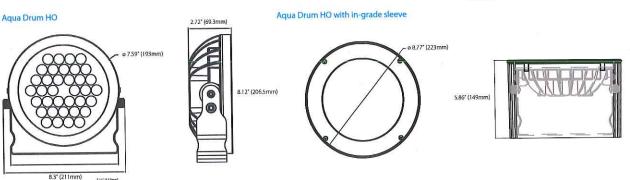



WIRING

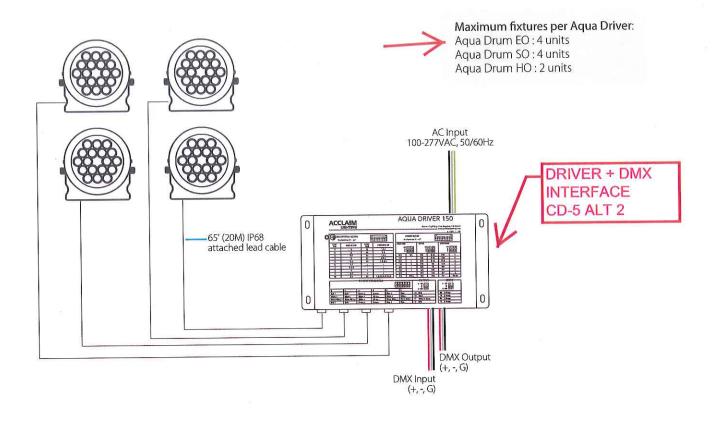

PHOTOMETRICS

Size / Color Temp	Lumens	Center Candela	Efficacy (I/pw)	CRI (Ra)	CRI (r9)
EO, 2700K	668	8006	41	81.5	
SO, 3500K	1568	20055	64	82.7	
HO, 4000K	3259	41849	73	80.8	-
EO, RGBW	424	6502	27	-	

PEC/规格: STOW 18AWGX5C	Customer/客户:	Со	ding/客户编码		
DIAGRAMS OF/结	构图		EXPLAIN/产品	站况明	
	导体 Conductor	STANDARD 参考标准		UL62	
	绝缘 Insulation 填充 Filler 护套 Jacket	INSTITUTIONS 认证机构		UL	
MARKING/印字要		Rated Voltage 额定电压 (V)		600	
 STOW 105 ℃ VW-1 18A					
JINGYI 463217-001 600V#C(U	JL) STOW 105℃	Temperature ra 额定温度 (℃)	ting	105	
Process parameters					
Project/项目	parameters/技术参数		1 D	/中层料的	
CONDUCTOR/导体	Bare copper/裸铜	Elec	trical Perform	ance/电气性能	
CONSTRUCTIOM/构造规格	48/0.15TS±0.005	6 1 . P .			
	l mra	Conductor Resi		40	
INSULATION/绝缘	PVC	导体电阻(Ω/k	m, 20 C) ≤22.	40	
Nom. Thickness平均厚度 (mm)	0. 76	ļ,			
Min. Thickness/最薄点厚度(mm)	0.69				
OD/绝缘外径(mm)	2.5±0.05		深圳市首亮电	子有限公司	
AGGRAPI D //dr AB	5C	SHENZHEN		ECTRONICS CO., LTD	
ASSEMBLE/绞线	PVC or other	GILLIDIO	phot Billio Bi		
FILLER/填充	PVC of other				
	110次级天日		产品规格	承认书	
		P	roduct specifi	5 56	
JACKET/护套	PVC		电话/TEL: 0755	5-81758041	
Nom. Thickness平均厚度 (mm)	2. 03				
Min. Thickness/最薄点厚度 (mm)	1. 62				
DIAMETER/直径 (mm)	12±0.5				
Extrude method/挤押方法	Tight/挤压	1			
		1	-		
		MAKE 制作	林阳	The new version 新版发行	
Colour/颜	色,	CHECK 审核	张小平	DATE日期: 2018-05-03	
2 10 10 10 10 10 10 10 10 10 10 10 10 10	nite green red yellow	APPROVAL		DATE日期:2018-05-03	
199	inte green red yellow 白绿红黄	核准	王亚新	DATE日期:2018-05-03	
绝缘		Version版本	A/0	page页码: 1/1	
JACKET/护套	black(黑)	CUSTOMER	ACKNOWLEDGED 户确认		

LP[G]MM[B]-7-27[-24-58] 'Great White'

Low Profile MiMo Antenna

31/03/2016 v.2

Low Profile MiMo Antenna

Rugged low profile design 2x Wideband LTE/cellular elements Optional integrated GPS antenna Optional MiMo WiFi

The Panorama LP[G]MM low profile MIMO antenna range has been designed to support the new generation of vehicular LTE routers.

The antenna enclosure contains two to five isolated high performance antenna elements; two ultra-wideband elements covering 698-2700MHz support MiMo/diversity at cellular/LTE frequencies and in the case of the LGMM range a high performance GPS antenna with an integrated 26dB gain LNA and high quality filtering to combat noise. There are also variants incorporating two dualband WiFi elements covering 2.4/4.9-6.0GHz designated by the suffix 24-58.


The antenna does not require a metallic ground plane, and maintains a high level of performance even when mounted on a non-metallic surface.

The GPS module in the LP[G]MM carries an E11 Mark type approval under ECE R10.4 and versions with FAKRA cables (L[G]MMF) and 3 x 3 WiFi (LGMTM-7-27-24-58) are also available.





Technical Drawing LGMM-7-27-24-58 Shown

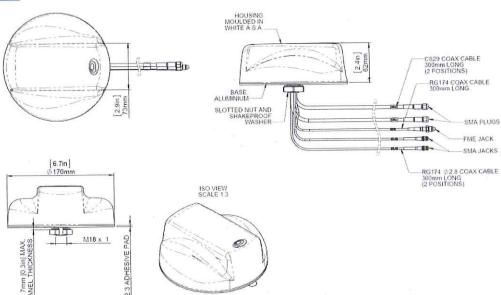


PANORAMA 🔛 ANIENNAS

	ANTEN	NA PANORAI	MA#			Product Data
art No.	LPMM-7	7-27-24-58		Trans.		
			LPMM-7-27	LGMM-7-27	LGMM-7-27-24-58	LPMM-7-27-24-58
lectrical Data	No. of Concession,					
requency Range (M	Hz)	3.2		698-960 /		
reducties transe (in	Elements 38	<u>84</u>	2	* (No. of Contract of	9-6GHz
perational Bands	Elements 18	32	WILLIAM STATE OF STREET	LTE / C	The same of the sa	
	Elements 38					/iFi
	Elements 1			2.3		
eak Gain: Isotropic	1,000	1710-2700MHz		50	lBi	do:
	Elements 3			- 11	and the same of th	dBi
solation	Elements 1				5dB	
Correlation Co-efficie	ent Elements 1	&2			0.1	
Polarisation			illianista ilianista		tical DO	
mpedance		and the same of th	ministra e de la composiçõe de la compos		00	
Max Input Power (W						and the second
SPS Data		THE THE PARTY OF THE PARTY OF THE PARTY.		11	575	
Frequency Range (N	nHz)				± 4MHz	
VSWR					idB	
Gain: LNA					fed via coax)	-
Operating Voltage					E R10.4)	
Type Approval				211/12		10000
Mechanical Data	Uelekt			2.4" (62mm)	
Dimensions	Height Diameter				176mm)	
Operating Temp	Diameter				(-30° / +80°C)	
Colour			White (Blac	k also available - add [B		e.g., LGMMB)
Ingress Protection					ate No. 45214)	
Approx. Weight (g)					180	
Mounting Data		A 77 A 4 A	Control of the Control		With the same	
Mounting type		10.		Pane	mount	
Max panel thicknes	c			0.27	′(7mm)	
Mounting hole					(19mm)	
Cable Data						
	Туре			CS29 (double	shielded RG58)	
	Diameter	WIII		0.2*	(Smm)	
Cell / LTE Cables	Length			1' (0.3m)	
	Termination	a sulli littocare sul list a sul		SM	A Plugs	
	Туре			R	G174	V
	Diameter	111111111111111111111111111111111111111	*	0.11"	(2.8mm)	
GPS Cable	Length			1'	(0,3m)	
	Termination		2	FN	IE Jack	-
	Туре			*		RG174
Vertical Color of the	Diameter			- 7	0.11	" (2.8mm)
WiFi Cables	Length			-	1'	(0.3m)
	Termination			-	SA	//A Jacks

Waiver: The data given above is indicative of the performance of the product/s under particular conditions and does not imply a guarantee of performance. These specifications are subject to change without notice.


PANORAMA P ANTENNAS

Typical 3D Pattern - Elements 1&2 700MHz

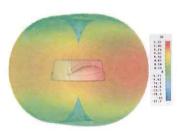


Typical 3D Pattern - Elements 1&2 1800MHz


Typical 3D Pattern - Elements 1&2 2400MHz

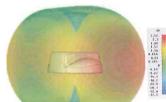


Typical 3D Pattern - Elements 1&2 800MHz

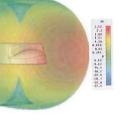

Typical 3D Pattern - Elements 1&2 1900MHz

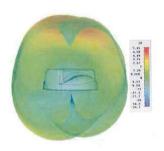


Typical 3D Pattern - Elements 1&2 2500MHz

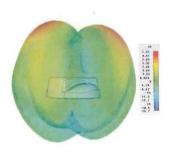


N.B. All pattern and gain measurements taken on a 400×400 mm (2' \times 2') ground plane without additional cable.


Typical 3D Pattern - Elements 1&2 900MHz

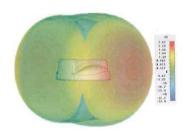


Typical 3D Pattern - Elements 1&2 2100MHz

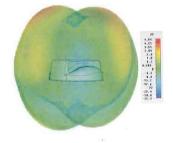


Typical 3D Pattern - Elements 1&2 2600MHz

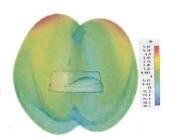


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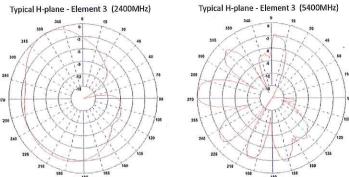


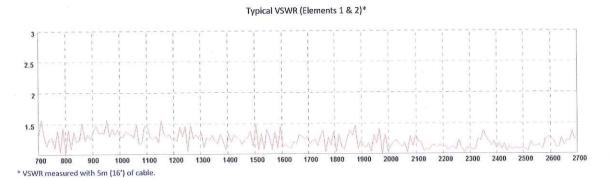Typical Isolation (elements 1 & 2)*

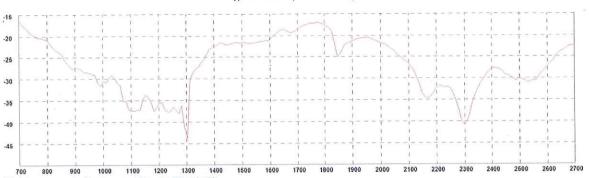

* Isolation measured without a groundplane or additional cable



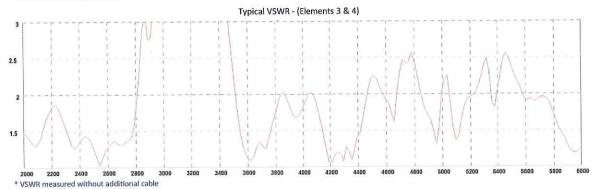

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10x8x5 Inch Weatherproof Industrial Enclosure with Corner Screws and Blank Non-Metallic Mounting Plate - Model: NBC100805-KIT01

Applications

- · Wireless LAN WiFi equipment installations
- Indoor and outdoor installations
- Industrial control equipment installations
- · High temperature or corrosive environments
- Hydraulic or pneumatic control installations

Features

- Rugged FRP Material with gasketed lid
- Stainless steel cover screws
- Excellent temperature range
- UL/CSA/NEMA/IP rated
- Includes blank Non-Metallic Starboard mounting plate






Description

The NBC series is a UL/CSA® Listed rugged weatherproof enclosure that is ideal for both indoor and outdoor applications. Constructed from molded halogen free self extinguishing fiberglass reinforced polyester, it is well suited for high temperature or corrosive environments. The integral mounting flange allows it to be wall mounted as well as on a flat surface without the need for extra mounting hardware. The fully gasketed lid features four stainless steel captive screws that secure the cover to the base by means of four threaded brass inserts contained in the base that provide a weather-proof seal protecting the contents inside. The light grey color of the NBC series is cleaner, cooler and more aesthetically pleasing. Users can enjoy the physical benefits of better heat reflection and better UV resistance due to the lighter color. The contoured body provides an attractive and contemporary appearance.


The NBC series is ideal for custom applications, which may require special modifications to the enclosure. Contact L-com with your custom requirements and let us provide it for you. Integral mounting stand-offs inside the enclosure can be used for mounting plates.

The NBC100805-KIT01 includes a Blank Non-Metallic Starboard Mounting Plate permitting free form layout of equipment. The Enclosure and Mounting Plate combination is ideal for custom applications. Mounting stand-offs inside the enclosure are used to secure the Mounting Plate.

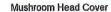



Ribbed Cover Corners

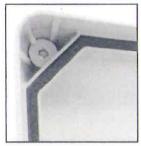

Molded Mounting Flanges





Specifications

Enclosure Specifications

Enclosure Material	Halogen free, self extinguishing fiberglass reinforced polyester (FRP)		
Enclosure Color	Light Grey (RAL 7036)		
Weight	6.0 lbs (2.72 kg)		
Outside Dimensions (max)	9.30 x 11.31 x 5.43 in (236 x 287 x 137mm)		
Inside Dimensions	8.00 x 10.00 x 4.69 in (203 x 254 x 119mm)		
Temperature Ratings	Continuous: -58°F to 302°F (-50°C to 150°C) Momentary exposure up to 392°F (200°C).		
UL and CSA Approved	Yes		
RoHS Compliant	Yes		
NEMA Ratings*	Type 3, 3R, 3S, 4, 4X, 12 and 13		
IEC 529 Ratings*	IP66-11		

^{*}Ratings prior to modifications

Mounting Plate Specifications

Plate Material	Non-Metallic Starboard	
Dimensions	7.0 x 9.0 in. (177 x 228 mm)	***************************************



Lighting Design Prepared by:

RIPMAN LIGHTING CONSULTANTS

3 LEXINGTON STREET BELMONT, MA 02478 (617) 489-3366 FAX (617) 489-5223

www.ripmanlighting.com

In Association with:



www.barbizon.com

3 Draper St. Woburn, MA Phone: 1(800) 935-3920

Electrical Engineering Prepared by:

Ronald W. Buia, Inc. Electrical Engineers

5 Tilton Lane Andover, MA 01810 Tel: 978-475-5184 RBUIA@BUIAENGINEERING.COM

Civil Engineering Prepared by:



Project Funded by the: Friends of the Public Garden






Lighting Improvements to the Brewer Fountain

In cooperation with the:

City of Boston

Boston Parks & Recreation Department

Boston, Massachusetts

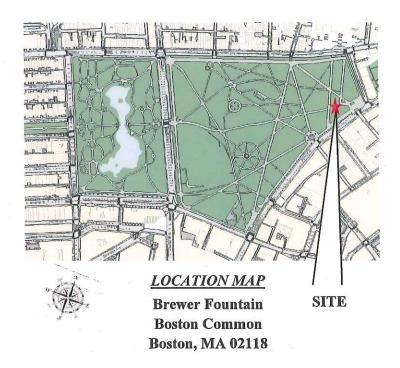

June 19, 2019

60% PROGRESS SET
- NOT FOR CONSTRUCTION -

DRAWING INDEX:

Sheet C1—General Notes

Sheet C2—Existing Conditions Plan

Sheet C3—Site Plan

Sheet C4—Civil Details

Sheet C5 –Site Photographs (Vault install)

Sheet C6—Record Vault Structural Drawings

Sheet E1—Site Power Plan

Sheet E2—Vault Layout Plan

Sheet E3—Electrical Specifications and Notes

Sheet LC1- Drawing Index

Sheet LC2-Bill of Materials

Sheet LC3-Rack Detail -Closed

Sheet LC4- Rack Detail- Open

Sheet LC5—Lighting Control System Riser

Sheet LC6- Control Equipment Tray

Sheet LC7- LED Driver Tray

Sheet R1—Existing lighting Plan

Sheet R2—Proposed Lighting Plan

Sheet R3—Existing Site Reference Plans and Elevation

Sheet R4—Proposed Site Reference Plan, Elevation, and Images

Sheet R5—Lighting Schedule and Notes

GENERAL NOTES:

- 1. THE EXISTING CONDITIONS FIELD SURVEY WAS CONDUCTED BY BRYANT ASSOCIATES IN 2008, 2010 AND 2013 ALONG WITH PROPOSED CONDITIONS FROM BRYANT ASSOCIATES AND PRESSLEY ASSOCIATES FROM 2014.
- THE FIELD SURVEY INFORMATION WAS SUPPLEMENTED WITH RECORD INFORMATION OBTAINED FROM THE BOSTON PARKS AND RECREATION DEPARTMENT, THE STREET LIGHTING DIVISION OF BOSTON PUBLIC WORKS DEPARTMENT AND THE MBTA.
- 3. THE HORIZONTAL DATUM IS ASSUMED.
- 4. THE VERTICAL DATUM IS BOSTON CITY BASE.
- 5. CONTRACTOR TO ACCESS SITE FROM CHARLES STREET @ BEACON STREET ENTRANCE.
- ALL WORK MUST MEET OR EXCEED THE BOSTON WATER AND SEWER COMMISSION AND THE BOSTON PUBLIC WORKS DEPARTMENT STANDARD REQUIREMENTS.
- UNDERGROUND UTILITIES ARE BASED UPON FIELD OBSERVATIONS AND PLANS OF RECORD. THESE
 UTILITIES ARE NOT WARRANTED TO BE CORRECT NOR IS IT WARRANTED THAT ALL UNDERGROUND UTILITIES
 ARE SHOWN.
- B. REFER TO LANDSCAPE PLANS FOR SITE LAYOUT, CURB, GRADING, AND PAVING MATERIALS.
- CONTRACTOR SHALL VERIFY ALL EXISTING CONDITIONS & REPORT ANY DISCREPANCIES BEFORE PROCEEDING WITH CONSTRUCTION.
- CONTRACTOR SHALL NOTIFY DIG-SAFE AT 1-800-DIG-SAFE (344-7233) AT LEAST 72 HOURS (EXCLUDING SATURDAYS, SUNDAYS, AND HOLIDAYS) BEFORE STARTING ANY EXCAVATION IN PUBLIC OR PRIVATE PROPERTY.
- 11. PEDESTRIAN WALKWAY OPENINGS SHALL BE SECURELY COVERED AT END OF EACH DAY'S OPERATION TO ENSURE SAFE PASSAGE.
- 12. CONTRACTOR SHALL COORDINATE WITH THE UTILITY COMPANIES BEFORE STARTING ANY UTILITY WORK.
- 13. THE CONTRACTOR SHALL ERECT AND MAINTAIN BARRICADES, FENCES, ETC. AROUND THE PROJECT SITE TO PROTECT THE PUBLIC FROM INJURY AND TO MAINTAIN PEDESTRIAN AND VEHICULAR TRAFFIC.
- 14. ALL STAGING, STORAGE, AND OTHER AREAS USED BY THE CONTRACTOR DURING THE COURSE OF CONSTRUCTION SHALL BE RETURNED TO ORIGINAL CONDITION AT NO ADDITIONAL COST TO OWNER. ALL DISTURBED LAWN AREAS TO BE LOAMED AND SEEDED PER SEEDED LAWN DETAIL ON SHEET C-4. THERE SHALL ABSOLUTELY BE NO STAGING, STOCKPUING OF ANY MATERIAL, OR PARKING UNDER THE DRIPLINE OF ANY AND ALL TREES BOTH WITHIN AND OUTSIDE THE PROJECT LIMIT OF WORK.

CONSTRUCTION ACCESS NOTES

- CONTRACTOR SHALL EMPLOY SPECIAL CARE IN SCHEDULING CONSTRUCTION SO AS TO MINIMIZE DISRUPTION TO SURROUNDING ACCESSIBLE, PEDESTRIAN, AND VEHICULAR TRAFFIC INCLUDING THE ON-GOING USE AND ACCESS TO THE MIST HEADHOUSE AND PARK PEDESTRIAN ROUTES.
- CONTRACTOR SHALL ENPLOY SPECIAL CARE AND USE SIGNAGE OR OTHER APPROPRIATE METHODS TO PROTECT SAFETY OF PEDESTRIANS INSIDE AND OUTSIDE OF CONTRACT LIMIT OF WORK LINE.
- CONTRACTOR SHALL KEEP A CLEAR, ACCESSIBLE PEDESTRIAN ROUTE AROUND SITE AT ALL TIMES. ANY BLOCKING OF PEDESTRIAN ROUTES SHALL BE SCHEDULE IN ADVANCE AND APPROVED BY FOPG.
- 4. THE CONTRACTOR SHALL TO PROVIDE A MATERIALS DELIVERY PLAN, INCLUDING A MAP AND DELIVERY ROUTE, TO ALL MATERIAL SUPPLIERS INDICATING THE PREFERRED TRUCK ROUTE AND ENTRANCE POINT TO BOSTON COMMON AT BEACON STREET AND CHARLES STREET.
- 5. CONTRACTOR, SUBCONTRACTOR, AND ALL DELIVERY VEHICLES FOR CONTRACTORS SHALL ABIDE BY THE PARK-WIDE 5 MPH SPEED LIMIT. ALL VEHICLES SHALL USE FLASHERS. PARK RANGERS MAY BE REQUIRED TO ESCORT LARGE DELIVERY VEHICLES THROUGH PARK. ANY COSTS INCURRED FOR RANGER AND/OR POLICE DETAILS ARE THE RESPONSIBILITY OF THE CONTRACTOR. ALL LARGE DELIVERIES MUST BE SCHEDULED AND PERMISSION GRANTED IN ADVANCE.

LIMIT OF WORK:

1. PROPOSED LIMIT OF WORK IS NOTED ON C-3. CONTRACTOR IS RESPONSIBLE FOR ALL DAMAGE DUE TO OPERATIONS INSIDE AND OUTSIDE THE CONTRACT LIMIT OF WORK LINE.

EENCING:
1. CONSTRUCTION FENCE SHALL BE A TEMPORARY, MOVABLE CHAIN LINK FENCE WITH GREEN WIND SCREEN.

PROPOSED ABBREVIATION AND LEGEND

X-20.00

SS

TC

TW

TYP

VGC

WCR

SQCS

PROPOSED ELECTRIC CONDUIT
PROPOSED RECONNECTED WATER SERVICE
EXISTING STRUCTURE TO BE ABANDONED
EXISTING UTILITY TO BE ABANDONED
EXISTING GRADE
CUT AND CAP

X-20.00-BC PROPOSED GRADE - BOTTOM OF CURB

X-20.00-TC PROPOSED GRADE - TOP OF CURB

NEW BITUMINOUS CONCRETE PAVEMENT

NEW CEMENT CONCRETE PAVEMENT

TEXT IN BOX IS PROPOSED WORK

BC BOTTOM OF CURB BIT RITUMINOUS BOTTOM OF RAME BW BOTTOM OF WALL CAST IRON CLF CHAIN LINK FENCE CTE CONNECT TO EXISTING CTN CONNECT TO NEW DUCTILE IRON DICL DUCTILE IRON CEMENT LINED DMH DRAIN MANHOLE DW DOMESTIC WATER EXISTING FOUNDATION DRAIN FIRE WATER SERVICE GROUND FAULT INTERRUPTER LINEAR FEET MONITOR WELL PROPOSED ROOF DRAIN REMOVE AND DISPOSE R&R REMOVE AND RESET STORM DRAIN SGR STEEL GUARD RAIL

SANITARY MANHOLE

VERTICAL GRANITE CURB

WHEELCHAIR RAMP

STORMWATER QUALITY CONTROL STRUCTURE

SANITARY SEWER

TOP OF CURB

TOP OF WALL

TYPICAL

NOTE: SEE SHEET C-2 FOR EXISTING CONDITIONS PLAN

INDEX OF DRAWINGS

SHEET NO.	DESCRIPTION		
C-1	GENERAL NOTES, LEGEND AND CIVIL LEGEND		
C-2	EXISTING CONDITIONS PLAN (PREPARED BY OTHERS)		
C-3	CIVIL SITE PLAN		
C-4	CIVIL DETAILS		
C-5	SITE PHOTOGRAPHS		
C-6	RECORD VAULT STRUCTURAL DRAWINGS		
E1	SITE POWER PLAN		
E2	VAULT DETAILS		
E3	ELECTRICAL SPECIFICATIONS		

BLC

ASSOCIATE SIE SO

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"ILLE:
CONT. LEGEND
CONT. LEGEND
TITLE:
REPLACEMENT OF THE BREWER
EXISTING UTILITY VAULT

P

FZ S

FRIENDS (GARDEN 69 BEACON S BOSTON, MA

SHEET TILE:

GENE

CIVIL

PROJECT TILE:

REPI

DRAWN BY: ERN
DESIGNED BY: ERN
DHECKED BY: JRC
RECORD DWGS: XXX

DATE: 01/17/2019


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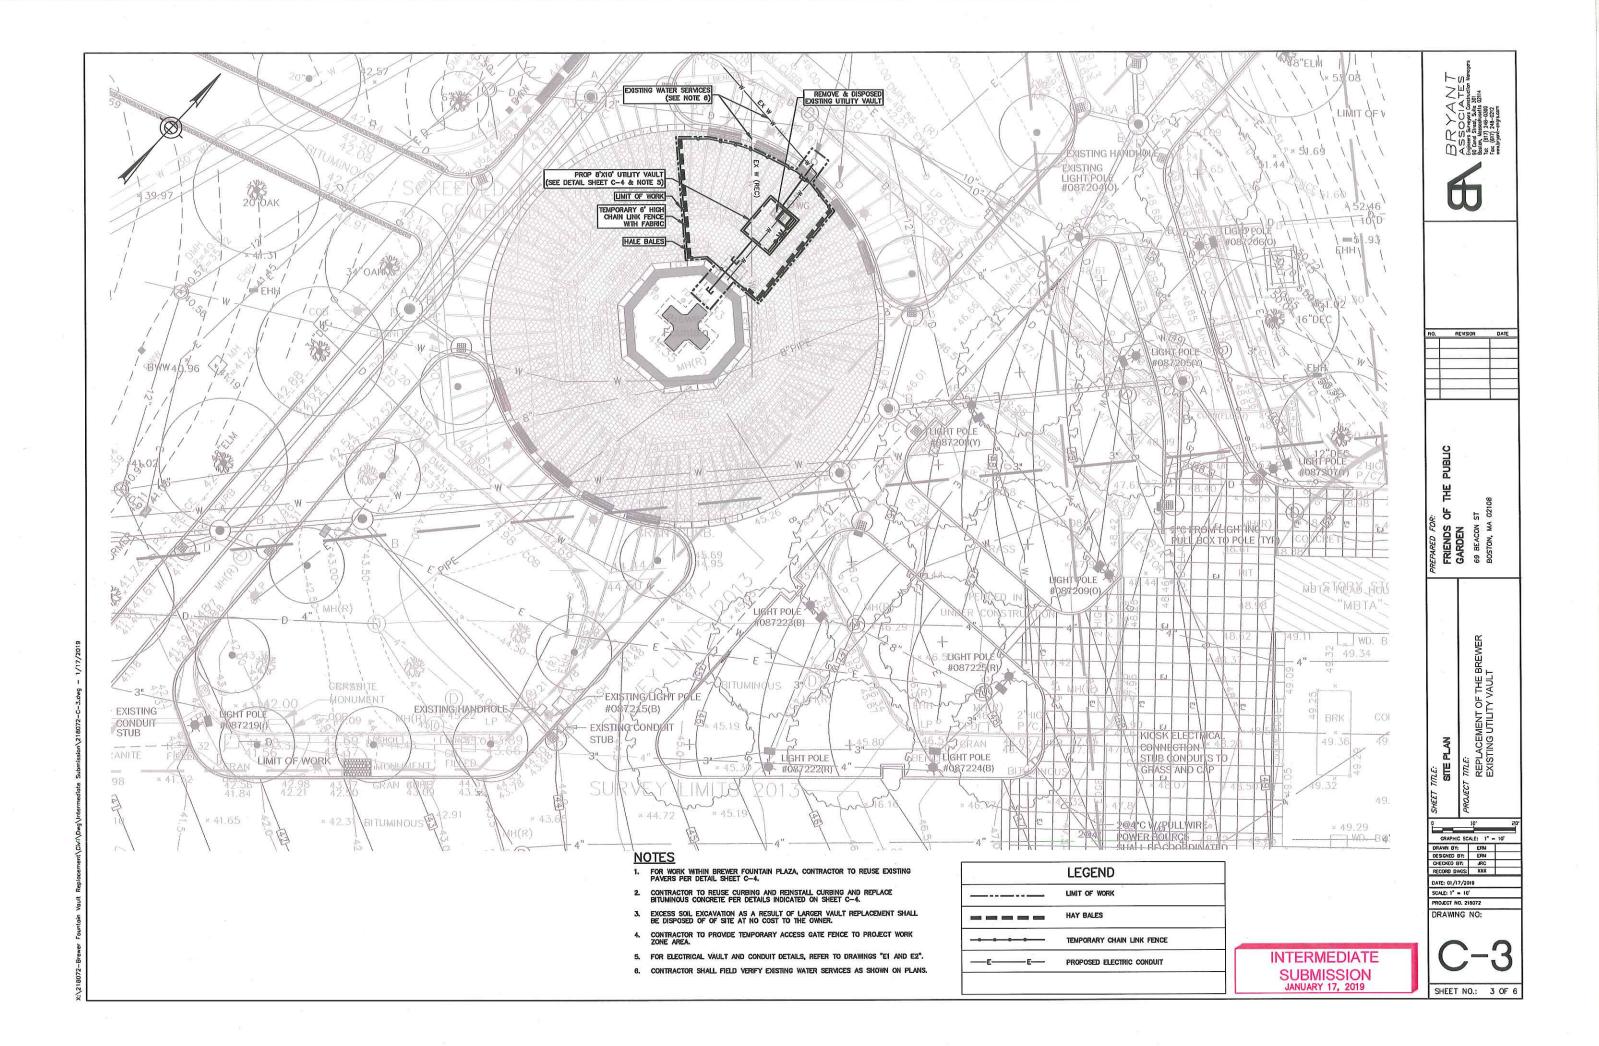
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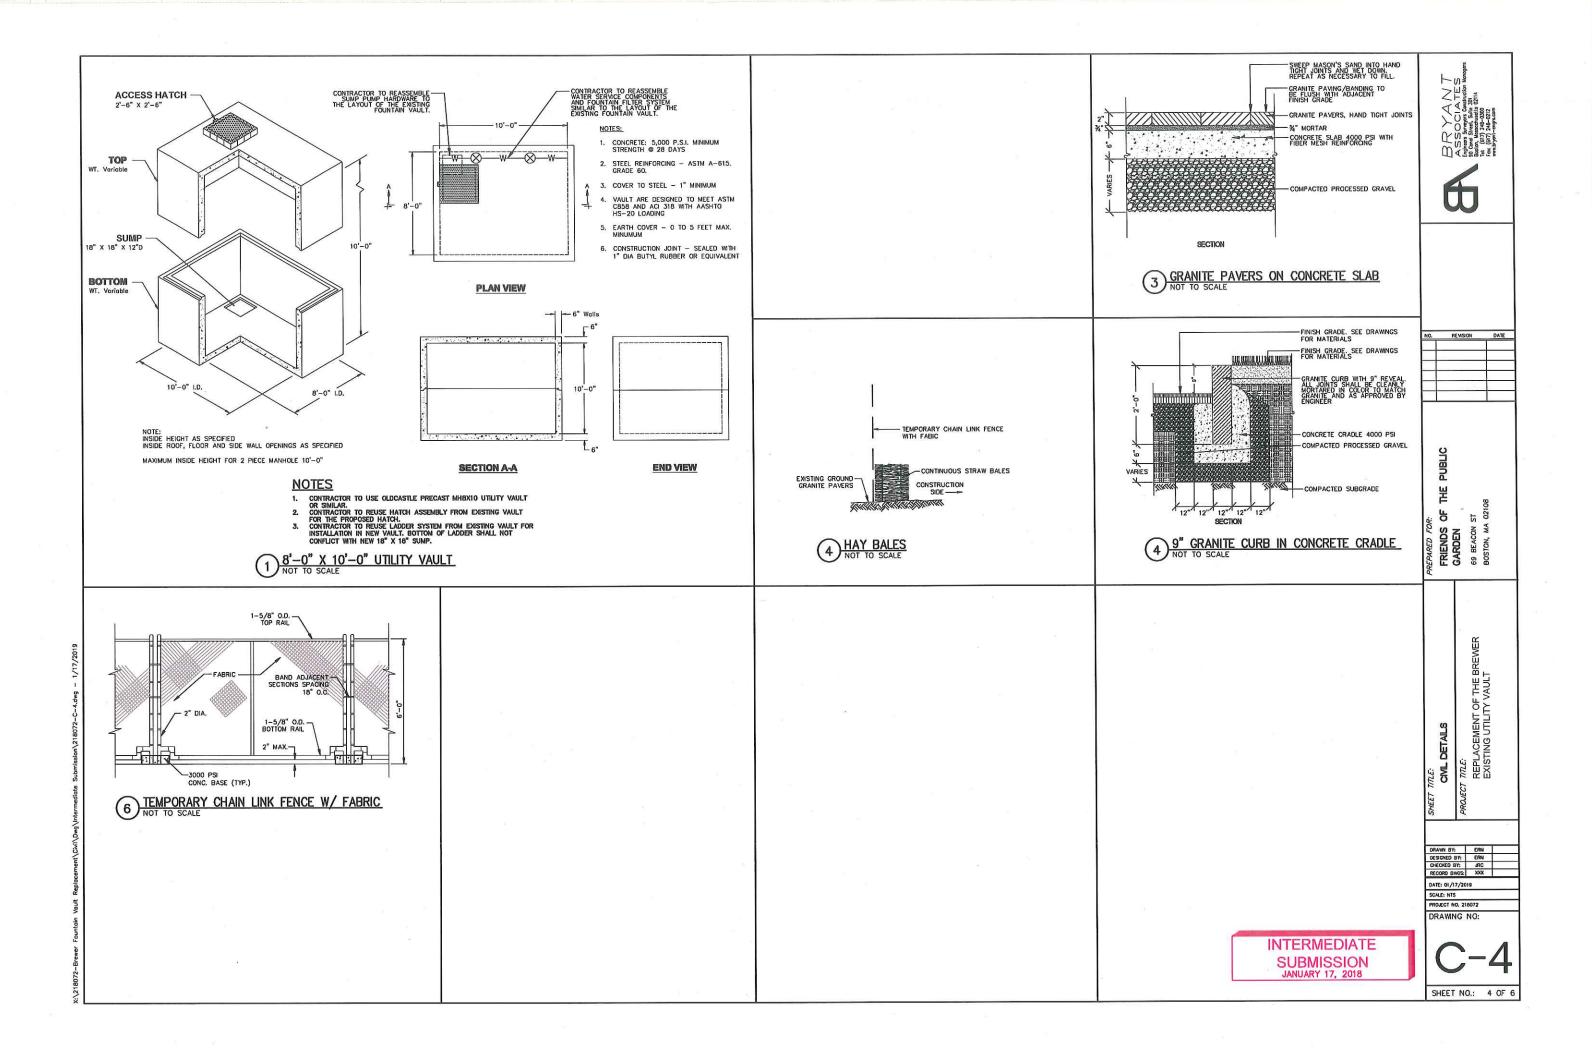
C-1

ewer Fountain Vault Replacement\Crvil\Dwg\Intermediate Submission\218072—C-1.dwg - 1/17/2

INTERMEDIATE SUBMISSION JANUARY 17, 2019





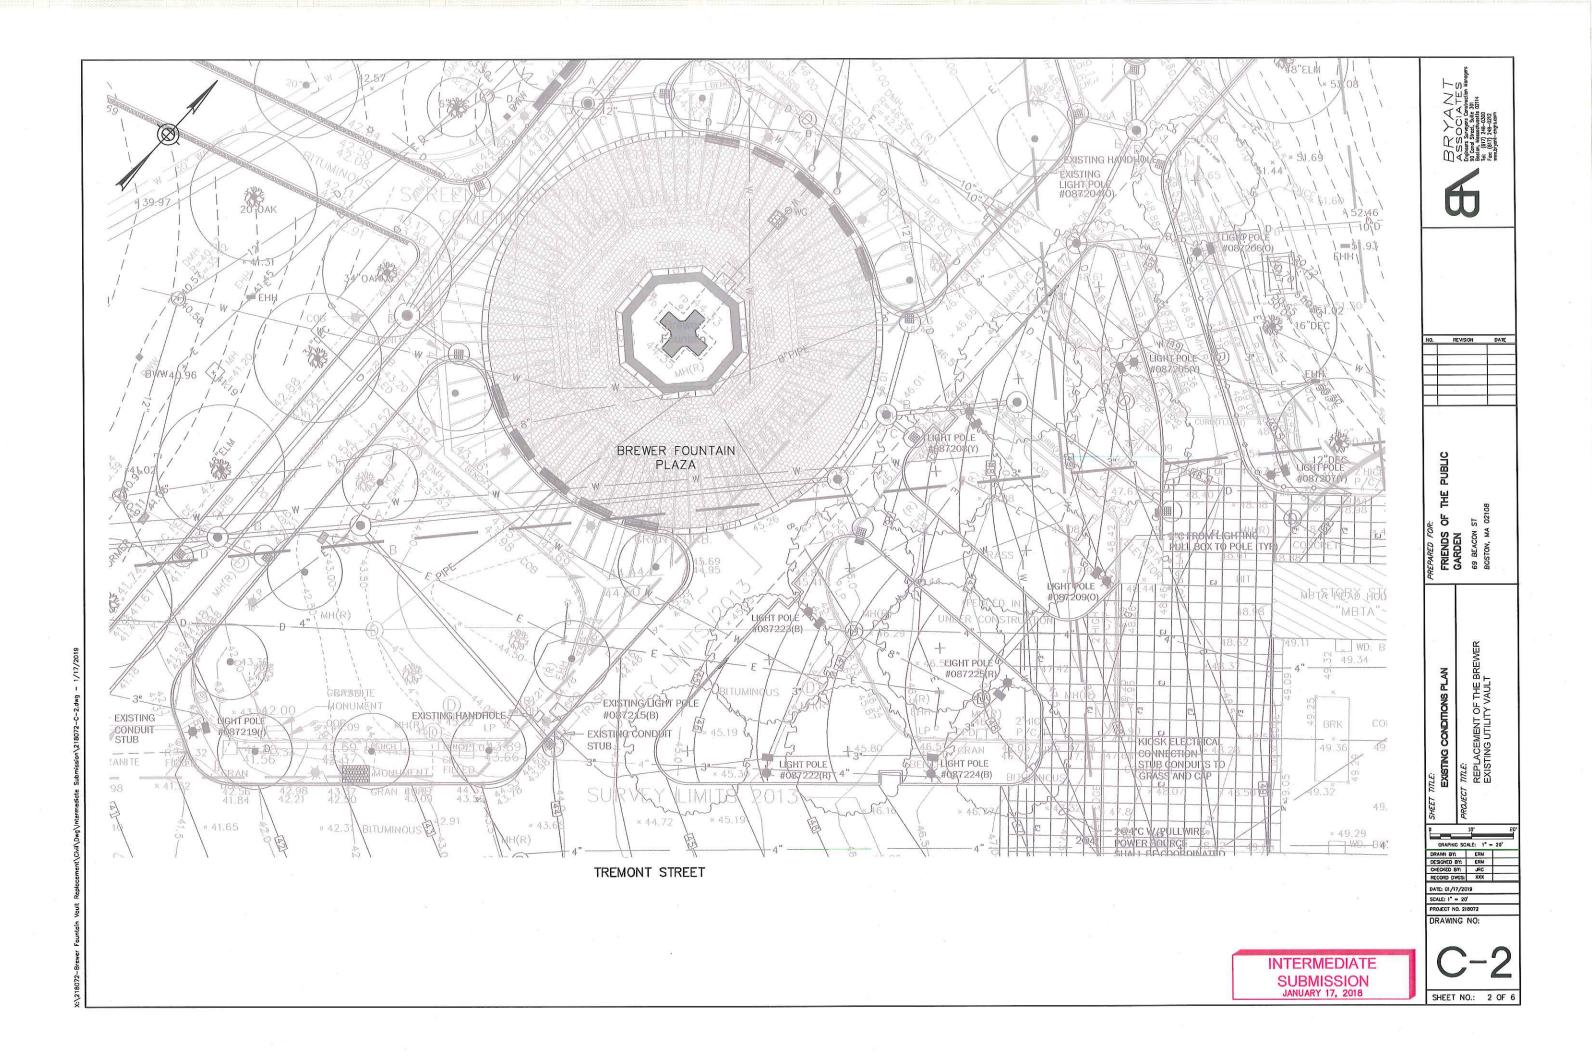







6

NO, REVISION D.

SITE PHOTOCRAPHS
SITE PHOTOCRAPHS
STRIENDS OF 1
GARDEN
THE BREWER
EXISTING UTILITY VAULT
BOSTON, MA 02108







INTERMEDIATE SUBMISSION JANUARY 17, 2019 DRAWING NO:

C-5

SHEET NO.: 5 OF 6

DATE: 01/17/2019

SCALE: NTS

PROJECT NO. 218072

ALL WORK SHALL CONFORM TO 78D OWR - THE MASSACHUSETTS STATE BUILDING CODE-EIGHTH EDITION, THE 2009 INTERNATIONAL BUILDING CODE AND ASCE 7-05.

THE CONTRACTOR SHALL VEHEY ALL DIMENSIONS AND CONDITION THE FIELD FIRST TO COMMENCING MORE. WHERE DIMENSIONS A ELEVATIONS OF ENGINE CONSTRUCTION COULD AFFECT THE AREA ELEVATIONS OF THE CONTRACTOR S RESPONSIBILITY TO OBTAIN FIELD WESTERMENTS AS REQUIRED.

J. ALL CONTROLOGY ARE REQUESTED TO DEALINE THE DRIVENEDS AND SEPECHARIONS CAREFULLY, WITH THE STREAM FALLY MIFORM SEPECHARIONS CAREFULLY, WITH THE STREAM FALLY MIFORM THE MEMBERLYSE AS TO ALL EXISTING CONTROLOGY AND UNITABILITY PROPERTY OF A PROPERTY OF PROPERTY OF A PROPERTY OF A PROPERTY OF THE STREAM FALLINGS THE MEMBERS THE MEMBERS WITH THE COSTINGATION FROM MICHIGAN WITH THE ORGANIZATION AND SECONDARY OF THE MEMBERS OF PROPERTY OF THE MEMBERS OF T

ONCRETE

I. ALL CONCRETE WORK SHALL CONDRING TO THE LAKEST EDITION OF THE ADD BUILDING CODE REQUIREMENTS FOR REINFORCESS CONCRETE (ACI STRR-05) AND THE RIC 2009 CHAPTER 18 "FOUNDATIONS" AND CHAPTER 19 "CONCRETE".

2. THE CONCRETE FOR THE VALUE DECASEMENT SMALL BE NORMAL MEDIAH CONCRETE, THE WE PORTLAND DESIMENHABLE SERVEY STEWERS, WHILL A 2D MAY OF THE STATE STATE OF THE STATE STATE OF THE STATE S

3. THE CONCRETE SHALL BE MIXED, FLACED, AND CURED WITHOUT THE USES OF CALCIUM CHORONIC: HIS CONCRETE PLACEMENT SHALL COMPLY WITH THE AMERICAN CONCRETE CODES (AGO) INCLUDING AGO-300K-96 (REAPPROVED 2002) "COLD WASHING CONCRETING" AND ACI 300K-99 "FOR WASHING CONCRETING" AND ACI 30K-99 "FOR WASHING CONCRETING".

BACKFILL

1. THE EXCAVATION OUTSIDE THE ENCASEMENT SHALL BE BACKFILLED
WITH MATERIAL THAT IS FREE OF ORGANIC MATERIAL, CONSTRUCTION
DEBRIS AND LARGE ROCKS.

2. ALL SINULINAL FALL DE BANGRIN GAMEL, CRISHED BANGRIN GAMEL, CRISHED BANGRIN GAMEL OR GOUSTE STONE. THE MANNAM STINCE DET. IN CAMEL DE 2'N MOMENTE. THE CAMELS DEST. BE A MASIED STONE BAT CONFEDUS TO ASIM C-33 "CONCERNE AGREGARE". THE STRUCTURE LE SHALL EN FALCE ON MOMENTA 12" LIFTS MIO COMPACTED TO BAST OF ASIM TSSY, METROD D.

3. BACKFILL PURCENT TO THE CONCRETE ENCASEMENT SHALL NOT BE PLACED UNTIL THE CONCRETE HAS SUFFICIENT STRENGTH.

ALL REINFORCING STEEL SHALL BE EPOXY COATED AND SHALL CONFORM TO ASTM A775/A775M, GRADE 60.

MINIMUM COVER FOR ALL REINFORCING STEEL SHALL DE AS FOLLOWS:

A 3" WHERE CONCRETE IS DEPOSITED DIRECTLY ADAMST THE SOR, WITHOUT THE USE OF A FORM B. 2" WHERE CONCRETE IS EXPOSED TO THE WEATHER. C. 2" FOR WALLS AND SLABS.

PRIOR TO CONCRETE PLACEMENT, INSPECT ALL AREAS TO ENSURE THEY ARE PREPARED.

A ALL CORPIETE SMALL BE PLACED ON THE EXISTING CONCRETE ACCIONS SLAS BELOW THE EXISTING VALID.

FORWARDS IS OF THE CORPICT SIZE AND PROPERLY FORWARDS IS OF THE CORPICT SIZE AND PROPERLY SMACED, SECURE, AND WALL HAVE PROPER CORP.

OURLAIFED WORK PRESONNEL AND FOUR-WEST (LESTING COMPAND), ITEST CHARDORS, CONSIDURATION AND FRISHING TOUSE, ELC.) SMALL BE ON SIZE AND ANALYSES. OF THE STITM AND THE SMALL BE ON SIZE AND ANALYSES. OF THE STITM AND THE SMALL BE ON SIZE AND ANALYSES. OF THE STITM AND THE SMALL BE ON SIZE AND ANALYSES. OF THE STITM AND THE SMALL BE.

FORMWORK AND FORMWORK ADDESSORIES

MATERIALS FOR FORM FACES IN CONTACT WITH CONCRETE SHALL MEET THE REQUIREMENTS OF ACT-318R-05 FOR UNSPECIFIED FINISHES AND SHALL BE AS FOLLOWS:

FOR BRICH FOW PINSH NO EPPOSED TO PUBLIC VEW, NO FORM ZACHE WITH PINSH NOT EPPOSED TO PUBLIC VEW, NO FOW ZACHE FOR SHAPE PER PINSON. TENNENDED CONCRETE FORM-GRADE LANGELINER, METAL, PASTIC, POPER, NO OTHER ACCEPTAGE MATTERNS METAL, PASTIC, POPER, NO OTHER ACCEPTAGE MATTERNS, PASTIC, POPER, NO OTHER ACCEPTAGE ON POPULA PARTICIPATION, P

USE COMMERCIALLY MANUFACTURED ACCESSORIES FOR DRIMBORK ACCESSORIES THAT ARE WHOLLY OR PARTALLY EMBEDDED IN THE CONCERT, INCLUMENT IES AND HANGERS. DO NOT USE JON-FABRICATED WIRE FORM TIES.

PLACING CONCRETE

1. CONCRETE. WHEN PLACED, SHALL HAVE A TEMPERATURE RANGING BETWEEN A MIRANUM OF 55F AND MAXIMUM OF BOT.

2. THE CONCRETE SHALL BE MORED BY SOCIAL QUARTIES AS SISH BEAUTHER FOR IMMEDIATE USE AND SHALL BE FLACED WHILE FIRST BEAUTHER OF SLAMP SOCIAL DESIGNATION OF FIRST BEAUTHER SHALL BE SH

4. THE CONCRETE SHALL SE MIXED, FLACED AND CURED WITHOUT THE USE OF CACCIAN CHURSHE. THE PLACEWRIE OF ALL CONCRETE NATIONAL COMES, NECLUCIANG ACI JORN-88 (REAPPROVED 2002) "COLD WEATHER CONCRETAS" AND ACI JOSS-99 "HOT WEATHER CONCRETAS".

PROTECTION OF NEW WORK-

ALL FRESHLY PLACED CONCRETE SHALL BE ADEQUATELY PROTECTED FROM PREMATURE DRIVING, EXCESSIVELY HIST OR COLD TEMPERATURES AND MECHANICAL RELIEV LINTEL SUCH TIME THAT THE CONCRETE HAS PROPERLY CURED.

PROJECT CONCRETE BURBINS THE CURRING PERSOD SUCH THAT THE CONCRETE TEMPERATURE DOES NOT USOD PELOW 595" OR EXCEED SYFT. MAMINIAN THE CONCRETE EMPERATURE TO THE PREVENT SYFT. MAMINIAN OF CONCRETE EMPERATURE TO THE PREVENT SYFT. MAMINIAN OF THE CONCRETE AND TO EXPERT THE NECESSARY PERSON OF THE CONCRETE AND TO EXPENDITURES. SERVEY.

J. MEASURE CONCRETE TEMPERATURE USING A METHOD ACCEPTABLE TO THE STRUCTURAL ENGINEER. WHEN THE SURFACE TEMPERATURE OF THE CONNECTE IS WITHIN 20°F OF THE AMBRICA OF SURFACIONATION TEMPERATURE AND HAS PROPERLY CURED, PROTECTION MEASURES MAY BE REMOVED. CURING

1. CURNO SHALL BE STATED INMEDIATELY UPON COMPLETION OF THE FRESHING OFFERIOR. CONCRETE SHALL BE MANUFACTOR OF SOST FOR A MANUFACTOR OF SEPEN (2) DAYS UPLESS A CONCRET PERSON OF SHEARMATER SECURED. BAPO BERNO UPON COMPLETION OF SHEARMATER SECURED. BAPO BERNO UPON COMPLETION OF SHEARMATER SECURED. A HID THE OPENIOR UPON CONTROL OF THE CONCRETE BE PERMITTED TO DROP BELOW MOT.


PONDING, CONTINUOUS FOOGRING OR CONTINUOUS SPRINKLING.
 APPLICATION OF MAIS OR FABRIC SUCH AS BURLAP KEPT
 CONTINUOUSLY WET.

COMMUNIOUS APPLICATION OF STEAM (UNDER 150°F)


D. APPLICATION OF SHEET MATERIALS CONFORMING TO ASTM. C171. THE CONCRETE SHALL HAVE ATTAINED AT LEAST FIFTY PERCENT (SUR) OF HIS 28 DAY COMPRESENCE STRENGTH PROB_TO REMOVAL OF MY FORMS.






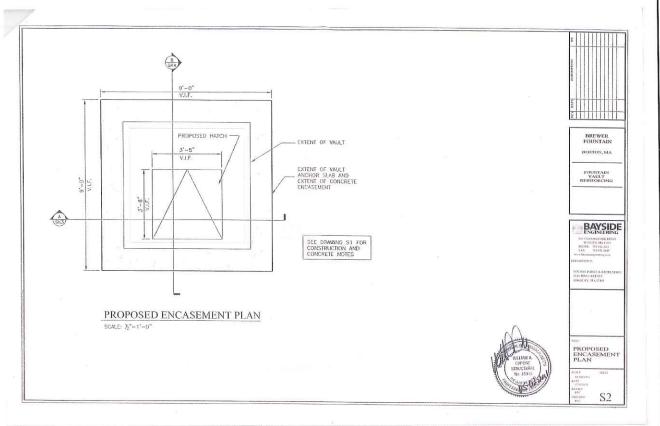

INTERMEDIATE SUBMISSION JANUARY 17, 2019

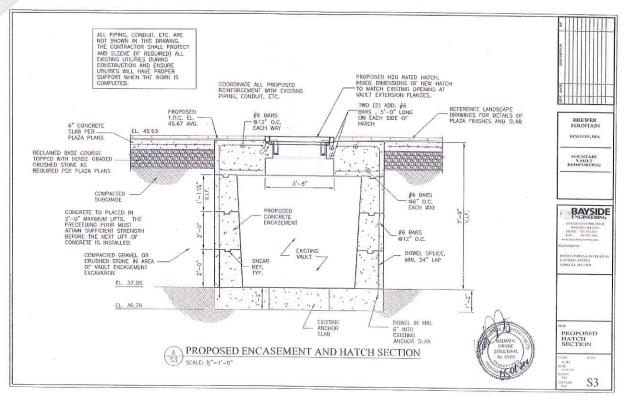


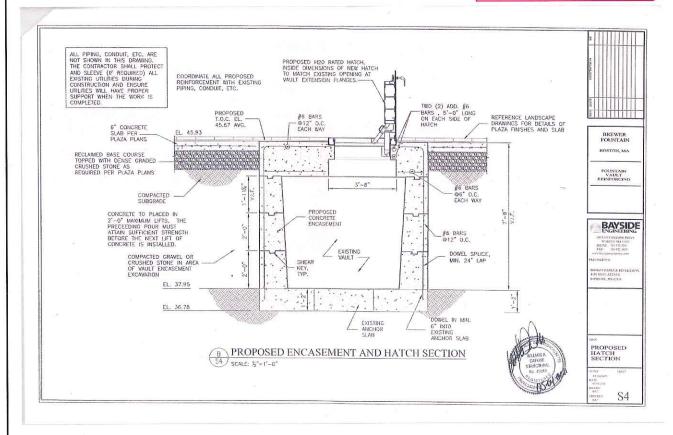

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DRAWN BY: ERM
DESIGNED BY: ERM
CHECKED BY: JRC
RECORD DWGS: XXX DATE: 01/17/2019 SCALE: NTS PROJECT NO. 218072 DRAWING NO:

SHEET NO.: 6 OF 6



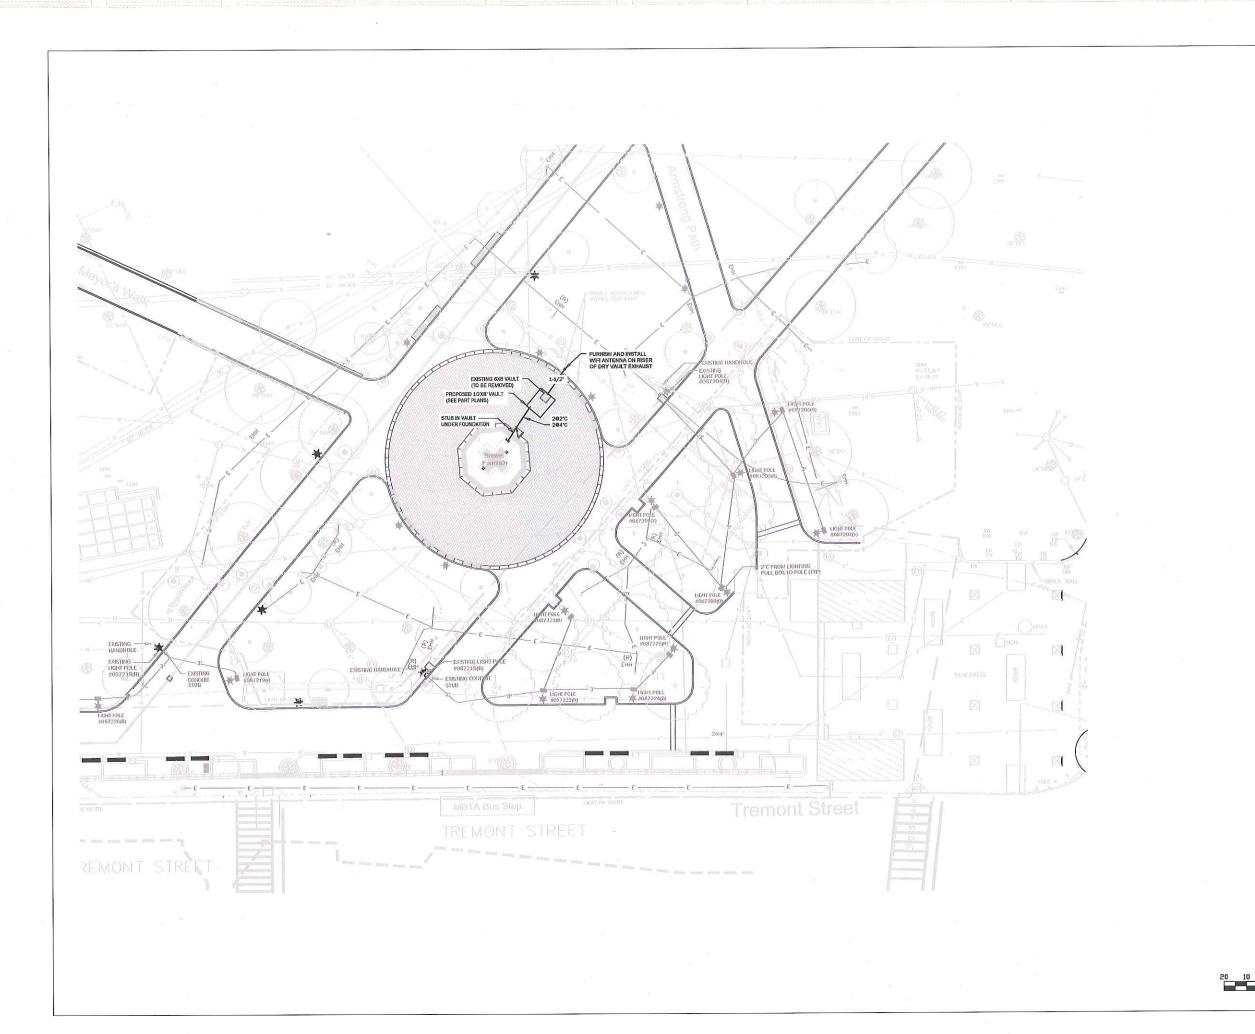

69 Beacon Street Boston, MA 02108 (617) 723-8144

BREWER FOUNTAIN VAULT REPLACEMENT

Boston, Massachusetts

Boston Common

NO.	DATE	REMARKS
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RONALD W. BUIA, INC.


Electrical Engineers
5 Tillon Lane
Andover, Ma DIB10
TEL: 978.475.5184
RBUIA@BUIAENGINEERING.COM


Site Power Plan

SEAL	NORTH	
	1	

1/18/19 1"=20"

CHECKED BY: PROJECT NO.: 270118 E1

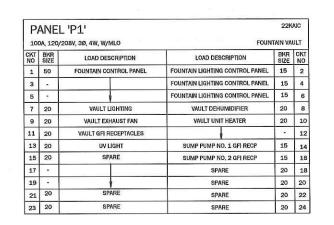


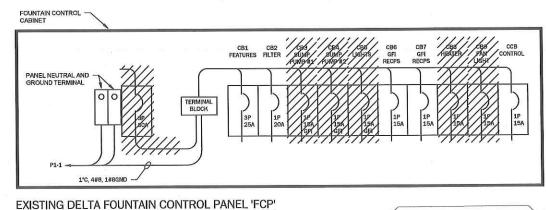



RECONNECT CIRCUIT BREAKERS NO'S CB1, CB2, CB6, CB7, CCB TO EXISTING LOADS.

CIRCUIT BREAKERS SHOWS HATCHED SHALL BE MADE SPARE AND THEIR RESPECTIVE


DELTA FOUNTAINS - JACKSONVILLE, FL - TEL: (904)886-9030

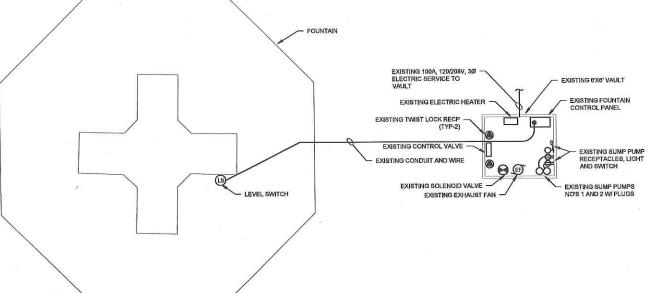


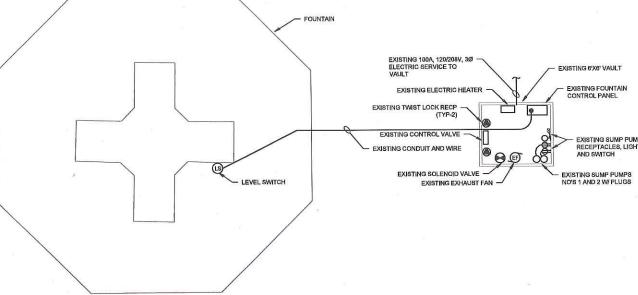

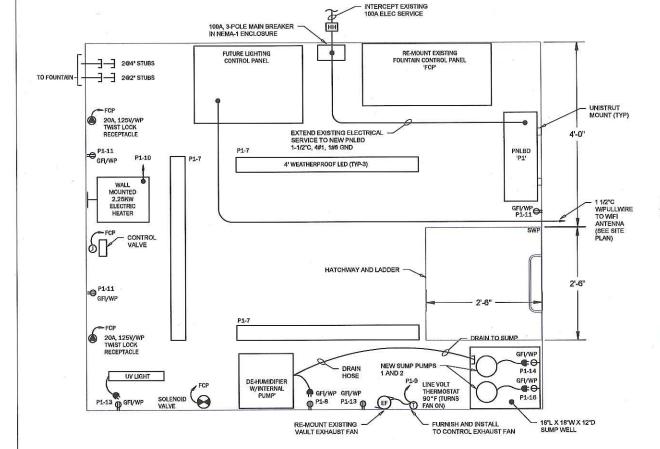

VAULT POWER PLAN

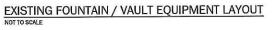

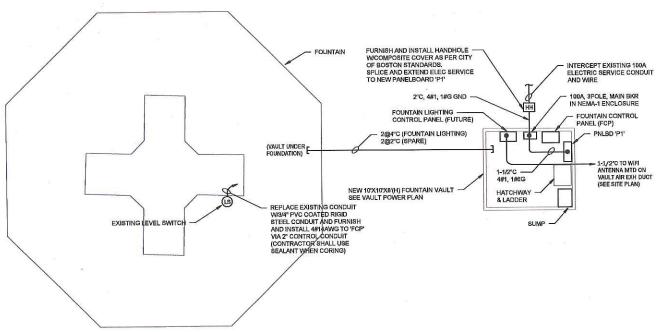

PROPOSED FOUNTAIN / VAULT PANEL AND CONDUIT LAYOUT

FRIENDS PUBLIC GARDEN

69 Beacon Street Boston, MA 02108 (617) 723-8144

BREWER FOUNTAIN VAULT REPLACEMENT


Boston, Massachusetts

Boston Common

REVISIONS NO. DATE REMARKS

RONALD W. BUIA, INC. Electrical Engineers 5 Tilton Lane Andover, MA 01810
TEL: 978.475.5184
RBUIA@BUIAENGINEERING.COM

Vault Details

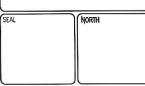

CHECKED BY: 1/18/19 DATE: SCALE: AS NOTED PROJECT NO.: 270118

DRAWING NO.

ELECTRICAL SPECIFICATIONS

- FURNISH AND INSTALL ALL LABOR, MATERIALS, APPLIANCES, EQUIPMENT TOOLS, TRANSPORTATION, SUPERVISION AND SERVICES REQUIRED TO ELECTRICAL WORK IN ACCORDANCE WITH THE DRAWINGS AND SPECIFICATIONS.
- THE ELECTRICAL WORK SHALL INCLUDE, BUT NOT BE LIMITED TO THE FURNISHING OF MATERIALS AND INSTALLATION OF THE FOLLOWING IN ACCORDANCE WITH ALL APPLICABLE STATE AND LOCAL CODES.
- HANDHOLES
- 2. WIRING DEVICES
- 3. LIGHTING SYSTEMS
- 4. CONDUIT, WIREWAYS, RACEWAYS, ETC.
- 5. BRANCH CIRCUIT WIRING
- 6. PANELBOARD
- 7. POWER WIRING
- 8. GROUNDING SYSTEM
- 9. WIRE AND CABLE
- 10. ELECTRIC UNIT HEATER
- 11. DE-HUMIDIFIER
- 12, MAIN CIRCUIT BREAKER
- 13. DEMOLITION OF EXISTING EQUIPMENT
- ALL WORK SHALL BE IN ACCORDANCE WITH THE LATEST REQUIREMENTS OF THE MEC, MASSACHUSETTS STATE BUILDING CODE, OSHA, ADA, ALL LOCAL CODES AND LOCAL UTILITY CO. STANDARDS & SPECIFICATIONS
- 4. CONTRACTOR SHALL PAY FOR ALL INSPECTION FEES, LICENSES AND PERMITS.
- COORDINATE ANY REQUIRED POWER INTERRUPTIONS AND PERFORM WORK AT TIME CONVENIENT TO OWNER, INCLUDE COSTS FOR REQUIRED PREMIUM TIME.
- SUBMIT SHOP DRAWINGS FOR ALL EQUIPMENT FOR APPROVAL BEFORE PURCHASING SAME, ALL EQUIPMENT SHALL BEAR THE LABEL OF A NATIONALLY-RECOGNIZED TESTING LABORATORY.
- 7. PANELBOARD
 - FURNISH AND INSTALL THE PANELBOARD FOR LIGHTING AND POWER AS INDICATED AND AS SCHEDULED ON THE DRAWINGS.
 - B, PANELBOARD SHALL BE OF DEAD FRONT CONSTRUCTION WITH THERMAL MAGNETIC CIRCUIT BREAKERS AND SHALL CONFORM TO TH REQUIREMENTS OF NEMA AND MEC, PANELBOARD SHALL BE UL APPROVED AND LABELED.
 - C. PANELBOARD SHALL CONSIST OF CIRCUIT BREAKERS, CODE GAUGE STEEL CABINET OR BACKBOARD, BUS ASSEMBLY, TRIM WITH CODE GAUGE GALVANIZED STEEL DOORS, GUTTER SPACE SHALL BE A MINIMUM OF 4" ON ALL SIDES,
 - D. CIRCUIT BREAKERS OF OF THE QUICK-MAKE, QUICK BREAKTRIP FREE THERMAL MAGNETIC TYPE WITH CHARACTERISTICS AS SCHEDULED, AUTOMATIC TRIPPING SHALL BE CLEARLY INDICATED BY THE OPERATING HANDLE ASSUMING A MID-POSITION BETWEEN ON AND OFF, TWO AND THREE POLE BREAKERS SHALL HAVE COMMON TRIP, ALL CIRCUIT BREAKERS SHALL BE BOLT-ON TYPE.
 - E. PANELBOARD SHALL BE PROVIDED WITH SOLID NEUTRALS, IN ADDITION, GROUNDING BUS WITH LUGS SHALL BE PROVIDED ON ALL PANELBOARDS MEETING UL AND NEMA STANDARDS, ALL BUSSWORK SHALL BE COPPER.
 - F. TWO MILLED TYPE KEYS SHALL BE PROVIDED WITH PANEL AND ALL PANEL LOCKS SHALL BE KEYED ALIKE.
 - G. BUS ARRANGEMENTS SHALL BE SEQUENCE PHASED SUCH THAT ADJACENT SINGLE POLE BREAKERS SHALL BE CONNECTED TO OPPOSITE PHASES IN SUCH A MANNER, SUCH THAT ANY TWO OR THREE POLE BREAKERS COULD BE INSTALLED ANYWHERE IN THE PANELBOARD.
- B, LIGHTING
- A. FURNISH AND INSTALL LIGHTING FIXTURES AS INDICATED ON THE DRAWINGS, THE LIGHTING FIXTURES SHALL BE SUPPORTED FROM THE VAULT STRUCTURE.
- 9. MECHANICAL SUSPENSION CHANNEL
 - A. MECHANICAL SUSPENSION CHANNEL SHALL BE FURNISHED AND INSTALLED TO SUPPORT ELECTRICAL EQUIPMENT (PANELBOARDS

DISCONNECT SWITCHES, STARTERS, ETC.).

- B. CHANNEL SHALL BE DESIGNED BY UNISTRUT TYPE P3000. ALL FASTENERS AND FITTINGS SHALL BE SUPPLIED TO PROVIDE A COMPLETE INSTALLATION AS REQUIRED.
- C. ALL CHANNEL AND FITTINGS SHALL BE FURNISHED WITH THE MANUFACTURERS STANDARD RUSTPROOF FINISH.
- 10. GROUNDING
 - A. PROVIDE GROUNDING FOR ALL ELECTRICAL EQUIPMENT AND DEVICES IN ACCORDANCE WITH THE OWNERS STANDARDS AND THE APPLICABLE REQUIREMENTS OF THE MASSACHUSETTS ELECTRICAL CODE AND AS INDICATED ON THE DRAWINGS.
 - B. BONDING JUMPERS SHALL BE INSTALLED AT ALL LOCATIONS REQUIRED
 - C. A GREEN GROUNDING CONDUCTOR OF PROPER SIZE SHALL BE INSTALLED AND CONNECTED WITH THE FEEDER CIRCUIT CONDUCTORS TO ALL PANLEDGARDS, MOTOR FRAMES, ETC, CONNECTIONS TO THE EQUIPMENT MAY BE BOLTED OR SCREWED USING CORROSION RESISTING BOLTS, SCREWS, A GREEN GROUNDING CONDUCTOR SHALL BE INSTALLED IN ALL BRANCH AND FEEDER CIRCUITS.
 - D. ALL EXPOSED CONNECTIONS SHALL BE MADE BY GROUNDED
 GROUNDING CLAMPS
- 11. ELECTRIC HEATER
 - A. REZNOR EGW ELECTRIC FORCED AIR HEATER, 2,5KW, 208V, 1Ø W/MONITORING BRACKET AND BUILD IN THERMOSTAT OR EQUAL.
- 12. DE-HUMIDIFIER
 - A. 76 PINT DE-HUMIDIFIER WITH INTERNAL PUMP AND 20' DRAIN HOSE,
- s. RACEWAYS
 - A. ALL VAULT WIRING SHOWN RUN IN CONDUIT ON THE DRAWINGS SHALL BE INSTALLED IN SCHEDULE 40 PVC CONDUIT.
 - B. ALL EXPOSED EXTERIOR CONDUIT RUNS OUTSIDE THE VAULT SHALL BE
 - C, UNDERGROUND CONDUIT SHALL BE SCHEDULE-40 PVC.
 - D. LIQUID-TITE FLEXIBLE METAL CONDUIT SHALL BE USED FOR CONNECTION TO MOTORIZED EQUIPMENT, WITH AN INTERWOVEN GROUND CONDUCTOR (1 1/4" MAXIMUM DIAMETER).
 - SET SCREW-TYPE CONNECTORS AND COUPLINGS FOR METAL CONDUIT WILL NOT BE ALLOWED.
- 14, HANGERS & SUPPORTS
 - A. PROVIDE ALL REQUIRED HANGERS, SUPPORTS, SLEEVES, CLAMPS, ETC., AS REQUIRED AND AS INDICATED ON THE DRAWNGS.
- 15, OUTLET BOXES
 - A. BOXES SHALL BE FS OR FD SERIES, WITH CADMIUM PLATED COVERS, STEEL BOXES WILL NOT BE PERMITTED.
- 18, PULL & JUNCTION BOXES
 - A. PULL BOXES SHALL BE CONSTRUCTED OF CODE GAUGE GALVANIZED STEEL AND SHALL BE INSTALLED AT POINTS WHETHER INDICATED ON THE DRAWINGS OR NOT, MINIMUM DIMENSION SHALL NOT BE LESS THAN MEC REQUIREMENTS,
- 17. FEEDER & BRANCH CIRCUIT CONDUCTORS
 - A. ALL FEEDER, BRANCH CIRCUIT, REMOTE CONTROL, SIGNAL CIRCUIT AND INTERLOCK WIRING SHALL BE MANUFACTURED OF COPPER AND RATED 600 VOLTS.
 - B. MINIMUM. SIZE WIRE FOR BRANCH CIRCUIT AND POWER WIRING SHALL. BE #12 AWG.
 - C, INSULATION TYPE SHALL BE XHHW FOR FEEDERS AND POWER WIRING: THHN/THWN FOR LIGHTING, REMOTE CONTROL, AND SIGNAL CIRCUITS.
 - D. INSULATION TYPE SHALL BE XHHW FOR FEEDERS AND POWER WIRING: THIN/THWN FOR LIGHTING, REMOTE CONTROL, AND SIGNAL CIRCUITS.

 - E, ALL WIRING SHALL CONFORM TO THE MASSACHUSETTS ELECTRICAL CODE FOR CONSTRUCTION AND USE.
- 18. WIRING DEVICES
 - A. FURNISH AND INSTALL WIRING DEVICES, AND SPECIFICATION GRADE, COMPLETE WITH ALL ACCESSORIES AS INDICATED ON THE DRAWNINGS AND AS SPECIFIED HEREUNDER. ALL WIRING DEVICES SHALL BE THE PRODUCT OF A SINGLE MANUFACTURER EXCEPT WHERE SPECIFICALLY

STATED OTHERWISE.

- B. DUPLEX RECEPTACLES SHALL BE NYLON SPECIFICATION GRADE, U-GROUND, RATED FOR 125VAC, 20A-MANUFACTURED BY BRYANT CAT. NO. 5892-I OR EQUAL.
- C. SWITCHES SHALL BE NYLON SPECIFICATION GRADE, AC TYPE, RATED 20 AMPS FOR 120/277 VOLTS, BRYANT CAT. NUMBERS 4901-I, 4903-I, 4904-I
- D. DUPLEX RECEPTACLES WITH GROUND FAULT INTERRUPTER CHARACTERISTICS SHALL BE INSTALLED WHERE SPECIFIED ON THE DRAWINGS, ALL WET AREAS SHALL BE GROUND FAULT TYPE WHETHER INDICATED ON THE DRAWINGS OR NOT, GROUND FAULT RECEPTACLES SHALL BE NYLON MANUFACTURED BY BRYANT CAT, NO, 5362-IGI OR FOLIAL.
- E, TWIST LOCK RECEPTACLES SHALL BE AS INDICATED ON THE DRAWINGS.
- 19. FURNISH AND INSTALL NAMEPLATES ON ALL ELECTRICAL EQUIPMENT (SCREW
- 20. ALL EQUIPMENT EXPOSED TO MOISTURE SHALL BE OF THE APPROPRIATE (NEMS) WEATHERPROOF TYPE. SEAL ALL CONDUITS THAT PENETRATE EXTERIOR WALLS,
- PERFORM ALL TESTS REQUIRED AND VERIFY CORRECT ROTATION OF ALL MOTORIZED EQUIPMENT, PHASE BALANCE ALL PANELBOARDS IN THE FIELD.
 - A COMPLETE TEST AND INSPECTION RECORDS SHALL BE MADE AND TESTED, ALL READINGS TAKEN SHALL BE RECORDED. TEST REPORTS SHALL BE SUBMITTED TO THE OWNERS APPROVAL.
 - B. FURNISH NECESSARY METERS, INSTRUMENTS, TEMPORARY WIRING AND LABOR TO PERFORM ALL REQUIRED TESTS AND ADJUSTMENTS OF EQUIPMENT AND WIRING INSTALLED AND/OR CONNECTED UNDER THIS CONTRACT, INCLUDING ELECTRICAL EQUIPMENT FURNISHED BY OTHERS, TO DETERMINE PROPER POLARITY, PHASING, FREEDOM FROM GROUND AND SHORTS AND OPERATION OF EQUIPMENT, ALL MEASURING INSTRUMENTS SHALL BE PROPERLY CAUBRATED.
 - C, ALL MATERIALS AND MANNER OF INSTALLATION SHALL BE IN STRICT ACCORDANCE WITH THE APPLICABLE REQUIREMENTS OF STATE AND LOCAL AUTHORITIES, THE UTILITY COMPANY AND THE CODES OF NATIONAL BOARD OF FIRE UNDERWRITERS.
 - D. WHENEVER ANY OF THE AFOREMENTIONED CODES, LAWS, ETC., REQUIRE THAT ANY WORK BE TESTED OR APPROVED, THE CONTRACTOR SHALL PROVIDE PROPER FACILITIES FOR ACCESS AND FOR INSPECTION, ALL AT HIS OWN EXPENSE.
 - E. WIRING
 - THE CONTRACTOR SHALL CORRECT OR REPLACE ANY NOMINAL CURRENT-CARRYING CIRCUIT WHICH IS DEFECTIVE OR GROUNDED AND HE SHALL ALSO CORRECT ALL OTHER TROUBLES ENCOUNTERED BY THESE TESTS. ALL DEFECTS WHETHER THOUGH FAULTY WORKMANSHIP OR MATERIAL FURNISHED SHALL BE CORRECTED UNDER THIS SECTION AT THE CONTRACTOR'S FYPENSE.
- 22. ALL ELECTRICAL WORK SHALL BE GUARANTEED FOR A PERIOD OF ONE YEAR FROM DATE OF FINAL ACCEPTANCE, DEFECTS SHALL BE CORRECTED WITHOUT CHARGE, INCLUDING ALL PATCHING, PAINTING AND OTHER INCIDENTAL REPAIRS AND REPLACEMENTS, COORDINATE ALL WORK WITH OTHER TRADES, FURNISH AND INSTALL ALL POWER AND CONTROL WIRING FOR A COMPLETE INSTALL ATION.
- 23. FOR EXACT LOCATION OF MECHANICAL EQUIPMENT SEE MECHANICAL
- 24. ALL ELECTRICAL EQUIPMENT, MATERIALS, ETC. STORED ON SITE SHALL BE STORED IN SUCH A MANNER THAT IT IS SAFE FROM DAMAGE BY MOISTURE, IMPACT, ETC.
- THE CONTRACTOR SHALL PERFORM HIS WORK IN A NEAT AND ORDERLY, WORKMANLIKE MANNER, ALL REFUSE, DIRT, AND DEBRIS RESULTANT FROM HIS WORK SHALL BE REMOVED AND PROPERLY DISPOSED OF AT THE END OF THE DAY.
 - A. ALL WORK SHALL BE EXECUTED IN A WORKMANLIKE MANNER AND SHALL PRESENT A NEAT APPEARANCE WHEN COMPLETED, AND SHALL INCLUDE THE FURNISHING AND INSTALLATION OF A COMPLETE ELECTRICAL SYSTEM INCLUDING ANY DEMOLITION, PANELBOARDS, CIRCUT BREAKERS, LIGHTING FIXTURES, CONDUTS, RACEWARS, WIRING, JUNCTION BOXES, RECEPTACLES, SWITCHES, SUPPORTS, AND ALL OTHER INCESSARY APPURITEMNCES REQUIRED FOR A COMPLETE OPERATIONAL SYSTEM, INCLUDING THE HANGING AND LAMPING OF ALL FIXTURES.
- 20, THE CONTRACTOR IS REQUIRED TO COORDINATE HIS WORK WITH ALL UTILITIES INVOLVED.
- 27. THE CONTRACTOR IS RESPONSIBLE FOR FOLLOWING THE MANUFACTURER'S INSTALLATION RECOMMENDATIONS AND DIRECTIONS FOR ALL EQUIPMENT AND MATERIALS USED.

- 28. IF CONFLICTS ARISE FROM EQUIPMENT INSTALLATION, SCHEDULING, ETC., THESE SHALL BE RESOLVED AS DIRECTED BY THE OWNER TO THE ENTIRE SATISFACTION OF THE OWNER.
- 29. UPON COMPLETION OF THE WORK, THE ELECTRICAL CONTRACTOR SHALL BE REQUIRED TO DEMONSTRATE PROPER OPERATION OF ALL SYSTEMS AND EQUIPMENT IN THE PRESENCE OF THE OWNER AND THE ENGINEER PRIOR TO ACCEPTANCE BY THE OWNER, WRITTEN RESULTS FOR ALL TESTS AND OPERATIONS SHALL BE SUBMITTED TO THE OWNER OR OWNERS AGENT CANDIDED.
- 30, ALL MATERIALS SHALL BE NEW (UNLESS OTHERWISE SPECIFIED ON THE DRAWINGS) AND SHALL CONFORM TO THE NEMA, MASSACHUSETTS ELECTRIC CODE, MICO, AND UNDERWRITERS LABORATORIES ING, STANDARDS IN EVERY CASE WHERE SUCH A STANDARD HAS BEEN ESTABLISHED FOR THE PARTICULAR TYPE OF MATERIAL IN QUESTION.
- 31. ANY MATERIAL, ITEM OR WORK NOT SHOWN ON THE DRAWINGS BUT MENTIONED ON THE SPECIFICATIONS OR NICE-VERBA, OR ANY ACCESSORIES NECESSARY TO MAKE THE WORK COMPLETE IN ALL RESPECTS AND READY FOR OPERATION SHALL BE INCLUDED IN THE CONTRACTORS BID, AND SUCH ITEMS SHALL NOT BE A CAUSE FOR EXTRA WORK OR EXTRA COST TO OWNER.
- 32. THE CONTRACTOR SHALL VISIT THE SITE TO MAKE HIMSELF AWARE OF THE EXISTING CONDITIONS AND EXISTING FOURMENT.
- 33. TEMPORARY ELECTRIC SERVICE
 - A. CONTRACTOR SHALL PROVIDE TEMPORARY ELECTRICAL SERVICE FOR POWER TOOLS, ILLUMINATION, ETC., ELECTRICAL ENERGY WILL BE PAID FOR BY THE OWNER.
 - B. CONTRACTOR SHALL PROVIDE ALL TEMPORARY LIGHTING REQUIRED DURING THE PROGRESS OF THE WORK TO ADEQUATELY ILLUMINATE WORKING AREA.
 - C, ALL TEMPORARY ELECTRICAL WORK SHALL BE IN ACCORDANCE WITH THE APPLICABLE REQUIREMENTS BIDDING, BUT ONLY AS VOLUNTARY ALTERNATES AND THEY MUST MEET THE LETTER AND INTENT OF THE MASSACHUSETTS ELECTRICAL CODE, OSHA, AND ANY LOCAL REQUILATIONS, CONTRACTOR SHALL SECURE AND PAY FOR ALL REQUIRED PERMITS, CHARGES, ETC.
 - D. THE TEMPORARY ELECTRICAL SERVICE AS WELL AS ALL LIGHT FIXTURES, RECEPTACLES, CABLES ETC, SHALL BE REMOVED AFTER CONSTRUCTION IS COMPLETE.
- 34, RECORD DRAWINGS
 - A. DRAWINGS & SUBMIT THEM TO THE ARCHITECT FOR APPROVAL CONTRACTOR SHALL PREPARE A COMPLETE SET OF RECORD CONSTRUCTION
- 35, SUBMIT SHOP DRAWINGS AND PRODUCT DATA WITHIN 10 DAYS AFTER AWARD OF CONTRACT, CHECK, STAMP, AND MARK SUBMITTALS WITH PROJECT NAME BEFORE TRANSMITTING TO THE ARCHITECT.
- 96. WHERE MATERIAL IS CALLED OUT IN THE LEGEND, FIXTURE SCHEDULE, NOTES, SPECIFICATIONS, OR ELSEWHERE BY MANUFACTURER, TYPE OR CATALOG NUMBER, SUCH DESIGNATIONS ARE TO ESTABLISH STANDARDS OF DESIRED QUALITY. ACCEPTANCE OR REJECTIONS OF PROPOSED SUBSTITUTIONS SHALL BE SUBJECT TO THE APPROVAL THE ARCHITECT.
- 37. FINAL INSPECTION
 - A. WHEN THE WORK ON THIS PROJECT HAS BEEN COMPLETED AND IS READY FOR INIAL INSPECTION, SUCH INSPECTION WILL BE MADE. AT THIS TIME, THE CONTRACTOR FOR THE WORK OF THIS SECTION SHALL DEMONSTRATE THAT THE REQUIREMENTS OF THESE SPECIFICATIONS HAVE BEEN MET. WRITTEN RESULTS FOR ALL TESTS SHALL BE SUBMITTED TO THE ENGINEER.



69 Beacon Street Boston, MA 02108 (617) 723-8144

> REWER FOUNTAIN VAULT REPLACEMENT

Massachusetts

Boston,

Common

Boston

REVISIONS
NO. DATE REMARKS

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RONALD W. BUIA, INC.
Electrical Engineers
5 Tillon Lane
Andover, MA 01810
TEL: 976.475.5184
RBUIA@BUIJAENSINEERING.COM


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	Specifications


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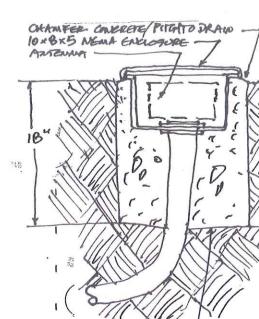
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CHECKED BY: RWB
DATE: 1/18/19
SCALE: AS NOTED
PROJECT NO.: 270118

E3

DRAWING NO.



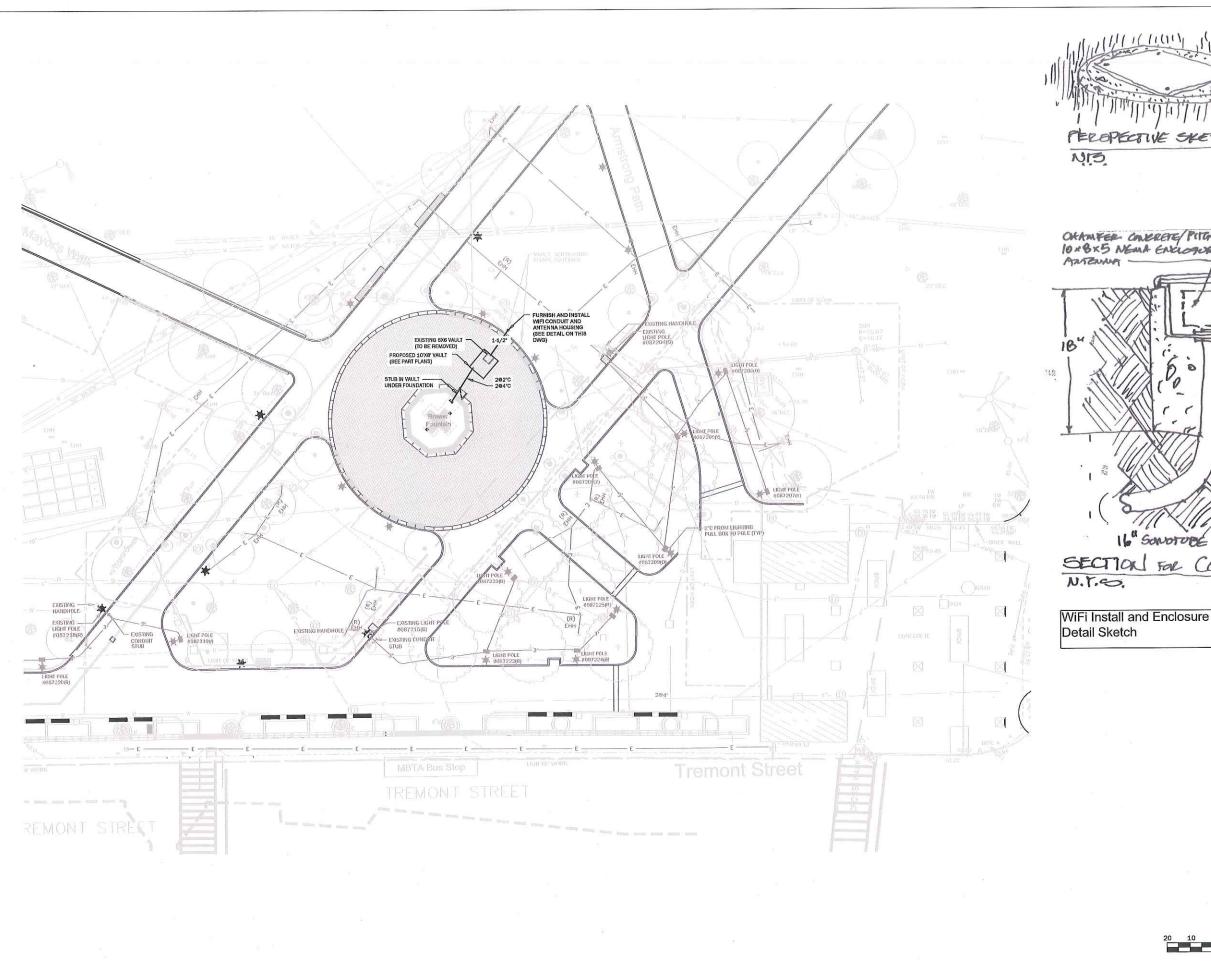

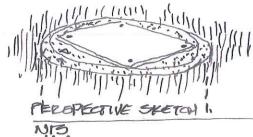

SECTION FOR CONCEPT

WiFi Install and Enclosure



69 Beacon Street Boston, MA 02108 (617) 723-8144

BREWER FOUNTAIN VAULT REPLACEMENT

Boston, Massachusetts

Boston Common

NO.	DATE	REMARKS
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RONALD W. BUIA, INC.

Electrical Engineers


5 Tilton Lane
Andover, MA 01810
TEL: 979.475.5184
RBUIA@BUIAENGINEERING.COM


DRAWING TITLE
Site Power Plan

NORTH	
	North

1"=20" PROJECT NO.: 270118

E1

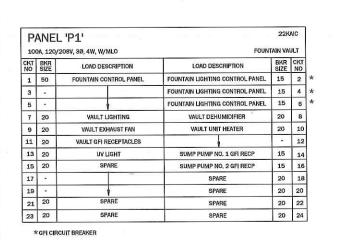

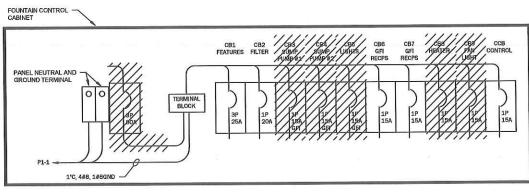



69 Beacon Street Boston, MA 02108 (617) 723-8144

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Boston, Massachusetts

BREWER FOUNTAIN VAULT REPLACEMENT

Boston Common

RONALD W. BUIA, INC.
Electrical Engineers
5 Tilton Lane
Andover, MA 01810
TEL: 978.475.5184

RBUIA@BUIAENGINEERING.COM

RAWING TITLE

Vault Details


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DATE: 2/5/19
SCALE: AS NOTED
PROJECT NO.: 270118


E2

EXISTING DELTA FOUNTAIN CONTROL PANEL 'FCP'
RECONNECT CIRCUIT BREAKERS NO'S CB1, CB2, CB6, CB7, CCB TO EXISTING LOADS.
CIRCUIT BREAKERS SHOWS HATCHED SHALL BE MADE SPARE AND THEIR RESPECTIVE


LOADS SHALL BE RE-POWERED FROM PANELBOARD 'P1',

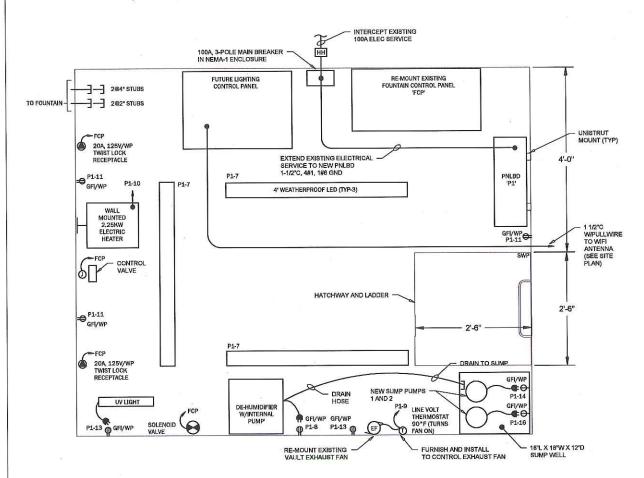

VAULT POWER PLAN SCALE: 1"=1"-0"

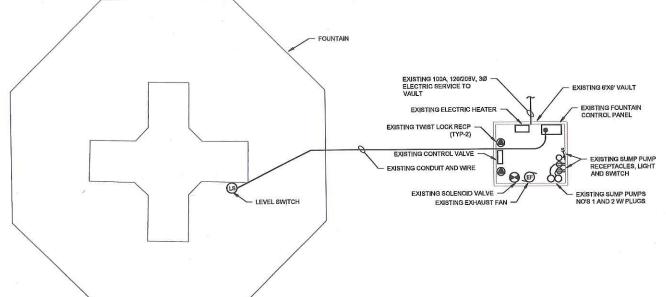

EXISTING FOUNTAIN / VAULT EQUIPMENT LAYOUT

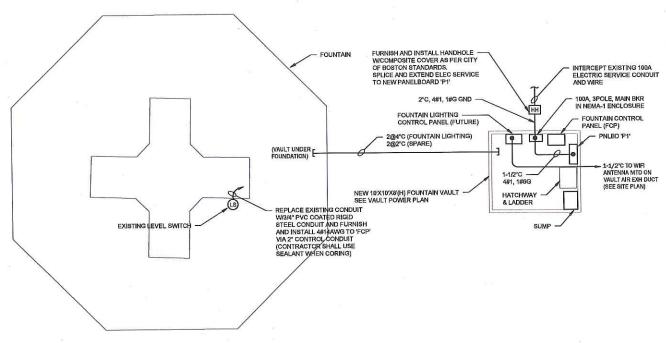

PROPOSED FOUNTAIN / VAULT PANEL AND CONDUIT LAYOUT NOT TO SCALE

ELECTRICAL SPECIFICATIONS

- 1. FURNISH AND INSTALL ALL LABOR, MATERIALS, APPLIANCES, EQUIPMENT TOOLS, TRANSPORTATION, SUPERVISION AND SERVICES REQUIRED TO ELECTRICAL WORK IN ACCORDANCE WITH THE DRAWINGS AND
- 2. THE ELECTRICAL WORK SHALL INCLUDE, BUT NOT BE LIMITED TO THE FURNISHING OF MATERIALS AND INSTALLATION OF THE FOLLOWING IN ACCORDANCE WITH ALL APPLICABLE STATE AND LOCAL CODES.
- 1. HANDHOLES
- 2. WIRING DEVICES
- s. LIGHTING SYSTEMS
- 4. CONDUIT, WIREWAYS, RACEWAYS, ETC
- 5. BRANCH CIRCUIT WIRING
- e, PANELBOARD
- 7. POWER WRING
- 8. GROUNDING SYSTEM
- 9. WIRE AND CABLE
- 10. ELECTRIC UNIT HEATER
- 11. DE-HUMIDIFIER
- 12. MAIN CIRCUIT BREAKER
- 13. DEMOLITION OF EXISTING EQUIPMENT
- ALL WORK SHALL BE IN ACCORDANCE WITH THE LATEST REQUIREMENTS OF THE MEC, MASSACHUSETTS STATE BUILDING CODE, OSHA, ADA, ALL LOCAL CODES AND LOCAL UTILITY CO, STANDARDS & SPECIFICATIONS
- 4. CONTRACTOR SHALL PAY FOR ALL INSPECTION FEES, LICENSES AND PERMITS.
- COORDINATE ANY REQUIRED POWER INTERRUPTIONS AND PERFORM WORK AT TIME CONVENIENT TO OWNER. INCLUDE COSTS FOR REQUIRED PREMIUM TIME
- 6. SUBMIT SHOP DRAWINGS FOR ALL EQUIPMENT FOR APPROVAL BEFORE PURCHASING SAME, ALL EQUIPMENT SHALL BEAR THE LABEL OF A NATIONALLY-RECOGNIZED TESTING LABORATORY.
- - A. FURNISH AND INSTALL THE PANELBOARD FOR LIGHTING AND POWER AS INDICATED AND AS SCHEDULED ON THE DRAWINGS.
 - B. PANELBOARD SHALL BE OF DEAD FRONT CONSTRUCTION WITH THERMAL MAGNETIC CIRCUIT BREAKERS AND SHALL CONFORM TO THE REQUIREMENTS OF NEMA AND MEC, PANELBOARD SHALL BE UL APPROVED AND LABELED,
 - C. PANELBOARD SHALL CONSIST OF CIRCUIT BREAKERS, CODE GAUGE STEEL CABINET OR BACKBOARD, BUS ASSEMBLY, TRIM WITH CODE GAUGE GALVANIZED STEEL DOORS, GUTTER SPACE SHALL BE A MINIMUM OF 4" ON ALL SIDES,
 - D. CIRCUIT BREAKERS OF OF THE QUICK-MAKE, QUICK BREAK TRIP FREE CIRCUIT DEBACATS OF OF THE GUIDANNACE, UGGO, RATEST RITH THE THERMAL MACHET TYPE WITH CHARACTERISTICS AS SCHEDULED. AUTOMATIC TRIPPING SHALL BE CLEARLY INDICATED BY THE OPERATING HANDLE ASSUMING A MID-POSITION BETWEEN ON AND OFF. TWO AND THREE POLE BREAKERS SHALL HAVE COMMON TRIP, ALL CIRCUIT BREAKERS SHALL BE BOLT-ON TYPE.
 - F. PANELBOARD SHALL BE PROVIDED WITH SOLID NEUTRALS. IN ADDITION. GROUNDING BUS WITH LUGS SHALL BE PROVIDED ON ALL PANELBOARDS MEETING UL AND NEMA STANDARDS, ALL BUSSWORK
 - F. TWO MILLED TYPE KEYS SHALL BE PROVIDED WITH PANEL AND ALL PANEL LOCKS SHALL BE KEYED ALIKE.
 - G, BUS ARRANGEMENTS SHALL BE SEQUENCE PHASED SUCH THAT BUS ANTINUMENTAL IS STALL BE SEVENINE FINANCE SIGHT IN A ADJACENT SINGLE POLE BREAKERS SHALL BE CONNECTED TO OPPOSITE PHASES IN SUCH A MANNER, SUCH THAT ANY TWO OR THREE POLE BREAKERS COULD BE INSTALLED ANYWHERE IN THE PANEL BOARD.
- - A FURNISH AND INSTALL LIGHTING FIXTURES AS INDICATED ON THE DRAWINGS, THE LIGHTING FIXTURES SHALL BE SUPPORTED FROM THE VAULT STRUCTURE,
- 9. MECHANICAL SUSPENSION CHANNEL
 - A MECHANICAL SUSPENSION CHANNEL SHALL BE FURNISHED AND INSTALLED TO SUPPORT ELECTRICAL EQUIPMENT (PANELBOARDS

- DISCONNECT SWITCHES, STARTERS, ETC.).
- B. CHANNEL SHALL BE DESIGNED BY UNISTRUT TYPE P3000. ALL FASTENERS AND FITTINGS SHALL BE SUPPLIED TO PROVIDE A COMPLETE INSTALLATION AS REQUIRED.
- C. ALL CHANNEL AND FITTINGS SHALL BE FURNISHED WITH THE MANUFACTURERS STANDARD RUSTPROOF FINISH,
- - A. PROVIDE GROUNDING FOR ALL ELECTRICAL EQUIPMENT AND DEVICES IN ACCORDANCE WITH THE OWNERS STANDARDS AND THE APPLICABLE REQUIREMENTS OF THE MASSACHUSETTS ELECTRICAL CODE AND AS INDICATED ON THE DRAWINGS.
 - B. BONDING JUMPERS SHALL BE INSTALLED AT ALL LOCATIONS REQUIRED
- C. A GREEN GROUNDING CONDUCTOR OF PROPER SIZE SHALL BE INSTALLED AND CONNECTED WITH THE FEEDER CIRCUIT CONDUCTORS TO ALL PANELBOARDS, MOTOR FRAMES, ETC, CONNECTIONS TO THE EQUIPMENT MAY BE BOLTED OR SCREWED USING CORROSION RESISTING BOLTS, SCREWS, A GREEN GROUNDING CONDUCTOR SHALL
- D. ALL EXPOSED CONNECTIONS SHALL BE MADE BY GROUNDED
- 11. ELECTRIC HEATER
 - A. REZNOR EGW ELECTRIC FORCED AIR HEATER, 2,5KW, 208V, 1Ø W/MONITORING BRACKET AND BUILD IN THERMOSTAT OF
- 12. DE-HUMIDIFIER
 - A. 76 PINT DE-HUMIDIFIER WITH INTERNAL PUMP AND 20' DRAIN HOSE,
- 13. RACEWAYS
 - A. ALL VAULT WIRING SHOWN RUN IN CONDUIT ON THE DRAWINGS SHALL BE INSTALLED IN SCHEDULE 40 PVC CONDUIT.
 - B, ALL EXPOSED EXTERIOR CONDUIT RUNS OUTSIDE THE VAULT SHALL BE PVC COATED GALVANIZED STEEL CONDUIT,
 - C. UNDERGROUND CONDUIT SHALL BE SCHEDULE-40 PVC.
 - D. LIQUID-TITE FLEXIBLE METAL CONDUIT SHALL BE USED FOR CONNECTION TO MOTORIZED EQUIPMENT, WITH AN INTERWOVEN GROUND CONDUCTOR (1 1/4* MAXIMUM DIAMETER).
 - E, SET SCREW-TYPE CONNECTORS AND COUPLINGS FOR METAL CONDUIT WILL NOT BE ALLOWED.
- 14. HANGERS & SUPPORTS
 - A. PROVIDE ALL REQUIRED HANGERS, SUPPORTS, SLEEVES, CLAMPS, ETC., AS REQUIRED AND AS INDICATED ON THE DRAWINGS.
- 15. OUTLET BOXES
 - A. BOXES SHALL BE FS OR FD SERIES, WITH CADMIUM PLATED COVERS. STEEL BOXES WILL NOT BE PERMITTED.
- 16. PULL & JUNCTION BOXES
 - A. PULL BOXES SHALL BE CONSTRUCTED OF CODE GAUGE GALVANIZED STEEL AND SHALL BE INSTALLED AT POINTS WHETHER INDICATED ON THE DRAWINGS OR NOT, MINIMUM DIMENSION SHALL NOT BE LESS THAN MEC REQUIREMENTS.
- 17. FEEDER & BRANCH CIRCUIT CONDUCTORS
 - A. ALL FEEDER, BRANCH CIRCUIT, REMOTE CONTROL, SIGNAL CIRCUIT AND INTERLOCK WIRING SHALL BE MANUFACTURED OF COPPER AND RATED 600 VOLTS.
 - B, MINIMUM SIZE WIRE FOR BRANCH CIRCUIT AND POWER WIRING SHALL
 - C. INSULATION TYPE SHALL BE XHHW FOR FEEDERS AND POWER WIRING: THHN/THWN FOR LIGHTING, REMOTE CONTROL, AND SIGNAL CIRCUITS.
 - D. INSULATION TYPE SHALL BE XHHW FOR FEEDERS AND POWER WIRING: THHN/THWN FOR LIGHTING, REMOTE CONTROL, AND SIGNAL CIRCUITS.
 - E. ALL WIRING SHALL CONFORM TO THE MASSACHUSETTS ELECTRICAL CODE FOR CONSTRUCTION AND USE.
- - A. FURNISH AND INSTALL WIRING DEVICES, AND SPECIFICATION GRADE, COMPLETE WITH ALL ACCESSORIES AS INDICATED ON THE DRAWINGS AND AS SPECIFIED HEREUNDER. ALL WIRING DEVICES SHALL BE THE PRODUCT OF A SINGLE MANUFACTURER EXCEPT WHERE SPECIFICAL

STATED OTHERWISE

- B. DUPLEX RECEPTACLES SHALL BE NYLON SPECIFICATION GRADE, U-GROUND, RATED FOR 125VAC, 20A-MANUFACTURED BY BRYAN
- C. SWITCHES SHALL BE NYLON SPECIFICATION GRADE, AC TYPE, RATED 20
- D. DUPLEX RECEPTACLES WITH GROUND FAULT INTERRUPTER CHARACTERISTICS SHALL BE INSTALLED WHERE SPECIFIED ON THE DRAWINGS, ALL WET AREAS SHALL BE GROUND FAULT TYPE WHETHER INDICATED ON THE DRAWINGS OR NOT, GROUND FAULT RECEPTACLES SHALL BE NYLON MANUFACTURED BY BRYANT CAT. NO, 5362-IGI OR
- F. TWIST LOCK RECEPTACLES SHALL BE AS INDICATED ON THE DRAWINGS.
- 19. FURNISH AND INSTALL NAMEPLATES ON ALL ELECTRICAL EQUIPMENT (SCREW
- 20. ALL EQUIPMENT EXPOSED TO MOISTURE SHALL BE OF THE APPROPRIATE (NEMA) WEATHERPROOF TYPE. SEAL ALL CONDUITS THAT PENETRATE EXTERIOR WALLS.
- 21. PERFORM ALL TESTS REQUIRED AND VERIFY CORRECT ROTATION OF ALL MOTORIZED EQUIPMENT, PHASE BALANCE ALL PANELBOARDS IN THE FIELD.
 - A. COMPLETE TEST AND INSPECTION RECORDS SHALL BE MADE AND TESTED. ALL READINGS TAKEN SHALL BE RECORDED. TEST REPORTS SHALL BE SUBMITTED TO THE OWNER'S APPROVAL.,
 - B. FURNISH NECESSARY METERS, INSTRUMENTS, TEMPORARY WIRING AND LABOR TO PERFORM ALL REQUIRED TESTS AND ADJUSTMENTS OF EQUIPMENT AND WIRING INSTALLED AND/OR CONNECTED UNDER THIS CONTRACT, INCLUDING ELECTRICAL EQUIPMENT FURNISHED BY OTHERS, TO DETERMINE PROPER POLARITY, PHASING, FREEDOM FROM GROUND AND SHORTS AND OPERATION OF EQUIPMENT, ALL MEASURING INSTRUMENTS SHALL BE PROPERLY CALIBRATED,
 - C. ALL MATERIALS AND MANNER OF INSTALLATION SHALL BE IN STRICT ACCORDANCE WITH THE APPLICABLE REQUIREMENTS OF STATE AND LOCAL AUTHORITIES, THE UTILITY COMPANY AND THE CODES OF NATIONAL BOARD OF FIRE UNDERWRITERS.
 - D. WHENEVER ANY OF THE AFOREMENTIONED CODES, LAWS, ETC., REQUIRE THAT ANY WORK BE TESTED OR APPROVED, THE CONTRACTOR SHALL PROVIDE PROPER FACILITIES FOR ACCESS AND FOR INSPECTION, ALL AT HIS OWN EXPENSE.

F. WIRING

- a. THE CONTRACTOR SHALL CORRECT OR REPLACE ANY NOMINAL CURRENT-CARRYING CIRCUIT WHICH IS DEFECTIVE OR GROUNDED AND HE SHALL ALSO CORRECT ALL OTHER TROUBLES ENCOUNTERED BY THESE TESTS. ALL DEFECTS WHETHER THROUGH FAULTY WORKMANSHEY OR MATERIAL FURNISHED SHALL BE CORRECTED UNDER THIS SECTION AT THE CONTRACTORS
- 22. ALL ELECTRICAL WORK SHALL BE GUARANTEED FOR A PERIOD OF ONE YEAR FROM DATE OF FINAL ACCEPTANCE, DEFECTS SHALL BE CORRECTED WITHOUT CHARGE, INCLUDING ALL PATCHING, PAINTING AND OTHER INGDIENTAL REPAIRS AND REPLACEMENTS, COORDINATE ALL WORK WITH OTHER TRADES, FURNISH AND INSTALL ALL POWER AND CONTROL WRINING FOR A COMPLETE
- 23. FOR EXACT LOCATION OF MECHANICAL EQUIPMENT SEE MECHANICAL
- 24. ALL ELECTRICAL EQUIPMENT, MATERIALS, ETC. STORED ON SITE SHALL BE STORED IN SUCH A MANNER THAT IT IS SAFE FROM DAMAGE BY MOISTURE,
- 25. THE CONTRACTOR SHALL PERFORM HIS WORK IN A NEAT AND ORDERLY, WORKMANLIKE MANNER, ALL REFUSE, DIRT, AND DEBRIS RESULTANT FROM HIS WORK SHALL BE REMOVED AND PROPERLY DISPOSED OF AT THE END OF THE
 - A. ALL WORK SHALL BE EXECUTED IN A WORKMANLIKE MANNER AND SHALL PRESENT A NEAT APPEARANCE WHEN COMPLETED, AND SHALL INCLUDE THE FURNISHING AND INSTALLATION OF A COMPLETE ELECTRICAL SYSTEM INCLUDING ANY DEMOLITION, PANELBOARDS, CIRCUIT BREAKERS, LIGHTING FEXTURES, CONDUITS, RACEWAYS, WIRING, JUNCTION BOXES, RECEPTACLES, SWITCHES, SUPPORTS, AND ALL OTHER NECESSARY APPURITE/NANCES REQUIRED FOR A COMPLETE OPERATIONAL SYSTEM, INCLUDING THE HANGING AND LAMPING OF ALL FIXTURES.
- 26. THE CONTRACTOR IS REQUIRED TO COORDINATE HIS WORK WITH ALL UTILITIES
- 27. THE CONTRACTOR IS RESPONSIBLE FOR FOLLOWING THE MANUFACTURER'S INSTALLATION RECOMMENDATIONS AND DIRECTIONS FOR ALL EQUIPMENT AT MATERIALS USED.

- 28. IF CONFLICTS ARISE FROM EQUIPMENT INSTALLATION, SCHEDULING, ETC., THESE SHALL BE RESOLVED AS DIRECTED BY THE OWNER TO THE ENTIRE SATISFACTION OF THE OWNER.
- 29. UPON COMPLETION OF THE WORK, THE ELECTRICAL CONTRACTOR SHALL BE REQUIRED TO DEMONSTRATE PROPER OPERATION OF ALL SYSTEMS AND EQUIPMENT IN THE PRESENCE OF THE OWNER AND THE ENGINEER PRIOR TO ACCEPTANCE BY THE COWNER, WRITER RESULTS FOR ALL TESTS AND OPERATIONS SHALL BE SUBMITTED TO THE OWNER OR OWNERS AGENT
- 30. ALL MATERIALS SHALL BE NEW (UNLESS OTHERWISE SPECIFIED ON THE DRAWINGS) AND SHALL CONFORM TO THE NEMA, MASSACHUSETTS ELECTRIC CODE (MEG) AND UNDERWITERS LABORATORIES INC. STANDARDS IN EVERY CASE WHERE SUCH A STANDARD HAS BEEN ESTABLISHED FOR THE PARTICULAR TYPE OF MATERIAL IN QUESTION.
- 31. ANY MATERIAL, ITEM OR WORK NOT SHOWN ON THE DRAWINGS BUT MENTIONED ON THE SPECIFICATIONS OR VICE-VERSA, OR ANY ACCESSORIES NECESSARY TO MAKE THE WORK COMPLETE IN ALL RESPECTS AND READY FOR OPERATION SHALL BE INCLUDED IN THE CONTRACTORS BID, AND SUCH TEMS SHALL NOT BE A CAUSE FOR EXTRA WORK OR EXTRA COST TO OWNER.
- 92. THE CONTRACTOR SHALL VISIT THE SITE TO MAKE HIMSELF AWARE OF THE EXISTING CONDITIONS AND EXISTING EQUIPMENT.
- 33. TEMPORARY ELECTRIC SERVICE
 - A. CONTRACTOR SHALL PROVIDE TEMPORARY ELECTRICAL SERVICE FOR POWER TOOLS, ILLUMINATION, ETC., ELECTRICAL ENERGY WILL BE PAID FOR BY THE OWNER.
 - B. CONTRACTOR SHALL PROVIDE ALL TEMPORARY LIGHTING REQUIRED DURING THE PROGRESS OF THE WORK TO ADEQUATELY ILLUMINATE WORKING AREA.
 - C. ALL TEMPORARY ELECTRICAL WORK SHALL BE IN ACCORDANCE WITH THE APPLICABLE REQUIREMENTS BIDDING, BUT ONLY AS YOLUNTARY ALTERNATES AND THEY MUST MEET THE LETTER AND INTENT OF THE MASSACHUSETTS ELECTRICAL CODE, OSHA, AND ANY LOCAL REGULATIONS, CONTRACTOR SHALL SECURE AND PAY FOR ALL REQUIRED PERMITS, CHARGES, ETC.
 - D. THE TEMPORARY ELECTRICAL SERVICE AS WELL AS ALL LIGHT FIXTURES, RECEPTACLES, CABLES ETC, SHALL BE REMOVED AFTER
- 34. RECORD DRAWINGS
 - A. DRAWINGS & SUBMIT THEM TO THE ARCHITECT FOR APPROVAL CONTRACTOR SHALL PREPARE A COMPLETE SET OF RECORD CONSTRUCTION
- 35. SUBMIT SHOP DRAWINGS AND PRODUCT DATA WITHIN 10 DAYS AFTER AWARD OF CONTRACT, CHECK, STAMP, AND MARK SUBMITTALS WITH PROJECT NAME BEFORE TRANSMITTING TO THE ARCHITECT.
- 38. WHERE MATERIAL IS CALLED OUT IN THE LEGEND, FIXTURE SCHEDULE, NOTES, SPECIFICATIONS, OR ELSEWHERE BY MANUFACTURER, TYPE OR CATALOG NUMBER, SUCH DESIGNATIONS ARE TO ESTABLISH STANDARDS OF DESIRED GUALITY, ACCEPTANCE OR REJECTIONS OF PROPOSED SUBSTITUTIONS SHALL BE SUBJECT TO THE APPROVAL THE ARCHITECT.
- 37. FINAL INSPECTION
 - A. WHEN THE WORK ON THIS PROJECT HAS BEEN COMPLETED AND IS READY FOR FINAL INSPECTION, SUCH INSPECTION WILL BE MADE. AT THIS TIME, THE CONTRACTOR FOR THE WORK OF THIS SECTION SHALL DEMONSTRATE THAT THE REQUIREMENTS OF THESE SPECIFICATIONS HAVE BEEN MET, WAITER REQUITS FOR ALL TESTS SHALL BE SUBMITTED TO THE ENGINEER.



69 Beacon Street Boston, MA 02108 (617) 723-8144

> FOUNTAIN REPLACEMENT N REWEI 8

Massachusetts

Boston,

Common

Boston (

REVISIONS	
NO. DATE	REMARKS
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	3

RONALD W. BUIA, INC. **Electrical Engineers** 5 Tilton Lane Andover, MA 01810 TEL: 978,475,5184 RBUIA@BUIAENGINEERING.COM

WING	TITLE
	Electrical
	Specifications

1	NORTH

DRAWN BY: CHECKED BY: RWE DATE: 2/5/19 AS NOTED SCALE: PROJECT NO.: 270118

SEAL

Barbizon Light of New England Submittal Package for:

Brewer Fountain

Barbizon Light of New England Order #: B180020

Barbizon Light of New England Project Manager: Kyle Costa

Submittal Package Contents:

- Bill of Materials
- Rack Detail Closed
- Rack Detail Open
- Lighting Control System Riser
- Control Equipment Tray Plan View
- LED Driver Tray Plan View

Any questions concerning this system should be directed to the project manager who can be reached at our offices:

The phone number is:

781-935-3920 781-935-9273

The fax number is:

For system energization, contact your Project Manager at least three weeks prior to your requested date.



69 Beacon Street Boston, MA 02108 Phone: 617.723.8144



3 Draper St. Woburn, MA Phone: 1(800) 935-3920

Rev D	RCS	1/17/2019
Rev C	RCS	11/26/2018
Rev B	RCS	9/18/2018
Rev A	RCS	5/20/2018
Revision	By	Date

Brewer Fountain Tremont Street, Boston, MA

> Project Number: B180020

> > **Drawing Title:**

Drawing Index

Drawing Number:

Item	Qty	Description		
ection	I - Con	trol Equipment		
1.1		Mosaic		
	1	Mosaic Show Controller - 1 Universe		
	2	Mosaic 1-Gang, 8-Button Wall Station		
	1	Rack Mount Faceplate for 8-Button Station, 3U		
1.2		Networking & Accessories		
	1	NEMA 3R Rated Heated & Cooled Control Enclosure - 16RU Rack Dimensions: 32" Tall x 28" Wide x 22" Deep		
	1	UFA Rackshelf, 14.5" Deep		
	1	UFA Face Plate, 3U		
	2	500mm x 35mm x 7.5mm DIN-Rail		
	1	DIN Powersupply 48V 100W		
	1	8-Port PoE+ Industrial Switch (IP30) (24V/120W Max)		
	1	DIN-Rail Adapter		
	4	Keystone DIN-Rail Mounting Module		
	1	CAT6 RJ45 Keystone Jack - Full Set		
	4	CAT6 Patch Cable 1'		
	1	Cradle Point Wireless Router		
	1	Cradle Point Antenna		
-	1	DIN Powersupply 12V 30W		
1.3		LED Driver Accessories		
	5	UFA Rackshelf, 14.5" Deep		
	5	UFA Face Plate, 2U		
	4	500mm x 35mm x 7.5mm DIN-Rail		
	12	Terminal Block Connector		
	12	Terminal Strip Jumper		
	28	DIN Powersupply 12V 100W		
Secton	II - Pro	graming & Site Work		
2.1	1	Overnight On-Site Progrmaing Session - Not to Exceed 3 Days		
2.2	1	Control System Low Voltage Terminations		
2.3	1	Mosaic Controller Configuration & Pre-Programing		

Item	Qty	Description
Section	III - Pr	oject Notes
		This quote is based on Barbizon's interpretation the project and is limited to the bill of materials and/or scope of work detailed above.
		Pricing reflects a 3% discount for payment by cash or check within stated terms or by credit card at the time of order. If these pricing terms are not met, this discount will be forfeited by the customer.
		Included Services:
3.1		Project management and coordination
3.2		Drawings for approval within 6-weeks upon acceptance of order.
3.3		Production requires 8 to 12 weeks for delivery of equipment after receipt of written approval and releas
3.4		2-year limited manufacturer's warranty on ETC parts and workmanship. 1-year warranty on all other manufacturers.
3.5		Services of a factory engineer to test and energize system and instruct user personnel.
3.6		All work requires 21 days notice. Work completed M-F during normal working hours.
3.7		Complete set of As-Built drawings and Operation manuals.
3.8		Freight allowed to the job site. Expedited freight is not included.
3.9	8 8	Barbizon's standard insurance applies, certificates available upon request
3.10		Sale subject to Barbizon Terms & Conditions, found at www.barbizon.com
		Exclusions:
3.11		Contents of the General Conditions, related sections or other drawings are not included.
3.12		Conduit and wire not included.
3.13		Asbestos remediation, if called for or encountered is not included.
3.14		Painting and/or Patching of walls or ceilings is not included
3.15		Trash disposal & removal is not included.
3.16		Disconnects, breaker panels and feeders not included
3.17		Installation of dimming and control system not included
3.18		Sales tax, bonding, fees and permits not included.



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Rev D	RCS	1/17/2019
Rev C	RCS	11/26/2018
Rev B	RCS	9/18/2018
Rev A	RCS	5/20/2018
Revision	Ву	Date


Brewer Fountain Tremont Street, Boston, MA


> Project Number: B180020

Drawing Title:

Bill of Materials

Drawing Number:

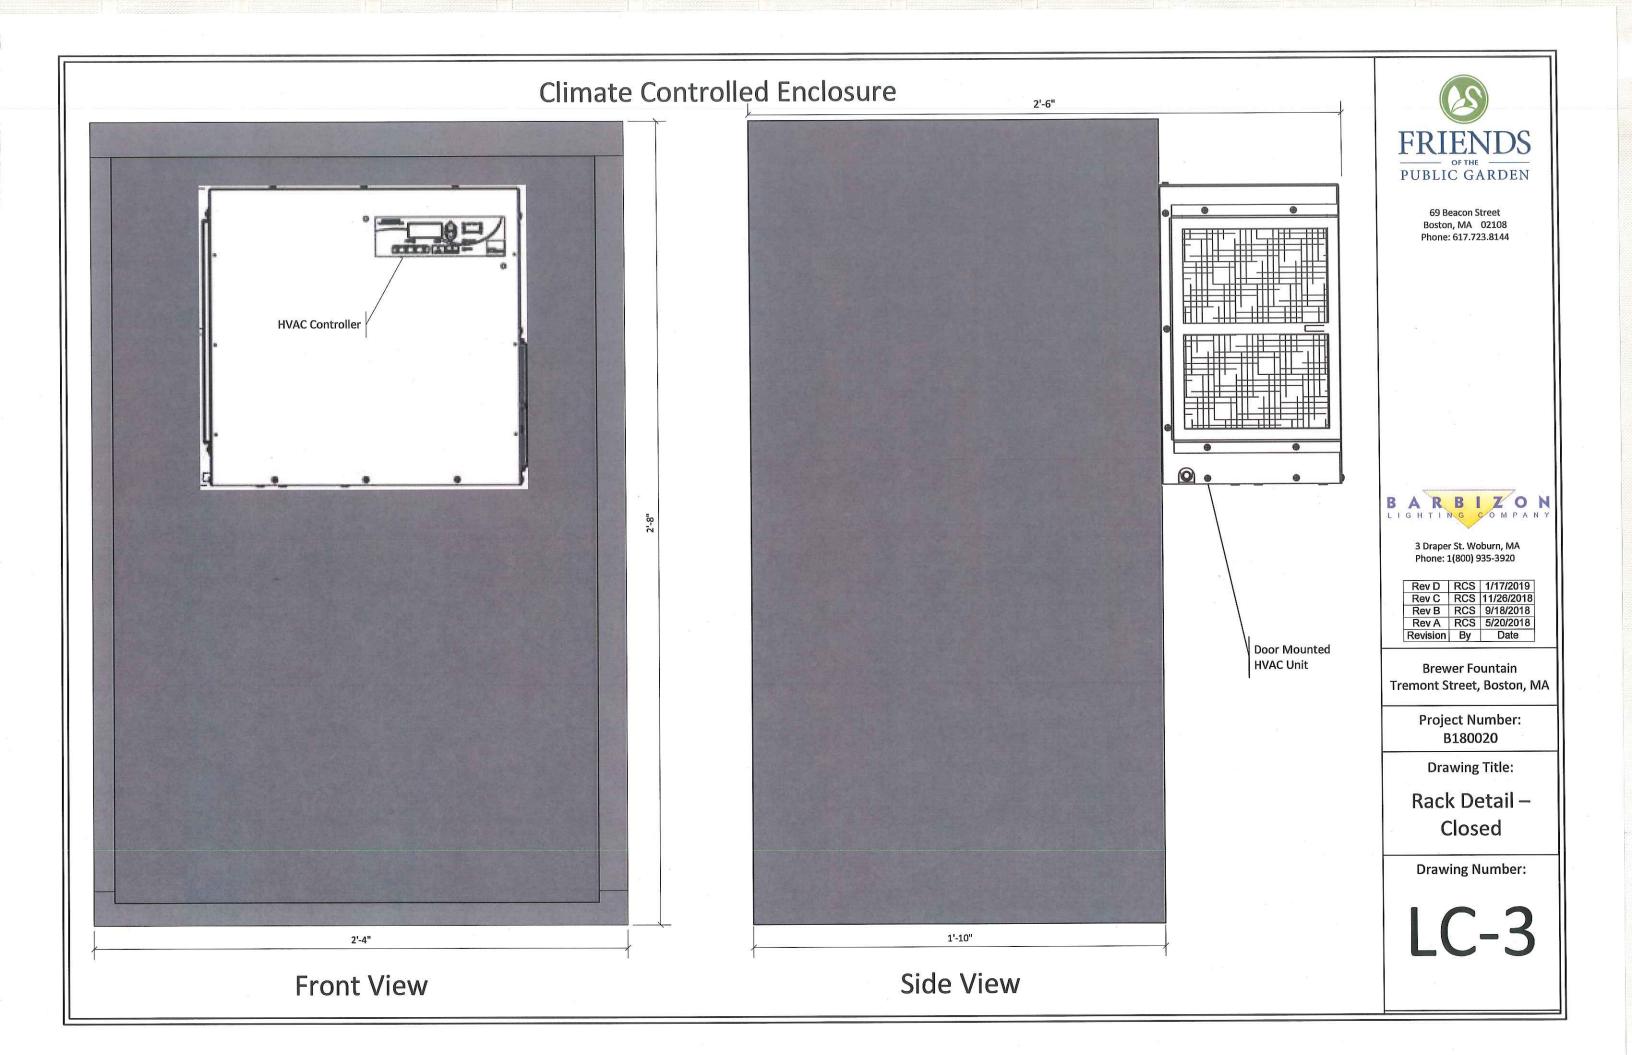

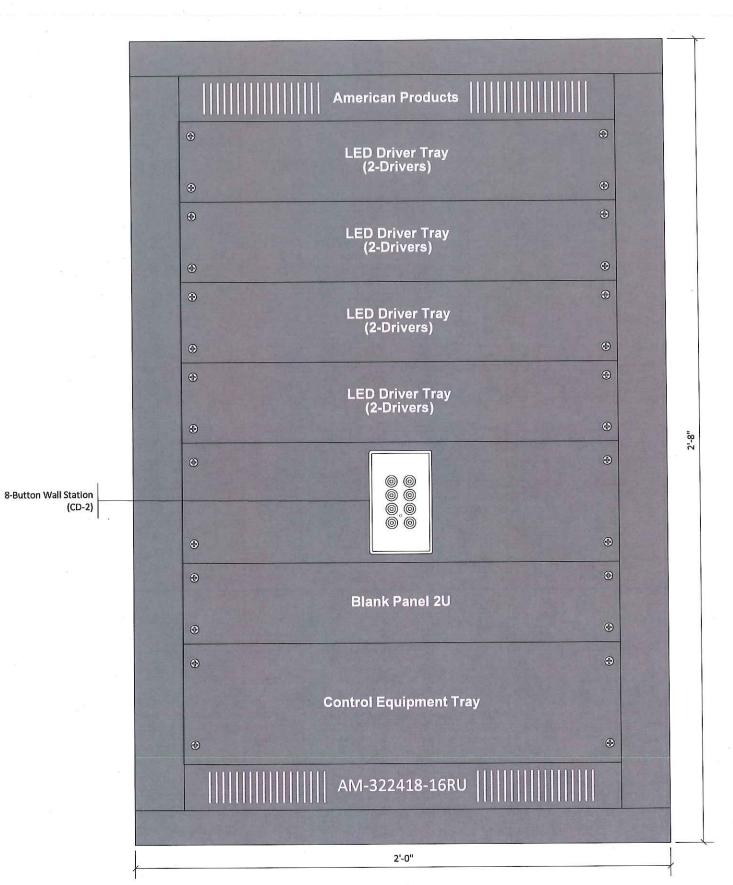



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3 Draper St. Woburn, MA Phone: 1(800) 935-3920

Rev D	PCS	1/17/2019
Rev C		11/26/2018
Rev B	RCS	9/18/2018
Rev A	RCS	5/20/2018
Revision	Ву	Date


Brewer Fountain Tremont Street, Boston, MA

> Project Number: B180020

Drawing Title:

Rack Detail – Open

Drawing Number:

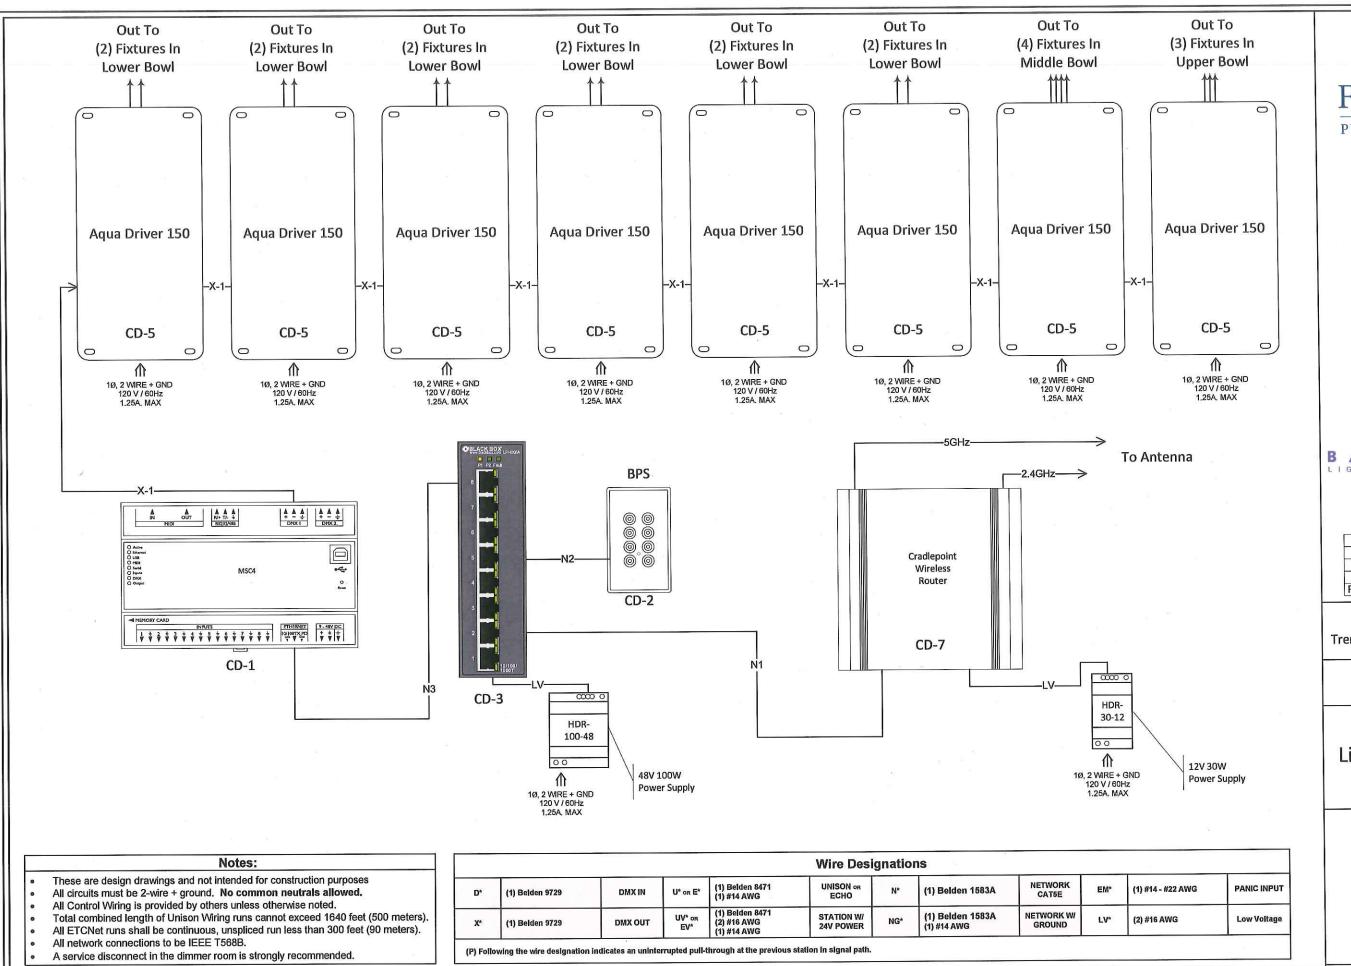



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Rev D	RCS	1/17/2019
Rev C	RCS	11/26/2018
Rev B	RCS	9/18/2018
Rev A	RCS	5/20/2018
Revision	Ву	Date


Brewer Fountain Tremont Street, Boston, MA

> Project Number: B180020

Drawing Title:

Lighting Control System Riser

Drawing Number:

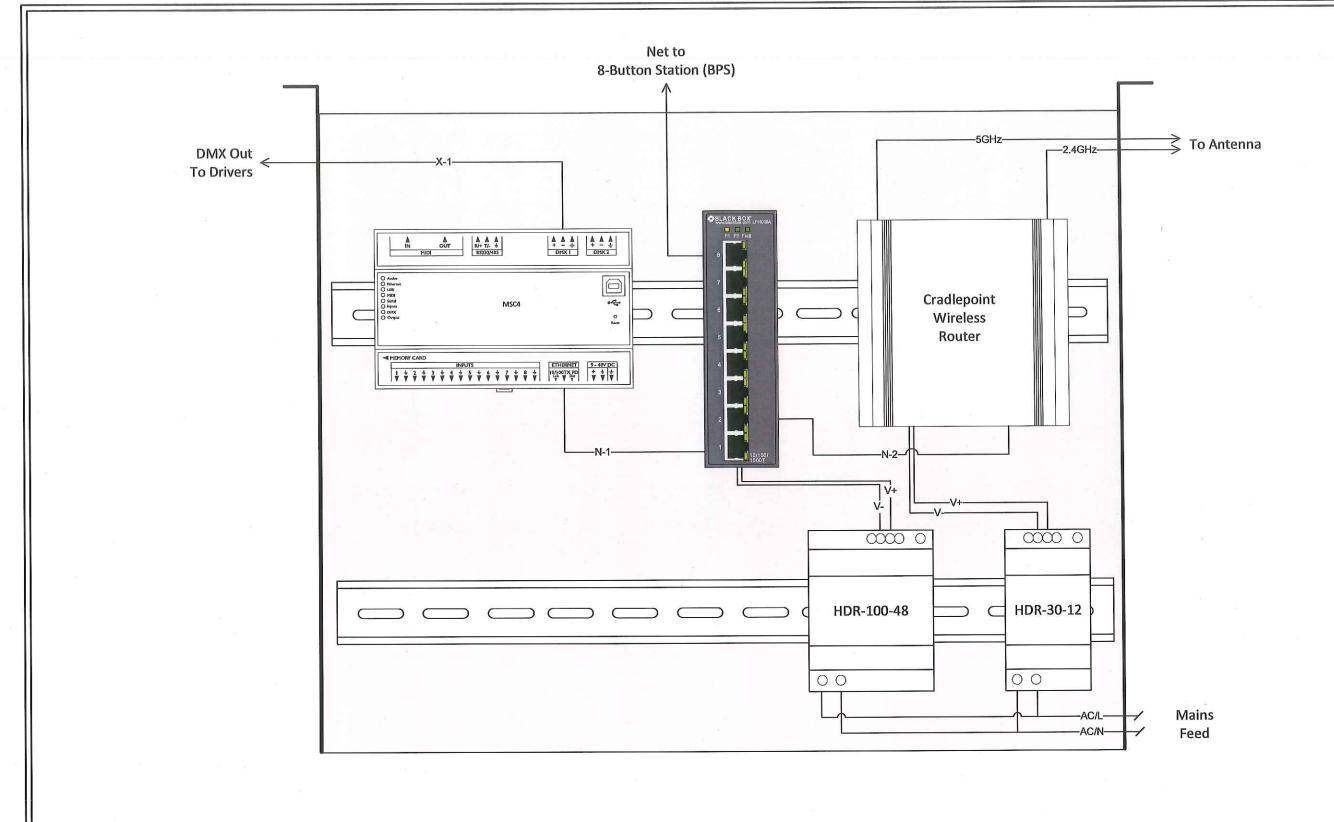

Notes:

- These are design drawings and not intended for construction purposes
- All circuits must be 2-wire + ground. **No common neutrals allowed.**All Control Wiring is provided by others unless otherwise noted.
- Total combined length of Unison Wiring runs cannot exceed 1640 feet (500 meters).

 All ETCNet runs shall be continuous, unspliced run less than 300 feet (90 meters).
- All network connections to be IEEE T568B.
- A service disconnect in the dimmer room is strongly recommended.

	ri e				Wire Desi	gnatio	ns				
D*	(1) Belden 9729	DMX IN	U* or E*	(1) Belden 8471 (1) #14 AWG	UNISON OR ECHO	N*	(1) Belden 1583A	NETWORK CAT5E	EM*	(1) #14 - #22 AWG	PANIC INPUT
X*	(1) Belden 9729	DMX OUT	UV* or EV*	(1) Belden 8471 (2) #16 AWG (1) #14 AWG	STATION W/ 24V POWER	NG*	(1) Belden 1583A (1) #14 AWG	NETWORK W/ GROUND	LV*	(2) #16 AWG	Low Voltage



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Rev D	RCS	1/17/2019
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Rev A	RCS	5/20/2018
Revision	Ву	Date


Brewer Fountain Tremont Street, Boston, MA

> Project Number: B180020

Drawing Title:

Control Equipment Tray - Plan View

Drawing Number:

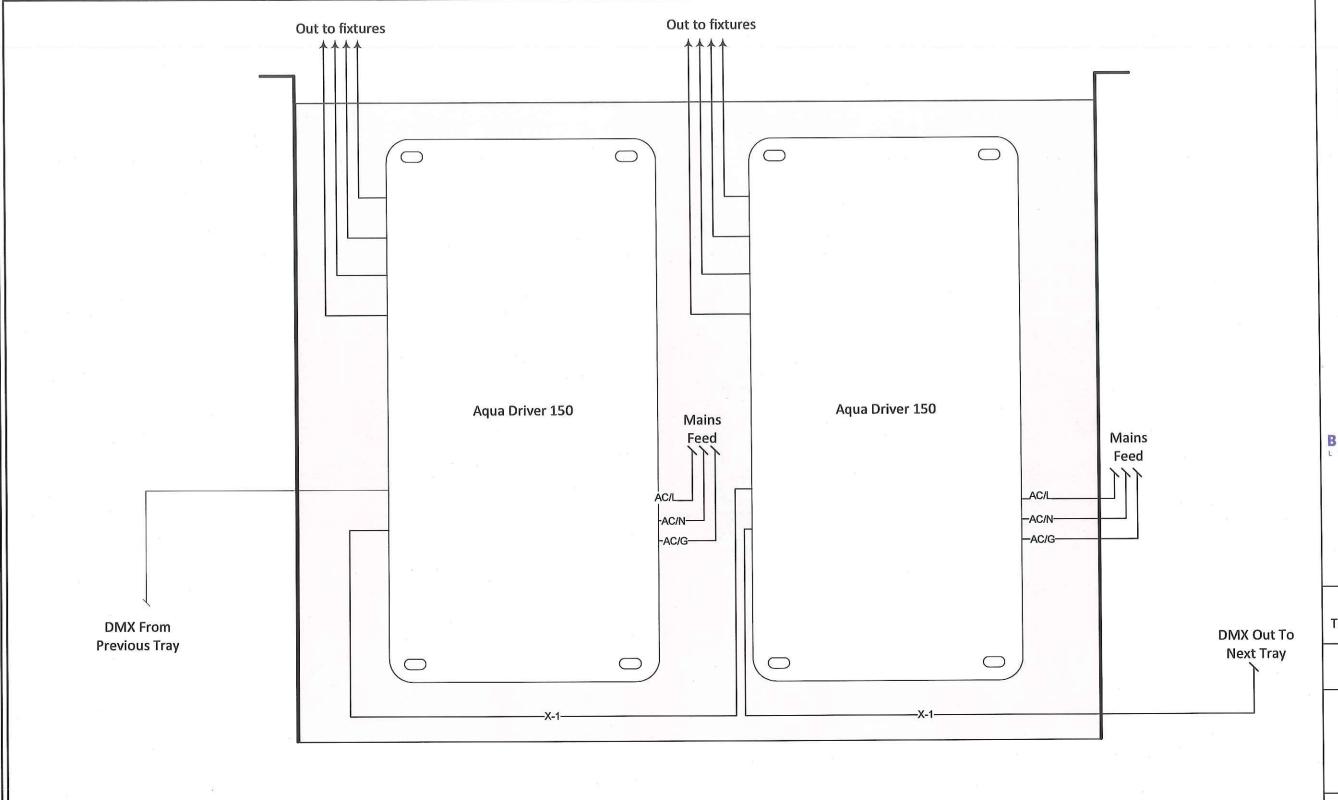

Notes:

- These are design drawings and not intended for construction purposes
- All circuits must be 2-wire + ground. No common neutrals allowed.
- All Control Wiring is provided by others unless otherwise noted.

 Total combined length of Unison Wiring runs cannot exceed 1640 feet (500 meters).
- All ETCNet runs shall be continuous, unspliced run less than 300 feet (90 meters).
- All network connections to be IEEE T568B.
- A service disconnect in the dimmer room is strongly recommended.

					Wire Design	gnatio	ns	574 F			
D*	(1) Belden 9729	DMX IN	U* or E*	(1) Belden 8471 (1) #14 AWG	UNISON OR ECHO	N*	(1) Belden 1583A	NETWORK CAT5E	EM*	(1) #14 - #22 AWG	PANIC INPU
Х*	(1) Belden 9729	DMX OUT	UV* or EV*	(1) Belden 8471 (2) #16 AWG (1) #14 AWG	STATION W/ 24V POWER	NG*	(1) Belden 1583A (1) #14 AWG	NETWORK W/ GROUND	LV*	(2) #16 AWG	Low Voltage



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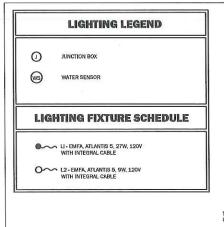
Brewer Fountain Tremont Street, Boston, MA


> Project Number: B180020

Drawing Title:

LED Driver Tray Plan View


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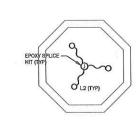


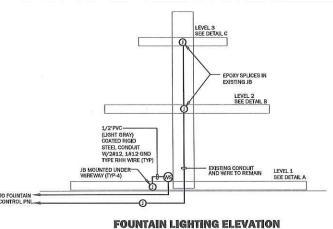


WIREWAY W/EPOXY SPLICE KIT (TYP) - 1/2'PVC COATED GALVANIZED STEEL CONDUIT (LIGHT GRAY) W/2#12, 1#12 GND TYPE RHH WIRE FOUNTAIN CONTROL PANE CONNECT LIGHTING CKT TO EXISTING 15A, 1P-GFI





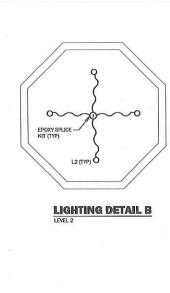

LIGHTING DETAIL B

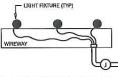

TYPICAL FIXTURE WIRING ELEVATION

ELECTRICAL SPECIFICATIONS

- FURNISH AND INSTALL, COMPLETELY TEST AND MAKE OPERATIVE, ALL ELECTRICAL WORK IN ACCORDANCE WITH THE DRAWINGS AND SPECIFICATIONS
- THE ELECTRICAL WORK SHALL INCLUDE, BUT NOT BE LIMITED TO THE FURNISHING OF MATERIALS AND INSTALLATION OF THE FOLLOWING IN ACCORDANCE WITH ALL APPLICABLE STATE AND LOCAL CODES.

- 4. BRANCH CIRCUIT WIRING
- 5. JUNCTION BOXES
- 6. EPOXY SPLICE BOXES
- ALL WORK SHALL BE IN ACCORDANCE WITH THE LATEST REQUIREMENTS OF THE MEC, MASSACHUSETTS STATE BUILDING CODE, OSHA, ADA, ALL LOCAL CODES AND LOCAL UTILITY CO. STANDARDS & SPECIFICATIONS.
- 4. CONTRACTOR SHALL PAY FOR ALL INSPECTION FEES, LICENSES AND PERMITS
- SUBMIT SHOP DRAWINGS FOR ALL EQUIPMENT FOR APPROVAL BEFORE PURCHASING SAME. ALL EQUIPMENT SHALL BEAR THE LABEL OF A NATIONALLY-RECOGNIZED TESTING LABORATORY.
- A. FURNISH AND INSTALL LIGHTING FIXTURES AS INDICATED ON THE DRAWINGS.
- 8. MECHANICAL SUSPENSION CHANNEL
- A. MECHANICAL SUSPENSION CHANNEL SHALL BE FURNISHED AND INSTALLED TO SUPPORT ELECTRICAL EQUIPMENT (PANELBOARDS, DISCONNECT SWITCHES, STARTERS, ETC.).

- B. CHANNEL SHALL BE DESIGNED BY UNISTRUT TYPE P3000, ALL FASTENERS AND FITTINGS SHALL BE SUPPLIED TO PROVIDE A COMPLETE INSTALLATION AS REQUIRED.
- ALL CHANNEL AND FITTINGS SHALL BE FURNISHED WITH THE MANUFACTURERS STANDARD RUSTPROOF FINISH.

9. GROUNDING

- A. PROVIDE GROUNDING FOR ALL ELECTRICAL EQUIPMENT AND DEVICES IN ACCORDANCE WITH THE MASSACHUSETTS ELECTRICAL CODE AND AS INDICATED ON THE DRAWINGS.
- B. BONDING JUMPERS SHALL BE INSTALLED AT ALL LOCATIONS REQUIRED BY MEC.
- C. A GREEN GROUNDING CONDUCTOR OF PROPER SIZE SHALL BE INSTALLED AND CONNECTED WITH THE FEEDER CIRCUIT CONDUCTORS TO ALL PANEIBOARDS, MOTOR FRAMES, ETC. CONNECTIONS TO THE EQUIPMENT MAY BE BOLTED OR SCIENCE DUSING CORPOSION RESISTING BOLTS, SCREWS, A GREEN GROUNDING CONDUCTOR SHALL BE INSTALLED IN ALL BRANCH AND FEEDER CIRCUITS.
- A. ALL CONDUIT RUNS SHALL BE PVC COATED (LIGHT GRAY) SHALL BE HOT DIPPED GALVANIZED STEEL CONDUIT. CONDUIT.
- 11. HANGERS & SUPPORTS
- PROVIDE ALL REQUIRED HANGERS, SUPPORTS, SLEEVES, CLAMPS, ETC., AS REQUIRED AND AS INDICATED ON THE DRAWINGS.
- 12. JUNCTION BOXES
 - A, BOXES FOR EXTERIOR WORK SHALL BE FS OR FD SERIES, WITH CADMIUM PLATED COVERS, STEEL BOXES WILL NOT BE PERMITTED.
- 13. EPOXY SPLICE BOXES
- EPOXY SOLICE KITS SHALL BE USED FOR ALL LIGHTING SPLICE CONNECTIONS.

- 14. BRANCH CIRCUIT CONDUCTORS

 - MINIMUM SIZE WIRE FOR BRANCH CIRCUIT AND POWER WIRING SHALL BE #12 AWG.
 - C. INSULATION TYPE SHALL BE RHH FOR ALL WIRING.
 - D. ALL WIRING SHALL CONFORM TO THE MASSACHUSETTS ELECTRICAL CODE FOR CONSTRUCTION AND USE.

 - THE CONTRACTOR SHALL CORRECT OR REPLACE ANY NOMINAL CURRENT-CARRYING CIRCUIT WHICH IS DEFECTIVE OR GROUNDED AND HE SHALL ALSO CORRECT ALL OTHER TROUBLES ENCOUNTERED BY THESE TESTS, ALL DEFECTS WHETHER THROUGH FAULTY WORKMANSHIP OR MATERIAL PURINISHED SHALL BE CORRECTED UNDER THIS SECTION AT THE CONTRACTOR'S EXPENSE.
- 15. ALL ELECTRICAL WORK SHALL BE GUARANTEED FOR A PERIOD OF ONE YEAR FROM DATE OF FINAL ADDEPTANCE. DEFECTS SHALL BE CORRECTED WITHOUT CHARGE. INCLUDIOS ALL PATCHING, PANTING AND OTHER INCIDENTAL REPAIRS AND REPLACEMENTS, COORDINATE ALL WORK WITH OTHER TRADES, FURNISH AND INSTALL ALL POWER AND CONTROL WIRING FOR A COMPLETE INSTALLATION.
- 16. ALL ELECTRICAL EQUIPMENT, MATERIALS, ETC. STORED ON SITE SHALL BE STORED IN SUCH A MANNER THAT IT IS SAFE FROM DAMAGE BY MOISTURE, IMPACT, ETC.
- ELECTRICAL CONTRACTOR SHALL PERFORM HIS WORK IN A NEAT AND ORDERLY, WORKMANLIKE MANNER. ALL REPUSE, DIRT, AND DEBRIS RESULTANT FROM HIS WORK SHALL BE REMOVED AND PROPERLY DISPOSED OF AT THE END OF THE DAY.
- A. ALL WORK SHALL BE EXECUTED IN A WORKMANLIKE MANNER AND SHALL PRESENT A NEAT APPEARANCE WHEN COMPLETED, AND SHALL INCLUDE THE FURNISHING AND INSTALLATION OF A COMPLETE ELECTRICAL SYSTEM INCLUDING LIGHTING FIXTURES EPOXY SPICE KITS, WIREWAYD, SUPPORTS, CONDUITS, WIRNING JUNCTION BOXES, AND ALL OTHER NECESSARY APPURTENANCES REQUIRED FOR A COMPLETE OPERATIONAL SYSTEM, INCLUDING THE LAMPING OF ALL FIXTURES.

- IF CONFLICTS ARISE FROM EQUIPMENT INSTALLATION, SCHEDULING, ETC., THESE SHALL BE RESOLVED AS DIRECTED BY THE OWNER TO THE ENTIRE SATISFACTION OF THE OWNER.
- 20. UPON COMPLETION OF THE WORK, THE ELECTRICAL CONTRACTOR SHALL BE REQUIRED TO DEMONSTRATE PROPER OPERATION OF THE LIGHTING SYSTEM AND EQUIPMENT IN THE PRESENCE OF THE OWNER AND THE ENGINEER PRIOR TO ACCEPTANCE BY THE OWNER.
- 21. ALL MATERIALS SHALL BE NEW (UNLESS OTHERWISE SPECIFIED ON THE DRAWINGS)
 AND SHALL CONFORM TO THE NEMA, MASSACHUSETTS ELECTRIC CODE (MEC)
 AND UNDERWRITERS LABORATORIES INC, STANDARDS IN EYERY CASE WHERE
 SUCH A STANDARD HAS BEEN ESTABLISHED FOR THE PARTICULAR TYPE OF
- 22. ANY MATERIAL, ITEM OR WORK NOT SHOWN ON THE DRAWINGS BUT MENTIONED ON THE SPECIFICATIONS OR VICE-VERSA, OR ANY ACCESSORIES NICESSARY TO MAKE THE WORK COMPLETE IN ALL RESPECTS AND READY FOR OPERATION SHALL BE INCLIDED IN THE CONTRACTORS BID, AND SUCH ITEMS SHALL NOT BE A CAUSE FOR EXTRA WORK OR BETTAR COST TO
- THE ELECTRICAL CONTRACTOR SHALL VISIT THE SITE TO MAKE HIMSELF AWARE OF THE EXISTING CONDITIONS AND EXISTING EQUIPMENT.
- 24. RECORD DRAWINGS
 - CONTRACTOR SHALL PREPARE A COMPLETE SET OF RECORD CONSTRUCTION DRAWINGS & SUBMITTHEM TO THE ARCHITECT FOR APPROVAL.
- SUBMIT SHOP DRAWINGS AND PRODUCT DATA WITHIN 10 DAYS AFTER AWARD OF CONTRACT, CHECK, STAMP, AND MARK SUBMITTALS WITH PROJECT NAME BEFORE TRANSMITTING TO THE ARCHITECT.
- 26. FINAL INSPECTION
- A. WHEN THE WORK ON THIS PROJECT HAS BEEN COMPLETED AND IS READY FOR FINAL INSPECTION, SUCH INSPECTION WILL BE MADE, AT THIS TIME, THE CONTRACTOR FOR THE WORK OF THIS SECTION SHALL DEMONSTRATE THAT THE REQUIREMENTS OF THESE SPECIFICATIONS HAVE



69 Beacon Street Boston, MA 02108 (617) 723-8144

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MALL Boston, Massachusetts AYETTE 1 FOUNT!


Site SE 3 - LA
Landscape 9 Common BREWER PHASE 3-PHASI Boston

REVISIONS	55.445.45
NO. DATE	REMARKS
-	

RONALD W. BUIA, INC. **Electrical Engineers**

5 Tilton Lane Andover, MA 01810 TEL: 978.475.5184 RBUIA@BUIAENGINEERING.COM

DRAWING TITLE Existing Lighting Plan

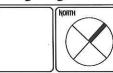

CHECKED BY: 2/5/19 AS NOTED SCALE: PROJECT NO.: 2380118

R1

EXISTING CONDITIONS DRAWING FOR REFERENCE ONLY

LIGHTING LEGEND

── LIGHTING DRIVER CABLE (FURNISHED WITH LIGHTING FIXTURE)

CONDUIT STUB W/BUSHING

■ LED LIGHT FIXTURE


FOUNTAIN LIGHTING NOTES

- EXISTING CONDUIT AND CORE TO REMAIN FOR WATER SENSOR ONLY, GC DRILL FOUR NEW 3" DIAMETER CORES THROUGH BOTTOM OF LOWER BOWL AND SEAL W/ EPOXY GROUT.
- 12 0 2700K WHITE LED UNDERWATER ACCENT FIXTURES TYPE UWILL MOUNTED TO NEW ALUMINUM SUPPORT STRUTS, 3 PER STRUT, RUN FEED CABLES TO COMPRESSION FITTINGS IN MULTI-HUB UNDERWATER EXTRUDED STRUT.
- NEW ALUMINUM FIXTURE SUPPORT STRUTS AND ATTACH NEW FIXTURES TO STRUTS, FABRICATE AND ATTACH NEW 1/2" CLEAR LEXAN CYLINDRICAL SHIELDS WIJNER ALUMINUM SLEEVES TO RESIST VANDALISM, PER DETAIL SEE RIPMAN DRAWINGS SKE-1. & 2
- 4. 4 @ 2700K WHITE LED UNDERWATER ACCENT FIXTURES TYPE UW1M MOUNTED TO NEW STAINLESS STEEL SLOTTED CHANNEL.
- 5. NEW SLOTTED CHANNEL SUPPORT RINGS, SEE RIPMAN DRAWING SKE-3
- 3 @ 2700K WHITE LED UNDERWATER ACCENT FIXTURES TYPE UW1S MOUNTED TO NEW STAINLESS STEEL SLOTTED CHANNEL.
- AFTER ALL CABLES HAVE BEEN INSTALLED IN CONDUIT TO THE DRY YAULT, CONTRACTOR SHALL CAP/FOAM SEAL CONDUITS, SEALS SHALL BE TEMPORARY TO ALLOW FOR FUTURE WIRE INSTALLATION IN CONDUIT.

_		NG PANEL '	P1'	FOUN	22K TAIN VA	100000
CKT	BKR SIZE	LOAD DESCRIP	PTION	LOAD DESCRIPTION	BKR SIZE	CKT
1	50	FOUNTAIN CONTR	OL PANEL	FOUNTAIN LIGHTING CONTROL PANEL	15	2
3	7			FOUNTAIN LIGHTING CONTROL PANEL		4
5	90	•		FOUNTAIN LIGHTING CONTROL PANEL	15	6
7	20	VAULT LIGHT	ING	VAULT DEHUMIDIFIER	20	В
9	20	VAULT EXHAUS	ST FAN	VAULT UNIT HEATER	20	10
11	20	VAULT GFI RECEI	PTACLES			12
13	20	nA righ.	Т	SUMP PUMP NO. 1 GFI RECP	15	14
15	20	SPARE		SUMP PUMP NO, 2 GFI RECP	15	16
17				SPARE	20	18
19	-			SPARE	20	20
21	20	SPARE	[] 2	SPARE	20	22
23	20	SPARE	į.	SPARE	20	24

*GFI CIRCUIT BREAKER

NOTE: CONTRACTOR TO POWER BARBIZON FOUNTAIN LIGHTING CONTROL PANEL FROM PANELBAORD 'P1, CKT NO. 2,4,6

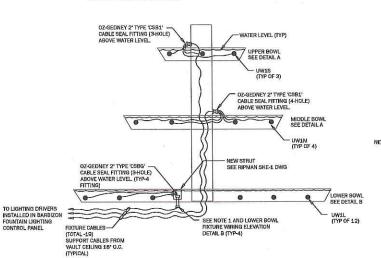


(SUPPORT FROM CEILING 18' 0.0: WET VAULT -- SEE NOTE 8 LIGHTING CABLES, CONNECT TO — DEVICES IN LIGHTING CONTROL PANEL FURNISH AND INSTALL WITH CABLES TO VAULT VENT WHI ANTENNA (SEE SITE PLAN) REGIZES AND THE REGI NEW DRY VAULT -

XISTING WATER

FOUNTAIN LIGHTING ELEVATION

LIGHTING DETAIL 'C'

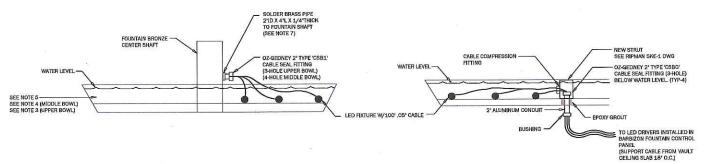


UPPER/MIDDLE BOWL WIRING DETAIL 'A'

LOWER BOWL WIRING DETAIL 'B' - TYP-4 QUADRANTS

Conduit Sealing Bushings


Details of Construction

- aling Ring:

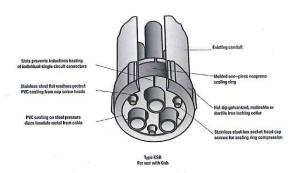

Conduit Sealing Bushings For Use with Cable in Rigid Conduit ®

	Max.	Diameter of Millimeter	Wire Permitte s (Inches)	od Ø			Dim	ensions in Mi	Mimeters (Inc	hes)	
Conduit (1) Size	1 Hole	2 Holes	3 Holes	4 Holes	Conduit ID	A Dia.	В	G	D.	Ε	F Min
1-1/2*	19.81 (0.78)	12.45 (0.49)	13.46 (0.53)	11.18 (0.44)	1.610	60,45 (2.36)	16.00 (0.63)	22.35 (0.68)	7.87 (0.31)	7.87 (0.31)	31.75 (1.25)
2.	26.91 (1.02)	19.56 (0.77)	18.03 (0.71)	15.49 (0.61)	2.067	74.42 (2.93)	16.00 (0.63)	22.35 (0.88)	7.87 (0.31)	7.87 (0.31)	31.75 (1.25)
2-1/2"	33.53	24.38 (0.96)	22.61 (0.89)	19.81 (0,78)	2.469	65.65 (3.38)	19.05 (0.75)	22.35 (0.88)	7.87 (0.31)	7.87 (0.31)	31.75 (1.25)
3°	48,01 (1.89)	30,48 (1.20)	28.70 (1.13)	24.38 (0.96)	3.068	104.90 (4.13)	19.05 (0.75)	22.35 (0.88)	7.87 (0.31)	7.87 (0.31)	31.75 (1.25)
3-1/2"	54.10 (2.13)	35.53 (1.32)	35.05	28.70 (1.13)	3.548	115.82 (4.66)	22.35 (0.68)	22.35 (0.88)	11.18 (0.44)	9.65 (0.38)	38.10 (1.50)
4*	66.28 (2.57)	41.40 (1.63)	38.35 (1.51)	32.00 (1.26)	4.026	130.30 (5.13)	7.87 (0.31)	25.40 (1.00)	11.18 (0.44)	9,65 (0.38)	38.10 (1.50)
5*	87.63 (3.45)	50.80 (2.00)	47.75 (1.88)	41,40 (1.63)	5,047	158.75 (6.25)	7.87 (0.31)	25.40 (1.00)	11.18 (0.44)	9.65 (0.38)	38.10 (1.50)
6*	109.73	63.75	(2.38)	54.10 (2.13)	6.065	187.45	7.87 (0.31)	25.40 (1.00)	11.18	9.65 (0.38)	38.10 (1.50)

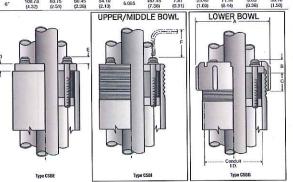



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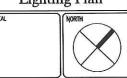
Boston, Massachusetts BREWER FOUNTAIN PLA FOUNTAIN LIGHTING RENOVATION

Common Boston


REVISIONS NO, DATE REMARKS
1 11/8/18 VAULT COORDINATIN


RONALD W. BUIA, INC. Electrical Engineers 5 Tilton Lane Andover, MA 01810 TEL: 978.475.5184

Proposed Lighting Plan



DRAWN BY: KML DRAWING NO. CHECKED BY: 2/5/19 DATE: SCALE: AS NOTED PROJECT NO.: 2380118

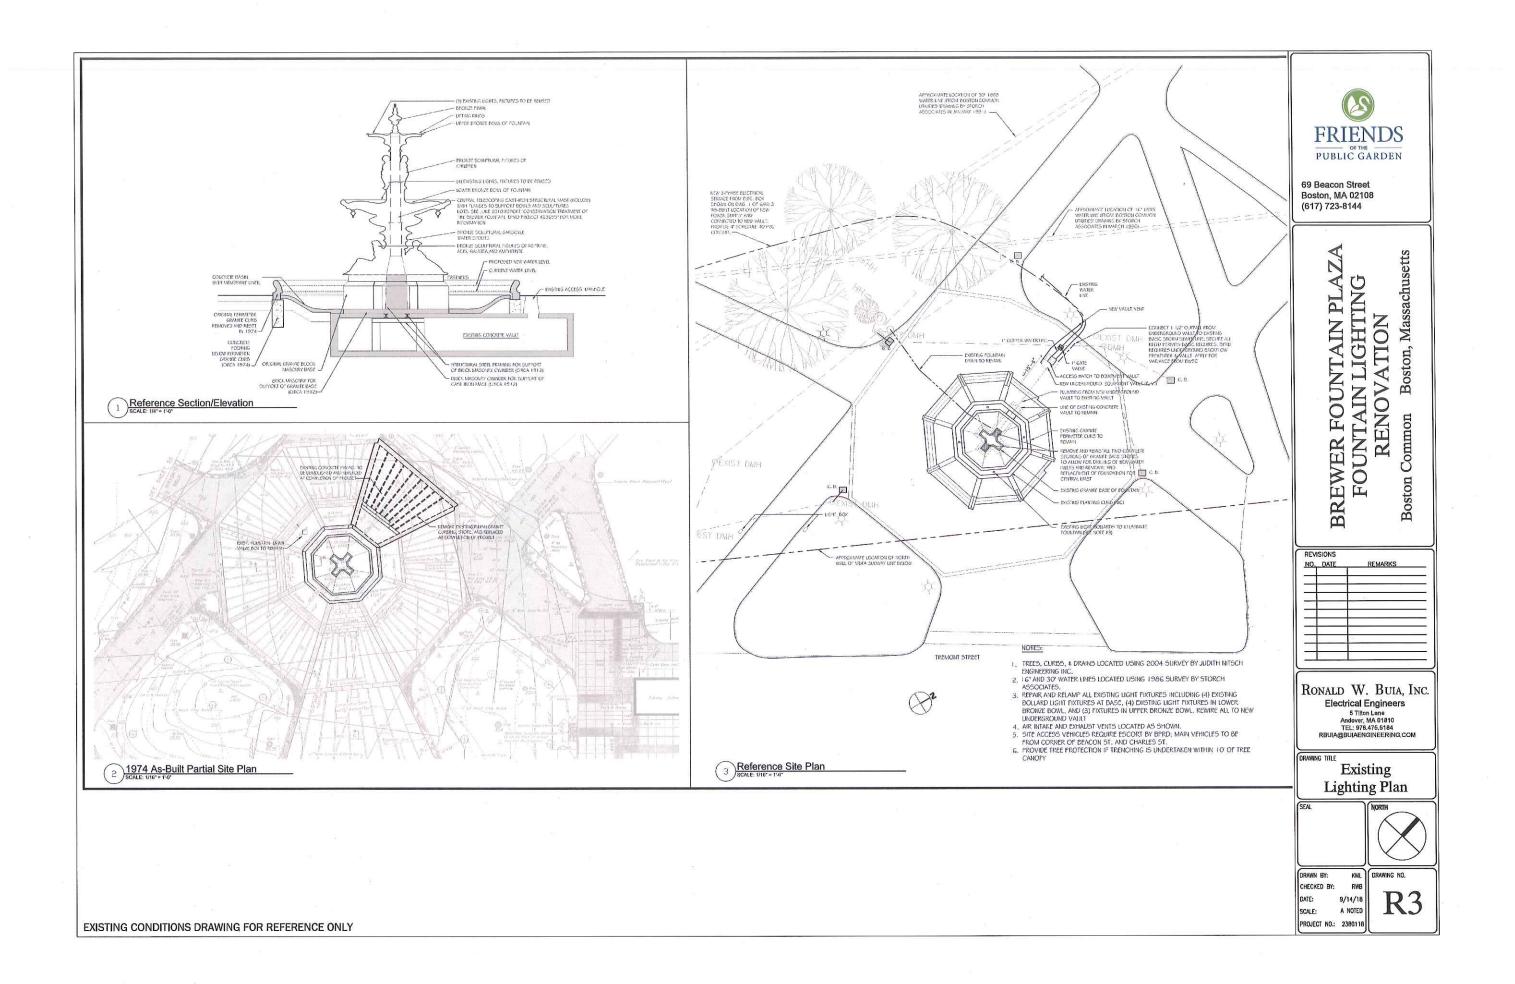

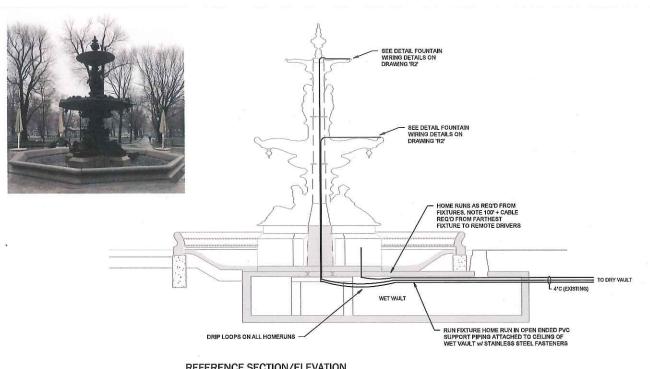





69 Beacon Street Boston, MA 02108

(617) 723-8144

BREWER FOUNTAIN PLA FOUNTAIN LIGHTING RENOVATION

Boston, Massachusetts Common

Boston

NO. DATE REMARKS
1 11/6/18 VAULT COORDINATIN REVISIONS

RONALD W. BUIA, INC. Electrical Engineers

5 Tilton Lane Andover, MA 01810 TEL: 978,475,5184

Proposed Lighting Details



KML CHECKED BY: RWB 2/5/19 DATE: SCALE: AS NOTED PROJECT NO.: 2380118

DRAWING NO.

REFERENCE SECTION/ELEVATION



TAG FOR LOCATION + REMOVE

4 EXISTING STRUTS IN LOWER BOWL,
EXISTING STRUTS IN LOWER BOWL,
EXISTING STRUT LOCATIONS ARE
TO BE IDENTIFIED USING ROMAN
NUMERAL SPER KEY ABOVE, SCRIBE
ROMAN NUMERAL CORRESPONDING
TO LOCATION ONTO BOTH END OF
EACH STRUT BEFORE CUTTING AND
REMOVING, EC SEND STRUT HALVES
REMOVED TO NEW STRUT FABRICATOR
TO USE AS DIMENSIONAL TEMPLATES
FOR NEW STRUTS, (SEE DETAILS ON
RIPMAN DWGS SKE-1 & 2


CORE NEW HOLES
THROUGH BASE TO
VAULT BELOW (TYP)
(1) + INSTALL NEW 2'
CONDUIT DROPS (4)
WINEW MULTI-HUB
UNDER WATER RATED
OZ GEONEY 2" CSGB'
WATER SEAL FITTING
FOR HOME RUNS

EXISTING STRUT, LOWER BOWL

FABRICATE NEW STAINLESS STEEL — FIXTURE SUPPORT CHANNEL IN TWO HALVES, SPLICE NEW SS CHANNEL BELOW WATERFEED PIPES



FOUNTAIN - MIDDLE BOWL, EMPTY

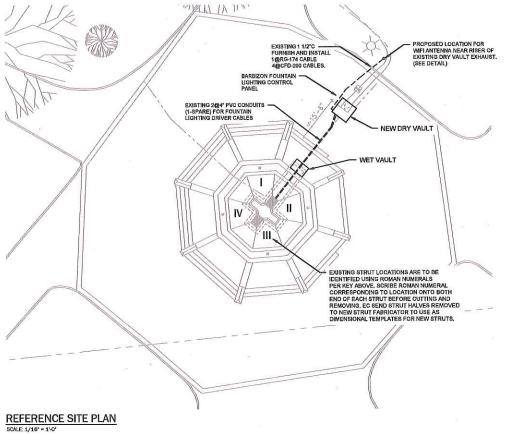

ELECTRICAL SPECIFICATIONS

- FURNISH AND INSTALL ALL LABOR, MATERIALS, APPLIANCES, EQUIPMENT TOOLS, TRANSPORTATION, SUPERVISION AND SERVICES REQUIRED TO FURNISH AND INSTALL, COMPLETELY TEST AND MAKE OPERATIVE, ALL ELECTRICAL WORK IN ACCORDANCE WITH THE DRAWNINGS AND SPECIFICA
- THE ELECTRICAL WORK SHALL INCLUDE, BUT NOT BE LIMITED TO THE FURNISHING OF MATERIALS AND INSTALLATION OF THE FOLLOWING IN ACCORDANCE WITH ALL APPLICABLE STATE AND LOCAL CODES.
- DISCONNECT AND REMOVE EXISTING FOUNTAIN LIGHTING FIXTURES WITH ASSOCIATED CONDUIT, WIRING SUPPORTS, FITTING, ETC.
- 2. GROUNDING
- 3. LIGHTING FIXTURES FURNISHED W/CABLE (100')
- 4. LIGHTING FIXTURE MOUNTING BRACKETS, UNISTRUT, ETC.
- 5. LED LIGHTING DRIVERS (TOTAL-8)
- 6. CONDUIT, WIREWAYS ETC.
- 7. BRANCH CIRCUIT WIRING
- 8. OZ GEDNEY 3 & 4 HOLE WATER SEAL FITTINGS
- 9. WIRE AND CABLE
- 10. WHE CABLES AND HOUSING
- 11. INSTALLATION OF BARBIZON LIGHTING CONTROL PANEL
- ALL WORK SHALL BE IN ACCORDANCE WITH THE LATEST REQUIREMENTS OF THE MEC, MASSACHUSETTS STATE BUILDING CODE, OSHA, ADA, ALL LOCAL CODES AND LOCAL UTILITY CO, STANDARDS & SPECIFICATIONS.
- 4. CONTRACTOR SHALL PAY FOR ALL INSPECTION FEES, LICENSES AND PERMITS.
- 5. COORDINATE ANY REQUIRED POWER INTERRUPTIONS AND PERFORM WORK AT TIME CONVENIENT TO OWNER. INCLUDE COSTS FOR REQUIRED PREMIUM TIME.
- SUBMIT SHOP DRAWINGS FOR ALL EQUIPMENT FOR APPROVAL BEFORE PURCHASING SAME. ALL EQUIPMENT SHALL BEAR THE LABEL OF A NATIONALLY-RECOGNIZED TESTING LABORATORY.

7. FOUNTAIN LIGHTING

- FURNISH AND INSTALL LIGHTING FIXTURES AS INDICATED ON THE DRAWINGS.
- 8. MECHANICAL SUSPENSION CHANNEL
- A. MECHANICAL SUSPENSION CHANNEL AND BRACKETS SHALL BE FURNISHD AND INSTALLED TO SUPPORT FOUNTAIN LIGHTING FIXTURES.
- B. CHANNEL SHALL BE STAINLESS STEEL B-LINE CHANNEL OR APPROVED EQUAL (MATERIAL TYPE M-2) ALL FASTENERS AND FITTINGS SHALL BE SUPPLIED TO PROVIDE A COMPLETE INSTALLATION AS REQUIRED.
- C. ALL CHANNEL AND FITTINGS SHALL BE STAINLESS STEEL.
- 9. GROUNDING
- A. PROVIDE GROUNDING FOR ALL ELECTRICAL EQUIPMENT AND DEVICES IN ACCORDANCE WITH THE MASSACHUSETTS ELECTRICAL CODE AND AS INDICATED ON THE DRAWINGS.
- B. BONDING JUMPERS SHALL BE INSTALLED AT ALL LOCATIONS REQUIRED BY MEG.
- C. A GREEN GROUNDING CONDUCTOR OF PROPER SIZE SHALL BE INSTALLED AND CONNECTED WITH THE FEEDER CIRCUIT CONDUCTORS TO ALL PANELBOARDS, MOTOR FRAMES, ETC. CONNECTIONS TO THE EQUIPMENT MAY BE BOLTED OR SCREWED USING CORROSION RESISTING BOLTS, SCREWS, A GREEN GROUNDING CONDUCTOR SHALL BE INSTALLED IN ALL BRANCH AND FEEDER CIRCUITS.
- - A. CONDUIT SHALL BE GRAY EPOXY COATED TYPE GRC.
- 11. HANGERS & SUPPORTS
- PROVIDE ALL REQUIRED HANGERS, SUPPORTS, SLEEVES, CLAMPS, ETC., AS REQUIRED AND AS INDICATED ON THE DRAWINGS.
- 12. JUNCTION BOXES
 - A. BOXES FOR EXTERIOR WORK SHALL BE FS OR FO SERIES, WITH CADMIUM PLATED COVERS, STEEL BOXES WILL NOT BE

- 13. BRANCH CIRCUIT CONDUCTORS
 - ALL BRANCH CIRCUIT WIRING SHALL BE MANUFACTURED OF COPPER AND RATED 600 VOLTS,
 - MINIMUM SIZE WIRE FOR BRANCH CIRCUIT AND POWER WIRING SHALL BE #12 AWG,
 - C. INSULATION TYPE SHALL BE XHHW FOR ALL WIRING.
- D. ALL WIRING SHALL CONFORM TO THE MASSACHUSETTS ELECTRICAL CODE FOR CONSTRUCTION AND USE.
- THE CONTRACTOR SHALL CORRECT OR REPLACE ANY NOMINAL CURRENT-CARRYING CIRCUIT WHICH IS DEFECTIVE OR GROUNDED AND HE SHALL ALSO CORRECT ALL OTHER TROUBLES ENCOUNTERED BY THESE TESTS. ALL DEFECTS WHETHER THROUGH FAULTY WORKMANSHIP OR MATERIAL FURNISHED SHALL BE CORRECTED UNDER THIS SECTION AT THE CONTRACTORS DEFENSE.
- 14. ALL ELECTRICAL WORK SHALL BE GLIARANTEED FOR A PERIOD OF ONE YEAR FROM DATE OF FINAL ACCEPTANCE. DEFECTS SHALL BE CORRECTED WITHOUT CHARGE, INCLUDING ALL PATCHING, PAINTING AND OTHER INCIDENTIAL REPAIRS AND REPLACEMENTS, COORDINATE ALL WORK WITH OTHER TROOS, FURNISH AND INSTALL ALL POWER AND CONTROL WIRING FOR A COMPLETE INSTALLATION.
- ALL ELECTRICAL EQUIPMENT, MATERIALS, ETC. STORED ON SITE SHALL BE STORED IN SUCH A MANNER THAT IT IS SAFE FROM DAMAGE BY MOISTURE, IMPACT, ETC.
- 16. CONTRACTOR SHALL PERFORM HIS WORK IN A NEAT AND ORDERLY WORKMANLIKE MANNER. ALL REFUSE, DIRT, AND DEBRIS RESULTANT FROM HIS WORK SHALL BE REMOVED AND PROPERLY DISPOSED OF AT THE CRO OF THE DAY.
- A. ALL WORK SHALL BE EXECUTED IN A WORKMANLIKE MANNER AND SHALL PRESENT A NEAT APPEARANCE WHEN COMPLETED, AND SHALL INCLUDE THE FURNISHING AND INSTALLATION OF A COMPLETE ELECTRICAL SYSTEM INCLUDING FOUNTAIN LIGHTING FIXTURES, DRIVER WIREWAYS, SUPPORTS, CONDUITS, WIRING, JUNCTION BUSES AND ALL OTHER NECESSARY APPURTENANCES REQUIRED FOR A COMPLETE OPERATIONAL FOUNTAIN LIGHTING SYSTEM
- THE CONTRACTOR IS RESPONSIBLE FOR FOLLOWING THE MANUFACTURER'S INSTALLATION RECOMMENDATIONS AND DIRECTIONS FOR ALL EQUIPMENT AND MATERIALS USED.
- 18. IF CONFLICTS ARISE FROM EQUIPMENT INSTALLATION, SCHEDULING, ETC., THESE SHALL BE RESOLVED AS DIRECTED BY THE OWNER TO THE ENTIRE SATISFACTION OF THE OWNER.
- 19. UPON COMPLETION OF THE WORK, THE CONTRACTOR SHALL BE REQUIRED TO DEMONSTRATE PROPER OPERATION OF THE LIGHTING SYSTEM AND EQUIPMENT IN THE PRESENCE OF THE OWNER AND THE ENGINEER PRIOR TO ACCEPTANCE BY THE OWNER.
- 20. ALL MATERIALS SHALL BE NEW (UNLESS OTHERWISE SPECIFIED ON THE DRAWINGS) AND SHALL COMPORM TO THE NEMA, MASSACHUSETTS ELECTRIC CODE (MEC) AND UNDERWINTERS LABORATORIES INC. STANDARDS IN EVERTY CASE WHERE SUCH A STANDARD HAS BEEN ESTABLISHED FOR THE PARTICULAR TYPE OF MATERIAL IN QUESTION.
- 21. ANY MATERIAL, ITEM OR WORK NOT SHOWN ON THE DRAWINGS BUT MENTIONED ON THE SPECIFICATIONS OR VICE-VERSA, OR ANY ACCESSORIES NECESSARY TO MAKE THE WORK COMPLETE IN ALL RESPECTS AND READY FOR OPERATION SHALL BE INCLUDED IN THE CONTRACTORS BID, AND SUCH ITEMS SHALL NOT BE A CAUSE FOR EXTRA WORK OR EXTRA COST TO
- 22. THE CONTRACTOR SHALL VISIT THE SITE TO MAKE HIMSELF AWARE OF THE EXISTING CONDITIONS AND EXISTING EQUIPMENT.
- 23. RECORD DRAWINGS
 - A. CONTRACTOR SHALL PREPARE A COMPLETE SET OF RECORD CONSTRUCTION DRAWINGS & SUBMIT THEM TO THE ENGINEER FOR APPROVAL.
- SUBMIT SHOP DRAWINGS AND PRODUCT DATA WITHIN 10 DAYS AFTER AWARD OF CONTRACT, CHECK, STAMP, AND MARK SUBMITTALS WITH PROJECT NAME BEFORE TRANSMITTING TO THE ENGINEER.
- 25. FINAL INSPECTION
 - A. WHEN THE WORK ON THIS PROJECT HAS BEEN COMPLETED AND IS READY FOR RINAL INSPECTION, SUCH INSPECTION WILL BE MADE. AT THIS TIME, THE CONTRACTOR FOR THE WORK OF THIS SECTION SHALL DEMONSTRATE THAT THE REQUIREMENTS OF THESE SPECIFICATIONS HAVE

IDAAAA	LICHTING CONSULTANTS	<u> — 11111111111111111111111111111111111</u>				
	LIGHTING CONSULTANTS CVW RLC JOB NUMBER: 170112	5175 HUS	1 2010 P4		(61)	(1) 489-3366 FAX(617) 489-5223 EMAIL: charlie@ripmanlighting.co
: IN BIDDING C	CWW RLC JOB NUMBER: 17011.2 OR ORDERING FIXTURES, LAMPS OR CONTROL EQUIPMENT, REFER TO FI	DATE: JAN 3		AL SPECIFIC	ATIONS (DIV 230000	AND 265000) FOR ADDITIONAL INFO + REQUIREMENTS SPECIFIC TO THIS
		PROJECT. INCLUDE ALL FIXT	TURES AND IN	STALLATION	IN BASE	
TYPE	GENERIC DESCRIPTION OF FIXTURE MANUFACTURER'S SPECIFICATION	(LOCATION)	LAMPING	LAMP WATTS	MOUNTING	NOTES, VOLTAGE
CD-1	DMX SHOW CONTROLLER WITH IMMECLOCX + SHOW DESIGN SOFTWARE ETC "UNISON MOSAIC" #MSC1 CONTROLLER + UNISON MOSAIC DESIGNER SOFT	WARSE (DRY VAULT)	N.A.	0		ONE DMX UNIVERSE CAPACHY. BUILT IN ASTRONOMICAL CLOCK REQUIRES A CONDITIONED ENVIRONMENT THERMAL RANGE 32-1/2 DEGREES F. RELATIVE HUM 1860N. ET. USTED 126W EC CARRYS HOURS OF ON-SITE COMMISSIONING TIME BY QUAUFIED FACTORY TRAINED INEGRATOR
CD-2	EIGHTBUTION CONTROL REYPAO ETG "UNISON MOSAIC" # M108-5US	(DRY VAULT)	N A	0		WHITE FINISH, ENGRAVED BUTTONS PER LEGEND, REQUIRES A CONDITIONED ENVIRONMENT, THERMAL RANGE 32 122 DEGREES F, RELATIVE HUMIDITY 10:50s USTED, 12W
CD-3	NETWORK SWITCH BLACK BOX 'GRGABITUINMAN AGED Po€+ SWITCH', ≠LPHO094-R2	(DRY VAULT)	N.A.	0		BLACK FINISH: SUPPORTS POWER OVER ETHERNET EIGHT PSE PORTS. 12-57V DC INPUT.
CD-4	HEATED WET LABEL ENCLOSURE SIZED FOR CONTROLS + DRIVERS AMERICAN PRODUCTS *MINIFORT #AMI-32822-1870 + WORTH AC UNIT #AMINFACK PRO #AMI-32822/RR RAILS #AMI-32822/RR	(OTY VAULT) IC RODV-119A + INSULATION ET #AM-2418-VMI + EXTRA	N.A.	0	WALL MOUNT ORY VAULT	SEE BARBIZON DRAWINGS FOR COMPLETE SPECIFICATION 32 HXX8 WXZZD. AIRCRAFT GRADE COGROSION RESISTANT ALUMINUM HOUSING WITH STAINLESS STEEL 304 HARDWARE GRAY GRAW POWERCOATPAINT (WINE) XIX QUAD RECEPT BY OR 20' EQUIPMENT RACKS. 7 POSITION ALUMI
CDS	24V DMX CON IROULED DRIVER ACCLAIM 'AQUIA DRIVER 157 #AOR 157	(ERY VAULT)	NA	0		1904 IUTAL QUIPUT. 3906 CONSTANT CURSENT QUIPUT. 4 PORTIS EACH 4 CHA OF CONTROL (IF CHANNELS TOTAL) DRY LOCATION RATED UNIVERSAL 100-2774 I EC PROVIDE ONE SPARE BEYOND COUNT FROM DRAININGS FOR OWNERS BACK STOCK
CD-7 (ADD ALT1)	VAR ROUTER - MODEM - ANTENNA CRADLEPOINT ≠ CORTISSROC SERIES	ORY VAULT + EXHAUST VENT)	N A	0	ANTENNA SURFACE MOUNT ROUTER • MODEM WITHIN ENCLOSURE	DO NOTINCLUDE IN BASE COSTESTIMATE PROVIDES THE CAPABUITT TO MAIN. SELECT SHOWS AND OVERSITE MISCLOCK SHOWS ELECTION, MIPHOLTOPEN HATCH AND DESCENDING INTO VAULTIO ACCESS BUTTON KEYPADS. ROUTER, MODEM IN GRY VAULT, ANTENNA LOCATED WITHIN N
UW1L	ZEPI LM VAHITE LED LIGHTIPBB FIXTURE, DMX CONTROLLABLE ACCIAIM 'AQUA DRIM'' #AQU-2814 CH-AR	(LIMOB REMOJI)	2700K LEO'S	36	SURFACE BRACKET MOUNT	7'S DIAMETER THRESUBMERSIBLE RATED FOR OPERATION ABOVE OR BELOWN. 318L MARKINE GRACE STAINLESS STEEL HOUSING WITH SEALED GLASS TOP ADJUSTABLE YOKE MOUNT. ** ** ** ** ** ** ** ** ** ** ** ** **
UW1M	1800 LM WHITE LED LIGHT IPGB FIXTURE, DAIX CONTROLLABLE	(MIDDLE BOWL)	2700K	18	SURFACE BRACKET	65 DIAMETER 1998 SUBMERSIBLE RATED FOR OPERATION ABOVE OR BELOWN
	ACCLAIN 'AQUA DRUM' #ACQ 2618-H-A-N	2	LED'S		MOLINT	3/B, MARINE GRADE STAINLESS STEEL HOUSING WITH SEALED GLASS TOP ADJUSTABLE YOKE MOUNT - #ODEGREE FLOOD DISTRIBUTION MODIFICATION: IF FEED CABLE FACTORY INSTALLED AND SEAL
UW1S	700 LM WHITE LED LIGHT 1998 FIXTURE DMX CONTROLLABLE ACCLAIM "AQUA DRUM" #AOD 261-A-H-A-N	(UPPER BOWL)	2700K IEDS	8	SURFACE BRACKET MOUNT	49 CHAMETER INVASUAMERSIBLE RATEO FOR OPERATION ABOVE OR BELOWY. 310, MARINE GRADE STAINLESS STEEL HOUSING WITH SEALED GLASS TOP ADJUSTABLE YOKE MOUNT ADDEGREE FLOOD DISTRIBUTION MOURICATION: 1 FEED CABLE FACTORY INSTALLED AND SEAL.
	MATERIAL	LS SCHEDULE				
M-2	SLOTTED STAINLESS STEEL STRUT	(FOUNTAIN BOWLS)	N A			SEE ELECTRICAL DRAWING R4, AND RIPMAN LIGHTING CONSULTANTS SKETCH
	B-JINE, UNISTRUTOR EQ			N A	IN MIDDLE AND UPPERBOWLS	DATED 23 JAN. 2019, FOR DETAILS: INTENT IS TO PROVIDE MOUNTING FOR FIXTU UPPER AND MIDDLE BOWLS. WITH LOADS TRANSFERRED TO FLOOR OF EACH BUT MITHOUT PUTTING PRESSURE ON, OR CONT
M-4	I'Z CLEAR POLYCARBONATE SHEET CYLINDRICAL TUBING J FREEMAN OR EQ	(LOWER BOW)	N A	N A	SHIELD OVER FIXTURES (LOWER BOWL)	SEE RIPMAN LIGHTING CONSULTANTS SKETCHES # LAND #2, DATED 28 JAN 20 DETAILS.



69 Beacon Street Boston, MA 02108 (617) 723-8144

N BREWER FOUNTAIN PLA FOUNTAIN LIGHTING RENOVATION

Massachusetts

Boston,

Common

Boston

NO.	DATE	REMARKS
1	DATE 11/8/18	VAULT COORDINATIN
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_		
_		
_		

RONALD W. BUIA, INC. **Electrical Engineers** 5 Tilton Lane Andover, MA 01810 TEL: 978.475.5184 RBUIA@BUIAENGINEERING.COM

DRAWING TITLE **Lighting Schedules** Details & Spec's

NORTH

DRAWN BY: KML CHECKED BY: RWB DATE: SCALE:

DRAWING NO. **R5** 2/5/19 NONE PROJECT NO.: 2380118